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**PROJECT DESCRIPTION**

THIS PERMIT IS FOR THE CONSTRUCTION OF A NEW (2) TWO STORY OFFICE BUILDING SHELL, INCLUDING A PEDESTRIAN BRIDGE FROM THE SECOND FLOOR TO THE ADJACENT PARKING LOT. BUILDING SHELL SHALL CONSIST OF RESTROOM CORES, ELEVATOR, ELECTRICAL SERVICE AND EXIT STAIRS. EXTERIOR BUILDING WALLS TO BE CONCRETE TILT-UP, SECOND FLOOR TO BE CONCRETE OVER STEEL DECKING AND ROOF TO BE BUILT-UP ROOFING OVER PLYWOOD SHEATHING.

**CABRILLO BUSINESS PARK  
BUILDING NO. 4  
HOLLISTER AVE. GOLETA, CA**

**STRUCTURAL OBSERVATION**

THE OWNER SHALL EMPLOY THE ENGINEER OR ARCHITECT RESPONSIBLE FOR THE STRUCTURAL DESIGN TO PERFORM STRUCTURAL OBSERVATION AS DEFINED IN SECTION 1702 OF THE CBC. THE ENGINEER OR ARCHITECT SHALL SUBMIT A STATEMENT IN WRITING TO THE SUPERINTENDENT OF THE BUILDING STATING THAT THE VISIT HAS BEEN MADE AND WHETHER OR NOT ANY DEFICIENCIES REPORTED HAVE BEEN RESOLVED.

THE CONTRACTOR SHALL NOTIFY THE ENGINEER AT THE FOLLOWING TIMES OF THE CONSTRUCTION OF THE PROJECT SO THAT STRUCTURAL OBSERVATION IS PERFORMED TO THE SATISFACTION OF THE BUILDING DEPT.:

- 48 HOURS PRIOR TO POURING CONCRETE FOUNDATIONS.
- 48 HOURS PRIOR TO POURING SLAB ON GRADE
- 48 HOURS PRIOR TO PLACEMENT OF CONCRETE IN THE TILT-UP WALL PANELS.
- 48 HOURS PRIOR TO PLACEMENT OF CONCRETE IN THE POUR STRIPS.
- 48 HOURS PRIOR TO PLACING OF ROOF MATERIAL FOR NAILING OBSERVATION.
- AFTER THE INSTALLATION OF THE ROOF FRAMING ANCHORAGE SYSTEM AND ALL HARDWARE.

NOTE: CONTRACTOR SHALL PROVIDE A MECHANICAL LIFT FOR ALL INSPECTIONS 10'-0".

A GRADING PERMIT IS REQUIRED FOR THIS PROJECT.

THE CONTRACTOR SHALL CALL THE ENGINEER TO INSPECT THE LIGHT GAUGE METAL FRAMING AND BRACING CONSTRUCTION AND SHALL CORRECT ANY DEFICIENCIES OR ADD ANY NECESSARY FASTENERS OR MEMBERS PER ENGINEER'S INSTRUCTION PRIOR TO INSTALLATION OF ANY COVERING OR CEILING TILES.

**FOR ADDITIONAL NOTES SEE ABBREVIATION AND LEGEND SHEET A-0.1**

**SPECIAL INSPECTION AND TEST SCHEDULE (REQUIRED BY THE CBC AND UNIFORM CODE STANDARDS)**

1.A. SOILS:  
1.A.1 SITE PREPARATION, GRADING, PLACING OF ENGINEERED FILL.

1.B. GROUND SLAB  
1.B.1 CONCRETE PLACEMENT (fc=4000 PSI)

1.C. FOUNDATIONS  
1.C.1 REINFORCEMENT SIZE AND SPACES.  
1.C.2 PLACING OF REINFORCED CONCRETE

1.C. CONCRETE TILT-UP WALL PANELS  
1.D.1 CONCRETE PLACEMENT (fc=4000 PSI)  
1.D.2 ALL FIELD WELDING (BASE PLATES, LEDGER, DRAG CONN., ETC)

1.D. ROOF STEEL  
1.E.1 ALL FIELD WELDING (LEDGER TRUSSES, DRAG CONNECTION, ETC)

1.F. FLOOR STEEL  
1.F.1 ALL FIELD WELDING (LEDGER, TRUSSES, DRAG CONNECTION, DECK E.R.)

1.G. POUR STRIP  
1.F.1 CONCRETE PLACEMENT (fc=4000 PSI)

ADDITIONAL WORK IF REQUIRED DURING CONSTRUCTION  
A. ALL EPOXY APPLICATION  
B. ALL FIELD WELDING NOT NOTED ABOVE  
C. ALL CONCRETE PLACEMENT GREATER THAN 2500 PSI

2. A COPY OF ALL SPECIAL INSPECTION REPORTS SHALL BE PROVIDED TO THE CITY INSPECTOR AND THE ARCHITECT AT COMPLETION OF EACH INSPECTION.

3. ANY DISCREPANCIES OR QUESTIONS DETERMINED BY THE SPECIAL INSPECTOR SHALL BE DIRECT TO THE CONTRACTOR

**SPECIAL INSPECTION SERVICE**

LORCO, INC WAYNE COX (805) 655-6930  
BTC (805) 656 - 6074  
EARTH SYSTEMS (805) 642 - 6727  
DEPUTY INSPECTION SERVICES (818) 349 - 1806  
ACCUTECH CONSTRUCTION INSPECTION (805) 492 - 3455  
EMIS DEPUTY BUILDING INSPECTIONS (909) 272 - 9721  
MJK INSPECTION SERVICES (626) 852-0180

**DEFERRED SUBMITTALS**

(3) THREE COPIES OF THE DEFERRED SUBMITTAL DOCUMENTS SHALL BE SUBMITTED TO THE ARCHITECT-OF-RECORD or the ENGINEER-OF-RECORD, WHO SHALL REVIEW THEM AND FORWARD THEM TO THE BUILDING OFFICIAL WITH A NOTATION THAT THEY HAVE BEEN REVIEWED AND HAVE BEEN FOUND TO BE IN GENERAL CONFORMANCE WITH THE DESIGN OF THE BUILDING or STRUCTURE. THE DEFERRED ITEMS SHALL NOT BE INSTALLED UNTIL THEIR DESIGN AND SUBMITTAL DOCUMENTS HAVE BEEN REVIEWED AND APPROVED BY THE BUILDING OFFICIAL.

**DEFERRED ITEMS:**

- STEEL JOISTS AND JOIST GIRDERS (2ND. FLOOR AND ROOF). FABRICATOR TO PROVIDE LOADING DIAGRAMS SHOWING DESIGN LOAD USED FOR DESIGN AND DIMENSION (LOAD SHALL INCLUDE ALL POINT LOADS AND UNIFORM LOADS).
- STOREFRONT AND EXTERIOR GLAZING.
- PREFABRICATED ROOF MOUNTED EQUIPMENT SCREEN BY ROOF SCREEN MANUFACTURING OR FABRICATED SCREENS AS SHOWN ON DETAILS 4/D-9.1 & 4/D-9.1A.
- GLASS GUARDRAILS.
- BUILT-UP ROOFING MATERIAL.

**PROJECT REPRESENTATIVES**

**PROJECT OWNER:**  
SARES-REGIS GROUP  
500 ESPLANADE DR, SUITE 470  
OXNARD, CA. 93030  
PHONE: (805)-983-3456  
FAX: (805)-983-6974  
CONTACT: STEVE FEDDE

**CIVIL ENGINEER:**  
PENFIELD AND SMITH  
111 EAST VICTORIA STREET  
VENTURA, CA 93101  
PHONE: (805) 963-9532  
FAX: (805) 966-9801  
CONTACT: DON DONALDSON, P.E.

**DEVELOPMENT PROCESSING:**  
DUDEK  
621 CHAPALA STREET  
SANTA BARBARA, CA 93101  
PHONE: (805) 963-0651 EXT. 3528  
FAX: (805) 963-2074  
CONTACT: TROY WHITE, A.I.C.P.

**MECHANICAL ENGINEER:**  
MOON ENGINEERING  
1304 E. MAIN STREET, SUITE "F"  
VENTURA, CA 93001  
PHONE: (805) 653-5215  
FAX: (805) 653-0802  
CONTACT: TIM MOON, P.E.

**DESIGN ARCHITECT:**  
KITABAYASHI DESIGN STUDIO  
1227 JF STREET  
SAN DIEGO, CA 92101  
PHONE: (619) 232-9116 EXT. 201  
FAX: (619) 232-9045  
CONTACT: DEREK KITABAYASHI

**ELECTRICAL ENGINEER:**  
SILVER ENGINEERING  
7543 WOODLEY AVE., SUITE 100  
VAN NUYS, CA 91406  
PHONE: (818) 786-6900  
FAX: (818) 786-4400  
CONTACT: MICHAEL SILVER, P.E.

**ARCHITECT / STRUCTURAL ENGINEERING:**  
JDO / Dyer, L.L.P.  
5376 N. STERLING CENTER DRIVE  
WESTLAKE VILLAGE, CA. 91361  
PHONE: (818) 708-3997 EXT. 15  
FAX: (818) 706-2453  
CONTACT: GREG SODETANI


**SITE LIGHTING:**  
SMITH ENGINEERING ASSOC.  
PHONE: (805) 966-2877 EXT. 2  
FAX: (805) 966-2628  
CONTACT: BRIAN SMITH, P.E.

**GEOTECHNICAL:**  
PADRE ASSOCIATES, INC.  
1861 KNOLL DRIVE  
VENTURA, CA 93003  
PHONE: (805) 644-2220 EXT. 11  
FAX: (805) 644-2050  
CONTACT: JEFF DAMRON, P.E.

**LANDSCAPE ARCHITECT:**  
ARCADIA STUDIO.  
202 E. COTA STREET  
SANTA BARBARA, CA 93101  
PHONE: (805) 962-9055 EXT. 26  
FAX: (805) 962-5658  
CONTACT: LAURIE ROMANO

**REVISIONS**

△

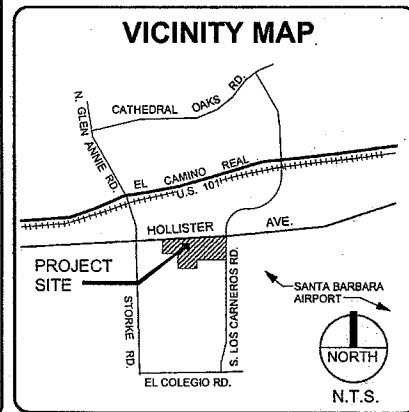

**BUILDING NO. 4 SUMMARY / AREA JUSTIFICATION**

DESIGN CODE: 2007 CALIFORNIA BUILDING CODE (CBC) WITH LOCAL AMENDMENTS, 2007 CALIF. PLUMBING CODE, 2007 CALIF. MECHANICAL CODE AND 2007 CALIFORNIA ELECTRICAL CODE (2005 NEC).

OCCUPANCY: B

TYPE OF CONSTRUCTION: III - B

BUILDING AREA  
1ST. FLOOR: 29,970 SQ. FT. (OFFICE / B - OCCUPANCY)  
2ND. FLOOR: 28,652 SQ. FT. (NET-LESS FLOOR OPENING'S) (OFFICE / B - OCCUPANCY)  
TOTAL FLOOR AREA: 58,622 SQ. FT. (NET)

BUILDING HEIGHT: 34'-0"

FIRE SUPPRESSION: FULLY SPRINKLERED (AUTOMATIC)

STORIES: TWO (2) STORIES

ALLOWABLE AREA FOR SPRINKLERED BLDG.: UNLIMITED BUILDING AREA FULLY SPRINKLERED W/ 4 - 60'-0" WIDE SIDE YARDS (CBC 507.4)

OPEN SPACE INCREASE: N.A.

FIRE SPRINKLER INCREASE: N.A.

OCCUPANT LOAD: 1ST. FLR. = 276  
2ND. FLR. = 258  
TOTAL OCC. 534

EXITS REQUIRED: 2ND. FLR.: 2 REQUIRED  
1ST. FLR.: 2 REQUIRED



CORRIDOR RATING: N.A.

MAX. TRAVEL DISTANCE: 300 FEET

EXIT SEPARATION: SEE EXIT PLANS SHEETS A-6 AND A-9

EXIT AND CORRIDOR WIDTHS: SEE EXIT PLANS SHEETS A-6 AND A-9

DRAFTSTOPS: N.A.

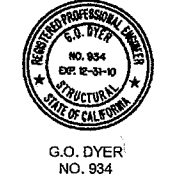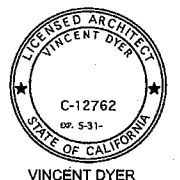

**PARKING INFORMATION**

STALLS PROVIDED: 174 STALLS  
TOTAL DISABLED ACCESS STALLS PROVIDED: 6 STALLS  
TOTAL STALLS PROVIDED: 180 STALLS (3:1,000)  
BICYCLE RACKS: 1 - (6) POSITION RACK AND (4) STORAGE LOCKERS

8?

✓ sheets say 3?


**PLANNING INFORMATION**

GOLETA COMMUNITY PLAN  
COUNTY OF SANTA BARBARA INLAND ZONING ORDINANCE ARTICLE III OF CHAPTER 35

ASSESSOR'S PARCEL NUMBER: 073-610-006  
TOTAL ACRES: 73.02 GROSS ACRES  
EXISTING ZONING: M-RP / M-S-GOL  
PROPOSED ZONING: M-RP / M-S-GOL  
EXISTING GENERAL PLAN DESIGNATION: COUNTY: INDUSTRIAL PARK / LIGHT INDUSTRIAL (CITY: BUSINESS PARK / SERVICE INDUSTRIAL)  
PROPOSED GENERAL PLAN DESIGNATION: COUNTY: INDUSTRIAL PARK / LIGHT INDUSTRIAL (CITY: BUSINESS PARK / SERVICE INDUSTRIAL)

SERVICE AGENCIES:  
FIRE PROTECTION: SANTA BARBARA COUNTY FIRE DEPARTMENT  
SANITARY SEWER DISTRICT: GOLETA WEST SANITARY DISTRICT  
WATER DISTRICT: GOLETA WATER DISTRICT  
SCHOOL DISTRICT: GOLETA UNIFIED SCHOOL DISTRICT  
GAS: SOUTHERN CALIFORNIA GAS COMPANY  
ELECTRIC: SOUTHERN CALIFORNIA EDISON  
TELEPHONE: GENERAL TELEPHONE COMPANY (GTE)  
CABLE T.V.: COX CABLE

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Date: 11-18-09  
Job: 0904  
**A-0.0**

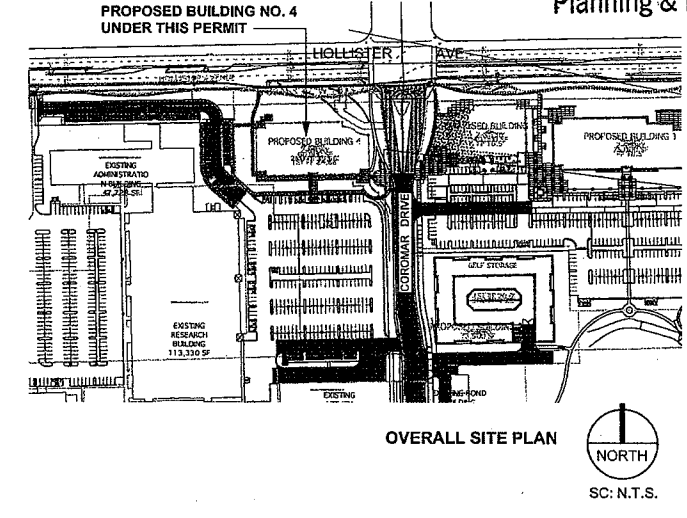**DESIGN PROFESSIONAL IN RESPONSIBLE CHARGE**

- THE DESIGN PROFESSIONAL IN RESPONSIBLE CHARGE, SHALL BE VINCENT DYER (A REGISTERED ARCHITECT). HE SHALL BE RESPONSIBLE FOR REVIEWING AND COORDINATING SUBMITTAL DOCUMENTS PREPARED BY OTHER ENGINEERS, INSPECTORS AND TESTING AGENCIES REQUIRED DURING CONSTRUCTION.
- THE BUILDING OFFICIAL SHALL BE NOTIFIED IN WRITING, BY THE OWNER, IF THE REGISTERED DESIGN PROFESSIONAL IN RESPONSIBLE CHARGE IS CHANGED OR IS UNABLE TO CONTINUE TO PERFORM THE DUTIES.

**STATEMENT OF SPECIAL INSPECTION**

- THE OWNER SHALL EMPLOY ALL SPECIAL INSPECTORS REQUIRED FOR THIS PROJECT PER SECTION 1704 OF THE 2007 CALIFORNIA BUILDING CODE (CBC).
- THE INSPECTOR SHALL BE A QUALIFIED PERSON, WHO SHALL BE APPROVED BY THE CITY PRIOR TO CONDUCTING ANY INSPECTION.
- THE INSPECTOR SHALL FURNISH INSPECTION REPORTS TO THE OWNER, THE CONTRACTOR, THE CITY INSPECTOR AND THE ENGINEER OF RECORD.
- REPORTS SHALL INDICATE THAT THE WORK INSPECTED WAS DONE IN CONFORMANCE TO THE APPROVED CONSTRUCTION DOCUMENTS. ANY DISCREPANCIES SHALL BE BROUGHT TO THE IMMEDIATE ATTENTION OF THE CONTRACTOR FOR CORRECTION. IF THE DISCREPANCIES ARE NOT CORRECTED, THE DISCREPANCIES SHALL BE BROUGHT TO THE ATTENTION OF THE BUILDING OFFICIAL AND THE ENGINEER OF RECORD PRIOR TO THE COMPLETION OF THAT PHASE OF THE WORK.
- A FINAL REPORT DOCUMENTING THE INSPECTIONS SHALL BE ISSUED BY EACH SPECIAL INSPECTOR, WHICH SHALL SUMMARIZE ALL INSPECTIONS CONDUCTED DURING THAT PHASE OF WORK AND NOTE ALL DISCREPANCIES AS RESOLVED OR INCOMPLETE. THIS REPORT SHALL BE PROVIDED TO THE OWNER, THE CONTRACTOR, THE BUILDING OFFICIAL AND THE ENGINEER OF RECORD.
- THE FOLLOWING ITEMS SHALL REQUIRE SPECIAL INSPECTION:
  - ALL WELDING OF STEEL. (CONTINUOUS INSPECTION PER AWS D1.1). WELDING SHALL BE DONE BY A WELDER CERTIFIED BY THE CITY AND ALL SHOP WELDING SHALL BE DONE IN A CITY APPROVED AND LICENSED SHOP.
  - CONCRETE WORK (GREATER THAN  $f_c=2500$  PSI)
    - REINFORCING STEEL PLACEMENT. (PERIODIC, PER ACI 318: 3.5, 7.1-7.7)
    - REINFORCING STEEL WELDING. (CONTINUOUS, PER AWS D1.4 & ACI 318: 3.5.2)
    - VERIFYING USE OF REQUIRED DESIGN MIX. PERIODIC, PER ACI 318: CH. 4.5.2-5.4 & IBC SECTION 1904.2.2, 1913.2 1913.3)
    - AT THE TIME FRESH CONCRETE IS SAMPLED TO FABRICATE SPECIMEN FOR STRENGTH TEST, PERFORM SLUMP AND AIR CONTENT TEST AND DETERMINE THE TEMPERATURE OF THE CONCRETE. (CONTINUOUS, PER ASTM C172, ASTM C31 & ACI 318, 5.6, 5.8)
    - INSPECTION FOR MAINTENANCE OF SPECIFIED CURING TEMPERATURE AND TECHNIQUES. (PERIODIC, PER ACI 318: 5.11-5.13 & IBC SECTION 1913.9)
    - ERECTION OF PRECAST CONCRETE MEMBER (PERIODIC, ACI 318: CH16)
    - INSPECTION FORM WORK FOR SHAPE, LOCATION AND DIMENSIONS OF THE CONCRETE MEMBER BEING FORMED. (PERIODIC, ACI 318: 6.1.1)
  - COMPONENTS OF THE SEISMIC FORCE RESISTING SYSTEM: (PERIODIC INSPECTION SHALL BE COVERED BY THE ENGINEER OF RECORD DURING STRUCTURAL OBSERVATION)
    - ANCHOR BOLT(S)
    - ROOF AND FLOOR FRAMING (DRAG BEAM(S) AND CONNECTIONS(S))
    - ROOF AND FLOOR DIAPHRAGM CONSTRUCTION
- EACH CONTRACTOR RESPONSIBLE FOR CONSTRUCTION OF A COMPONENT OF THE SEISMIC OR WIND FORCE RESISTING SYSTEM AS NOTED ABOVE IN THE ITEMS REQUIRING SPECIAL INSPECTION SHALL SUBMIT A WRITTEN STATEMENT OF RESPONSIBILITY TO THE BUILDING OFFICIAL, THE OWNER AND THE ENGINEER OF RECORD PRIOR TO COMMENCEMENT OF WORK ON THE SYSTEM. PROVIDE A SIGNED DOCUMENT PRIOR TO PERMITS.

**STRUCTURAL OBSERVATION NOTE**

- THE OWNER SHALL EMPLOY THE ENGINEER REGISTERED AND LICENSED IN THE STATE OF CALIFORNIA WHO IS RESPONSIBLE FOR THE STRUCTURAL, DESIGN TO DO STRUCTURAL OBSERVATIONS.
- THE ENGINEER OF RECORD IS G.O. DYER, SE NO. 934, SHALL PERFORM THE STRUCTURAL OBSERVATIONS.
- NOT USED.
- THE ENGINEER RESPONSIBLE FOR THE STRUCTURAL OBSERVATIONS, THE CONTRACTOR AND ALL APPROPRIATE SUBCONTRACTORS SHALL HOLD A "PRE CONSTRUCTION MEETING TO REVIEW THE DETAILS OF THE STRUCTURAL ITEMS/ELEMENTS TO BE OBSERVED.

**ELEMENTS TO BE OBSERVED**

- FOUNDATION AND PANELS**  
THE FOLLOWING ITEMS SHALL BE OBSERVED BY THE STRUCTURAL OBSERVER PRIOR TO PLACEMENT OF CONCRETE:  
SLAB AND FOOTING REINFORCEMENT  
PANEL REINFORCEMENT
- HORIZONTAL DIAPHRAGM**  
THE FOLLOWING ITEMS SHALL BE OBSERVED BY THE STRUCTURAL OBSERVER PRIOR TO COVERING THE ROOF DIAPHRAGM OR THE FLOOR DIAPHRAGM:  
ROOF DIAPHRAGM NAILING  
STRAPS AND DRAG CONNECTIONS  
FLOOR DECK WELDS
- FRAMING**  
THE FOLLOWING ITEMS SHALL BE OBSERVED BY THE STRUCTURAL OBSERVER PRIOR TO COVERING FRAMING ELEMENTS OF THE STRUCTURE:  
ROOF AND FLOOR FRAMING.

- FINAL OBSERVATION**  
THE FOLLOWING ITEMS SHALL BE OBSERVED BY THE STRUCTURAL OBSERVER PRIOR TO COVERING STRUCTURAL FRAMING:  
ALL OBSERVED DEFICIENCIES FROM PRIOR OBSERVATIONS SHALL BE OBSERVED FOR COMPLETENESS.
- THE DESIGNATED STRUCTURAL OBSERVER SHALL SUBMIT REPORTS USING THE BUILDING AND SAFETY PRESCRIBED FORM.
  - DURING THE COURSE OF CONSTRUCTION, THE ENGINEER / ARCHITECT SHALL VISUALLY REVIEW THE STRUCTURAL SYSTEM FOR GENERAL CONFORMANCE WITH THE APPROVED PLANS. ANY OBSERVED DEFICIENCIES SHALL BE REPORTED IN WRITING, TO THE OWNER'S REPRESENTATIVE, TO CONTACTOR AND THE BUILDING DEPARTMENT.
  - SEPARATE OBSERVATIONS AND REPORTS ARE REQUIRED FOR EACH ELEMENT OF THE STRUCTURAL OBSERVATION PROGRAM. THE ELEMENT OBSERVATION REPORTS MUST BE RECEIVED BY BUILDING AND SAFETY BEFORE THE BUILDING AND SAFETY INSPECTION OF THAT ELEMENT.
  - PRIOR TO COVERING THE WORK, THE STRUCTURAL SYSTEM SHALL BE INSPECTED AND APPROVED BY BUILDING AND SAFETY INSPECTION STAFF ASSIGNED TO THE PROJECT. SUCH APPROVAL BY THE DEPARTMENT IS REQUIRED PRIOR TO COVERING. THE ENGINEER / ARCHITECT PERFORMING THE STRUCTURAL OBSERVATION IS NOT AUTHORIZED TO APPROVE THE COVERING OF THE STRUCTURAL SYSTEM. HIS / HER STRUCTURAL OBSERVATIONS ARE ADVISORY ONLY AND THEY DO NOT IN ANY WAY BIND THE DEPARTMENT OR CONSTITUTE A CERTIFICATION THAT THE STRUCTURAL SYSTEM WILL PASS BUILDING AND SAFETY INSPECTION. NOR DO THEY SUBSTITUTE FOR ANY REQUIRED DIVISION OF BUILDING AND SAFETY INSPECTION.

**WALL LEGEND**

- CONC. TILT-UP EXTERIOR WALL OR INTERIOR SHEAR WALL, TYP.
- CONC. TILT-UP WALL W/ 3 5/8" METAL FURRING STUDS AT 16" O.C. (SEE NOTE #11B / D-3 AND ONE LAYER OF 5/8" TYPE "X" GYP. BD. AND INSULATION, TYP.
- CONC. TILT-UP WALL W/ 7/8" METAL FURRING STUDS AT 16" O.C. ONE LAYER OF 5/8" TYPE "X" GYP. BD., TYP.
- METAL STUD WALL (STANDARD) METAL STUDS AT 16" O.C. (SEE NOTE #11B / D-3) W/ ONE LAYER OF 5/8" TYPE "X" GYP. BD. EA. SIDE AND INSULATION.
- METAL STUD WALL (ELEVATOR SHAFT) METAL STUDS AT 16" O.C. (SEE NOTE #11B / D-3) W/ TWO LAYERS OF 5/8" TYPE "X" GYP. BD. EA. SIDE AND INSULATION.
- 8" THK. STANDARD CMU WALL (ELEVATOR EQUIP. RM.)
- MECHANICAL CHASE WALLS (50 TO 54 STC)  
ONE LAYER 1" x 24" PROPRIETARY TYPE "X" GYP. BD. INSERTED BETWEEN 4' FLOOR AND CEILING "J" RUNNERS W/ "H" SECTION OF 4" PROPRIETARY VENTED "C-H" STEEL STUDS BETWEEN PANELS. 3" PROPRIETARY MINERAL FIBER INSULATION, 2.0 PCF IN STUD CAVITY. OPPOSITE SIDE: ONE LAYER 3/4" PROPRIETARY TYPE "X" GYP. BD. APPLIED PARALLEL TO STUDS W/ 1 1/4" TYPE "S" DRYWALL SCREWS 8" O.C. AT EDGES AND ENDS AND 12" O.C. AT INTERMEDIATE STUDS (GA FILE NO. WP 7053)

**METAL STUD PRODUCT IDENTIFICATION CODE**

CEMCO (ICC-ESR 2012)  
DEFINITION: ECS OR HDS FLANGE = 1.25" CS OR XHD FLANGE = 1.625"  
XCS OR XXHD FLANGE = 2.00"

THE CONTRACTOR SHALL INQUIRE FROM JDO/Dyer, LLP OR CONSULT THE I.C.C. REPORTS FOR ANY CLARIFICATION PRIOR TO ORDERING AND INSTALLING METAL STUDS & JOISTS. THE FINAL ACCEPTANCE OF ANY ERRORS IN CONSTRUCTION IS WITH ENGINEER-OF-RECORD. SUBCONTRACTOR SHALL PROVIDE SHOP DRAWINGS FOR METAL STUD FRAMING THAT HAS A DIFFERENT I.C.C. NUMBER THAN ABOVE.

**SYMBOLS**

- COLUMN OR BUILDING GRID LINE
- DETAIL NUMBER REFERENCE
- SHEET NUMBER REFERENCE
- SECTION OR ELEVATION NUMBER REFERENCE
- SHEET NUMBER REFERENCE
- FOOTING TYPE (SEE FOOTING SCHEDULE)
- DOOR NUMBER (SEE DOOR SCHEDULE)
- WINDOW TYPE (SEE WINDOW SCHEDULE)
- ROOM NUMBER (SEE FINISH SCHEDULE)
- KEY NOTE (SEE KEY NOTE LEGEND)
- REVISION TO DRAWING

**TYPICAL INTERIOR NOTES**

- LADDER TO ROOF HATCH - COORDINATE EXACT LOCATION OF LADDER AND WALL WITH ROOF FRAMING PLAN.
- SEE SHEET D-4 FOR DOOR SCHEDULE AND INTERIOR FINISH SCHEDULE.
- SEE SHEETS ADA-1 THROUGH ADA-5 FOR TYPICAL DISABLED ACCESS NOTES AND DETAILS.
- PROVIDE R-11 INSULATION IN ALL INTERIOR WALLS AND R-19 AT THE UNDERSIDE OF THE ROOF STRUCTURE.
- SEE NOTE #11B / D-3 FOR METAL STUD SIZES.
- LOW NOx WATER HEATERS, SPACE HEATERS AND DEMAND WATER HEATERS SHALL BE USED.
- LAVATORIES SHALL HAVE AUTOMATIC SENSOR FAUCETS WITH SELF-CLOSING VALVES.
- DRINKING FOUNTAINS SHALL HAVE SELF-CLOSING VALVES.
- ALL PLUMBING FIXTURES SHALL BE "LOW-FLOW" TYPE.
- INTERIOR FINISH MATERIALS APPLIED TO WALLS AND CEILINGS SHALL BE TESTED AS SPECIFIED IN SECTION 802 OF THE 2007 CBC. SEE ALSO TABLE AT RIGHT.

INTERIOR WALL AND CEILING FINISH CLASSIFICATION REQUIREMENTS FOR FIRE SPRINKLERED BUILDING'S			
GROUP	EXIT ENCLOSURES AND PASSAGEWAYS a,b	CORRIDORS	ROOMS AND ENCLOSED SPACES c
B	B	C	C

- Class "C" interior finish materials shall not be permitted for wainscoting or paneling of not more than 1,000 sq. ft. of applied surface area in the grade lobby where applied directly to a noncombustible base or over furring strips applied to a noncombustible base and fireblocked as required by Sect. 803.4.1 of the CBC.
- In exit enclosures of buildings less than three stories in height of other than Groups I-3, Class "B" interior finish for nonsprinklered buildings and Class "C" interior finish for sprinklered buildings shall be permitted.
- Requirements for rooms and enclosed spaces shall be based upon spaces enclosed by partitions. Where a fire-resistance rating is required for structural elements, the enclosing partitions shall extend from the floor to the ceiling. Partitions that do not comply with this shall be considered enclosing spaces and the rooms or spaces on both sides shall be considered one. In determining the applicable requirements for rooms and enclosed spaces, the specific occupancy thereof shall be the governing factor regardless of the group classification of the building or structure.

**ABBREVIATIONS**

& L	AND ANGLE	F.S.	FLOOR SINK or FULL SIZE or FINISH SURFACE	PLYWD. PR.	PLYWOOD PAIR
@	AT	F.S.R.	FIRE SPRINKLER RISER	PT.	POINT
DIA. or Ø	DIAMETER OR ROUND	FT.	FOOT OR FEET	PTD.	PAPER TOWEL DISPENSER
#	POUND OR NUMBER	FTG.	FOOTING	PWMT.	PAVEMENT
A.B.	ANCHOR BOLT	FURR.	FURRING	P.MET.	PRESSED METAL
A.C.	ASPHALTIC CONCRETE				
A/C	AIR CONDITIONING				
ACOUS.	ACOUSTICAL				
A.C.T.	ACOUSTICAL CEILING TILE				
A.D.	AREA DRAIN	G	GIRDER		
A.D.A.	AMERICANS WITH DISABILITIES ACT/GALV. ADJUSTABLE or	G.B.	GALVANIZED GRAB BAR or GYP. BOARD	R.	RISER, RADIUS
ADJ.	ADJACENT	G.C.	GENERAL CONTRACTOR	R.A.	RETURN AIR
		G.I.	GALVANIZED IRON	RAD.	RADIUS
A.F.F.	ALUM. ABOVE FINISH FLOOR	GL.	GLASS	R.B.	ROOF BEAM
ALUM.	ALUMINUM	GR.	GRADE	R.D.	ROOF DRAIN
APPROX.	APPROXIMATE	GRD.	GROUNDED	REFRIG.	REFRIGERATION or REFRIGERATOR
ARCH.	ARCHITECTURAL	G.S.	GALVANIZED STEEL	REF.	REFERENCE
A.S.R.	AUTOMATIC SPRINKLER RISER	GYP.	GYP. BOARD	REFIN.	REFINISHED
				REQ'D	REQUIRED
				RM.	ROOM
				RESIL.	RESILIENT
				R.G.	ROOF GIRDER
BETW.	BETWEEN	H.	HORIZONTAL	S. or SK.	SINK
BD.	BOARD	H.B.	HOLLOW CORE	SO.	SOUTH
BLDG.	BUILDING	H.C.	HEAD CORE	S.A.	SUPPLY AIR
BLK.	BLOCK	HDR.	HARDWARE	S.C.	SOLID CORE
BLKG.	BLOCKING	HDW.	HARDWARE	S.D.	SCUPPER DRAIN or SCURPER DRAIN
BM.	BEAM	HDWD.	HARDWOOD	SECT.	SECTION
BOTT.	BOTTOM	HT.	HEIGHT	SHT.	SHEATHING
BTR.	BETTER	H.M.	HOLLOW METAL	SIM.	SIMILAR
		H.P.	HORSE POWER or HIGH POINT	SL.	SLIDING or SCORE LINE
		HR.	HEATING VENTILATION and AIR CONDITIONING	SPEC.	SPECIFICATION
		HRVAC	HVAC	SQ.	SQUARE
				STA.	STATION
				STD.	STANDARD
				STL.	STEEL
				STOR.	STORAGE
				STRUCT.	STRUCTURAL
				S.S.	SERVICE SINK or STAINLESS STEEL
				SUSP.	SUSPENDED
				SWBD.	SWITCHBOARD
				SYM.	SYMMETRICAL
				TRANSFMR.	TRANSFORMER
				TRANSF.	TRANSFER
				TR.	TREAD
				T.A.	TREE AREA
				T.B.	TACK BOARD
				T.B.D.	TO BE DETERMINED
				T & B	TOP AND BOTTOM
				T.O.C.	TOP OF CONCRETE
				T.O.C.H.	TOP OF CURB
				T.O.C.M.	TOP OF CATCH BASIN
				TELE.	TELEPHONE
				THK.	THICK
				T.O.M.	TOP OF MASONRY
				T.O.P.	TOP OF PARAPET
				T.O.S.	TOP OF SHEATHING or TOP OF STEEL
				T.P.D.	TOILET PAPER DISPENSER
				T.V.	TELEVISION
				T.O.W.	TOP OF WALL
				TYP.	TYPICAL
				T.J.	TOOL JOINT
				U.O.N.	UNLESS OTHERWISE NOTED
				UR.	UNLESS NOTED OTHERWISE URINAL
				V.C.T.	VINYL COMPOSITION TILE
				VERT.	VERTICAL
				V.I.F.	VERIFY IN FIELD
				V.	VERTICAL
				W.	WEST
				W/	WITH
				W.C.	WATER CLOSET
				WD.	WOOD
				W.F.	WIDE FLANGE
				W.H.	WATER HEATER
				W.P.	WEATHERPROOF or WATERPROOF
				WT.	WEIGHT

**ABBREVIATIONS**

ROOF LOADS: DL = 18 PSF LL = 20 PSF FLOOR LOADS: DL = 46 PSF LL = 85 PSF

SEISMIC  
S<sub>s</sub> = 1.67 S<sub>i</sub> = 0.64

SITE CLASS: E  
SEISMIC CATEGORY: D  
SEISMIC FORCE RESISTING SYSTEM / BEARING WALL, INTERMEDIATE PRECAST SHEAR WALLS  
ANALYSIS PROCEDURE: EQUIVALENT LATERAL FORCE PROCEDURE  
REDUNDANCY FACTOR: 1.3

WIND FACTORS:  
V<sub>S</sub> = 85 MPH  
IMPORTANCE FACTOR: 1.0  
EXPOSURE CATEGORY: C  
BUILDING HEIGHT: 35'-0"  
EXPOSURE ADJUSTMENT COEFFICIENT: 1.45  
WORST CASE DESIGN WIND PRESSURE USED FOR DESIGN: 19.6 PSF UNIFORM

**JDO Dyer**  
Architecture | Engineering  
5376 N. Sterling Center Drive  
Westlake Village, CA 91361  
Phone 818. 706. 3997  
Fax 818. 706. 2453

**VINCENT DYER**  
C-12762  
EX-531  
STATE OF CALIFORNIA  
REGISTERED ARCHITECT

**G.O. DYER**  
NO. 934  
EX-12-31-10  
STATE OF CALIFORNIA  
REGISTERED PROFESSIONAL ENGINEER

Revisions

**CABRILLO BUSINESS PARK BUILDING NO. 4**  
HOLLISTER AVE  
GOLETA, CA

**ABBREVIATIONS AND SYMBOLS**


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Job: 0904  
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Sheet:

**A-0.1**




NOTE:  
 THE ALUMINUM STOREFRONT SYSTEM SHALL BE A DEFERRED, TO INCLUDE ALL DOORS AND WINDOWS. SUBMITTAL THE CONTRACTOR SHALL SUBMIT SHOP DRAWINGS TO THIS OFFICE FOR REVIEW PRIOR TO SUBMITTING TO BUILDING AND SAFETY. THE SUBMITTAL SHALL INCLUDE:  
 1. DESIGN CALC'S AND DETAILS FOR GLAZING HEIGHTS 8'-0" AND ABOVE.  
 2. SHOW COMPLIANCE TO SECTIONS 2403.2 AND 2403.3 OF THE 2007 CBC.  
 3. DESIGN PER ASCE 7, SECTION 13.5.9 AND ASTM E 1300. SEE EQUATION 24-1 [2404].  
 4. PROVIDE DETAILS AND CALC'S FOR OUT OF PLANE SUPPORTING SYSTEMS.

MAXIMUM "U" VALUE OF GLAZING TO BE 0.57, TYP.  
 ALL VISION GLAZING TO MEET ENERGY REQUIREMENTS.

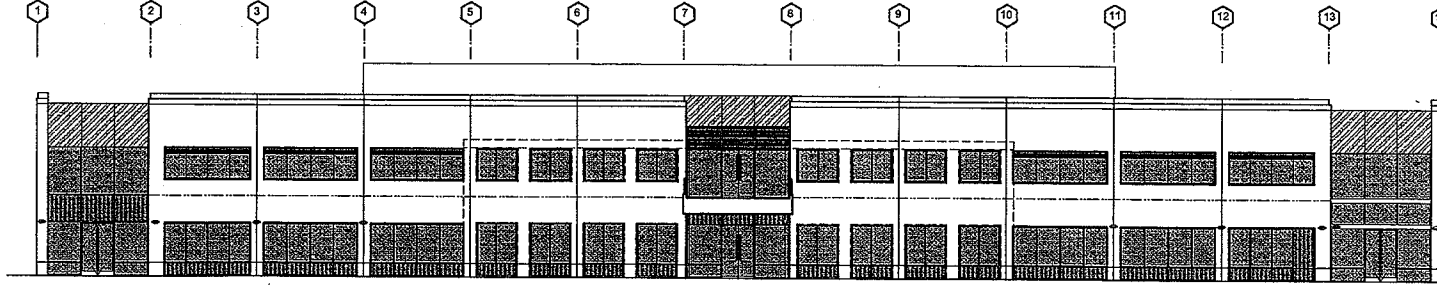

**SOUTH ELEVATION**

SC: 1/16" = 1'-0"

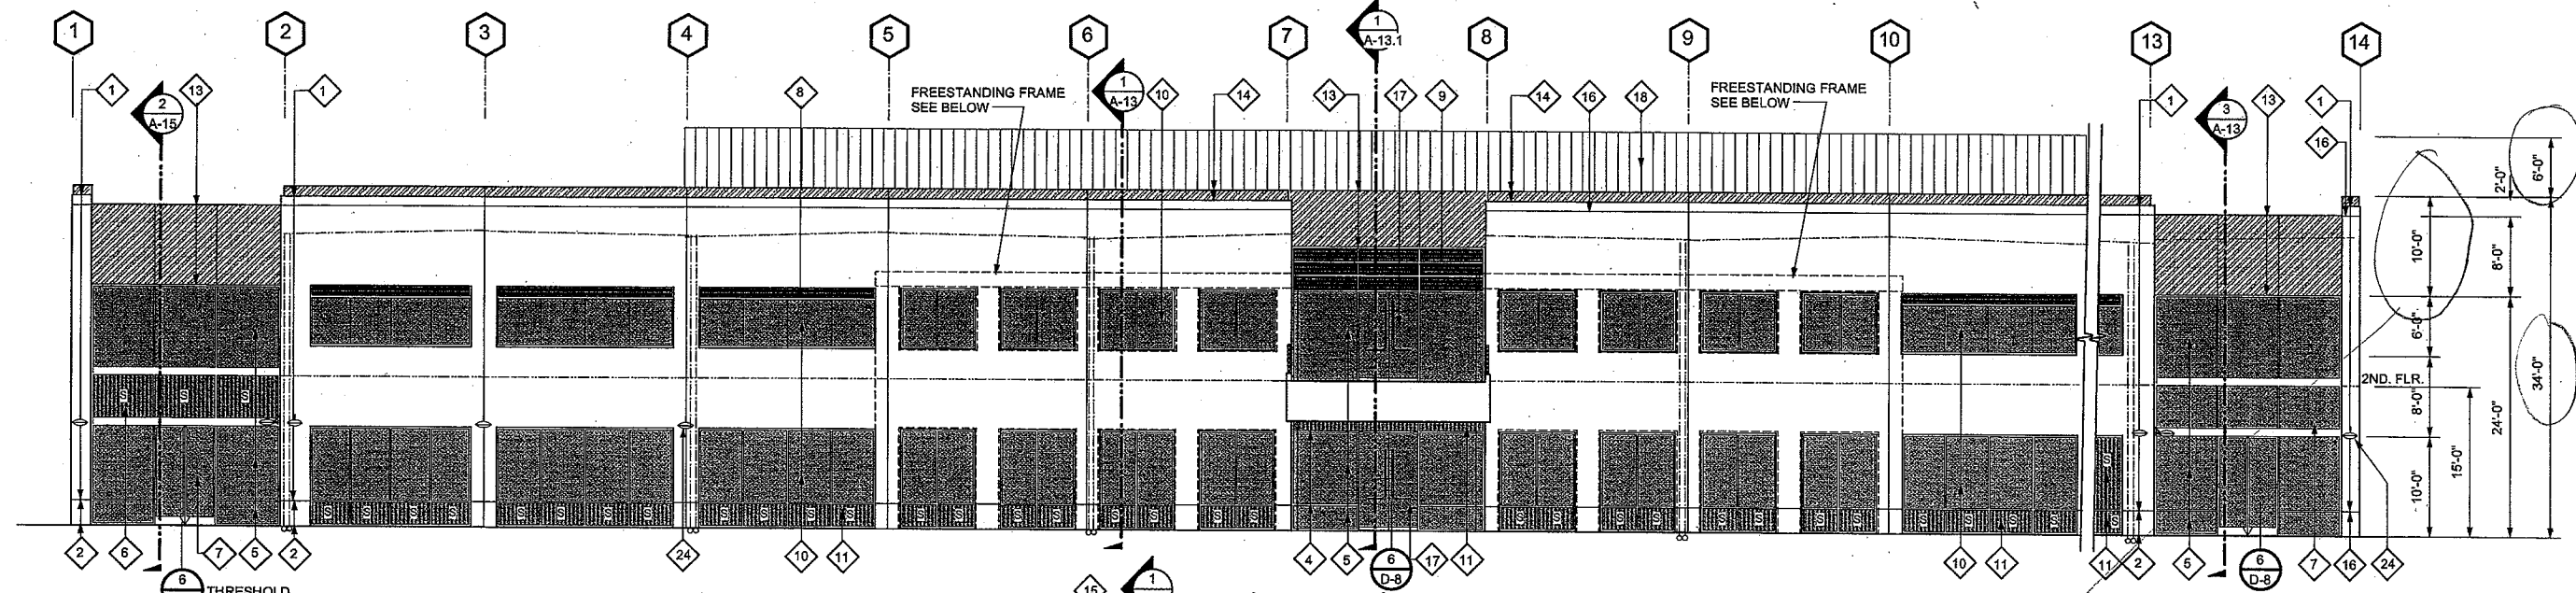


**PARTIAL SOUTH ELEVATION**

NOTE:  
 "S" INDICATES SPANDREL GLAZING, TYP.

NOTE:  
 SEE SHEET D-8 FOR STOREFRONT DETAILS, TYPICAL MAXIMUM U VALUE OF GLAZING TO BE 0.57, TYP.  
 ALL VISION GLAZING TO MEET ENERGY REQUIREMENTS.

**TYPICAL KEYNOTES**

1. CONCRETE TILT UP WALL PANEL (SMOOTH FINISH) PAINTED - FRAZEE NO. CL2802M "BABOUCHE", TYP.
2. CONCRETE TILT UP WALL PANEL (SMOOTH FINISH) PAINTED - FRAZEE NO. CL2804D "SHOGUN", TYP.
3. CONCRETE FREESTANDING ENTRY FRAME WALL (SMOOTH FINISH) PAINTED - FRAZEE NO. CL2804D "SHOGUN", TYP.
4. ALUMINUM STOREFRONT AND WINDOW SYSTEM BY ARCADIA, INC. (OR EQ). COLOR TO BE #11 / CLEAR AC-2, TYP.
5. GLAZING HIGH PERFORMANCE "CLEAR" AT ENTRIES - PPG SOLARBAN 250 LOW E (DUAL GLAZED), TYP.
6. GLAZING HIGH PERFORMANCE "CLEAR" AT ENTRIES - PPG SOLARBAN 250 LOW E WITH GRAY FRIT, TYP.
7. STOREFRONT DOORS, TYP.
8. ACCENT GLAZING - TINTED VISTEON VERSALUX BLUE 2000 (DUAL GLAZED), TYP.
9. SPANDREL GLAZING TINTED VISTEON VERSLUX BLUE 2000 WITH GRAY FRIT, TYP.
10. GLAZING - TINTED PPG SOLEXIA SOLARBAN 250 LOW E (DUAL GLAZED), TYP.
11. SPANDREL GLAZING - TINTED PPG SOLEXIA SOLARBAN 250 LOW E WITH GRAY FRIT, TYP.
12. SILICONE GLAZE (BUTT JOINT), TYP.
13. METAL FASCIA W/ REVEAL AT ENTRIES, TYP. - COLOR TO MATCH STOREFRONT SYSTEM, TYP.
14. METAL CAP OVER 2" RECESS IN CONCRETE, TYP. - COLOR TO MATCH STOREFRONT SYSTEM (BID ALTERNATE - PAINT TO MATCH STOREFRONT SYSTEM), TYP.
15. METAL TRELLIS - COLOR TO MATCH STOREFRONT SYSTEM, TYP.
16. REVEAL IN CONCRETE WALL. RETURN REVEALS AROUND CORNERS AND ON TO ALL EXPOSED SURFACES, TYP.
17. HERCULITE DOORS - HIGH PERFORMANCE CLEAR GLAZING AT CENTER ENTRY.
18. MECHANICAL EQUIPMENT SCREEN - FLUSH SEAM METAL PANELS - COLOR TO MATCH STOREFRONT SYSTEM, TYP.
19. CONCRETE TILT UP PANEL (SMOOTH FINISH) : PAINT - FRAZEE NO. CL 2804D "SHOGUN", TYP.
20. 2" RECESS IN PANEL, TYP. - PAINTED SMOOTH CONCRETE - FRAZEE NO. CL2895A "TEASLE".
21. STONE VENEER AND WAINSCOT CAP BY CORONADO STONE (ESR-2598) - SANTA BARBARA STONE "SAND DUNE" (4 - SIDES), TYP. VENEER SHALL BE INSTALLED PER MANUF. INSTRUCTIONS (SANDBLAST CONCRETE SUBSTRATE CLEAN PRIOR TO APPLYING VENEER).
22. PANEL JOINT, TYP.
23. STEEL AND CORRUGATED METAL GATES AND ROOF AT TRASH ENCLOSURE TO BE PAINTED: FRAZEE NO. 2802M "BABOUCHE", TYP.
24. WALL MOUNTED LIGHT FIXTURE - SEE ELECTRICAL.
25. 2" Ø STAINLESS STEEL GUARDRAIL.
26. 3'-0" x 7'-0" METAL DOOR - PAINTED TO MATCH ADJACENT SURFACE.

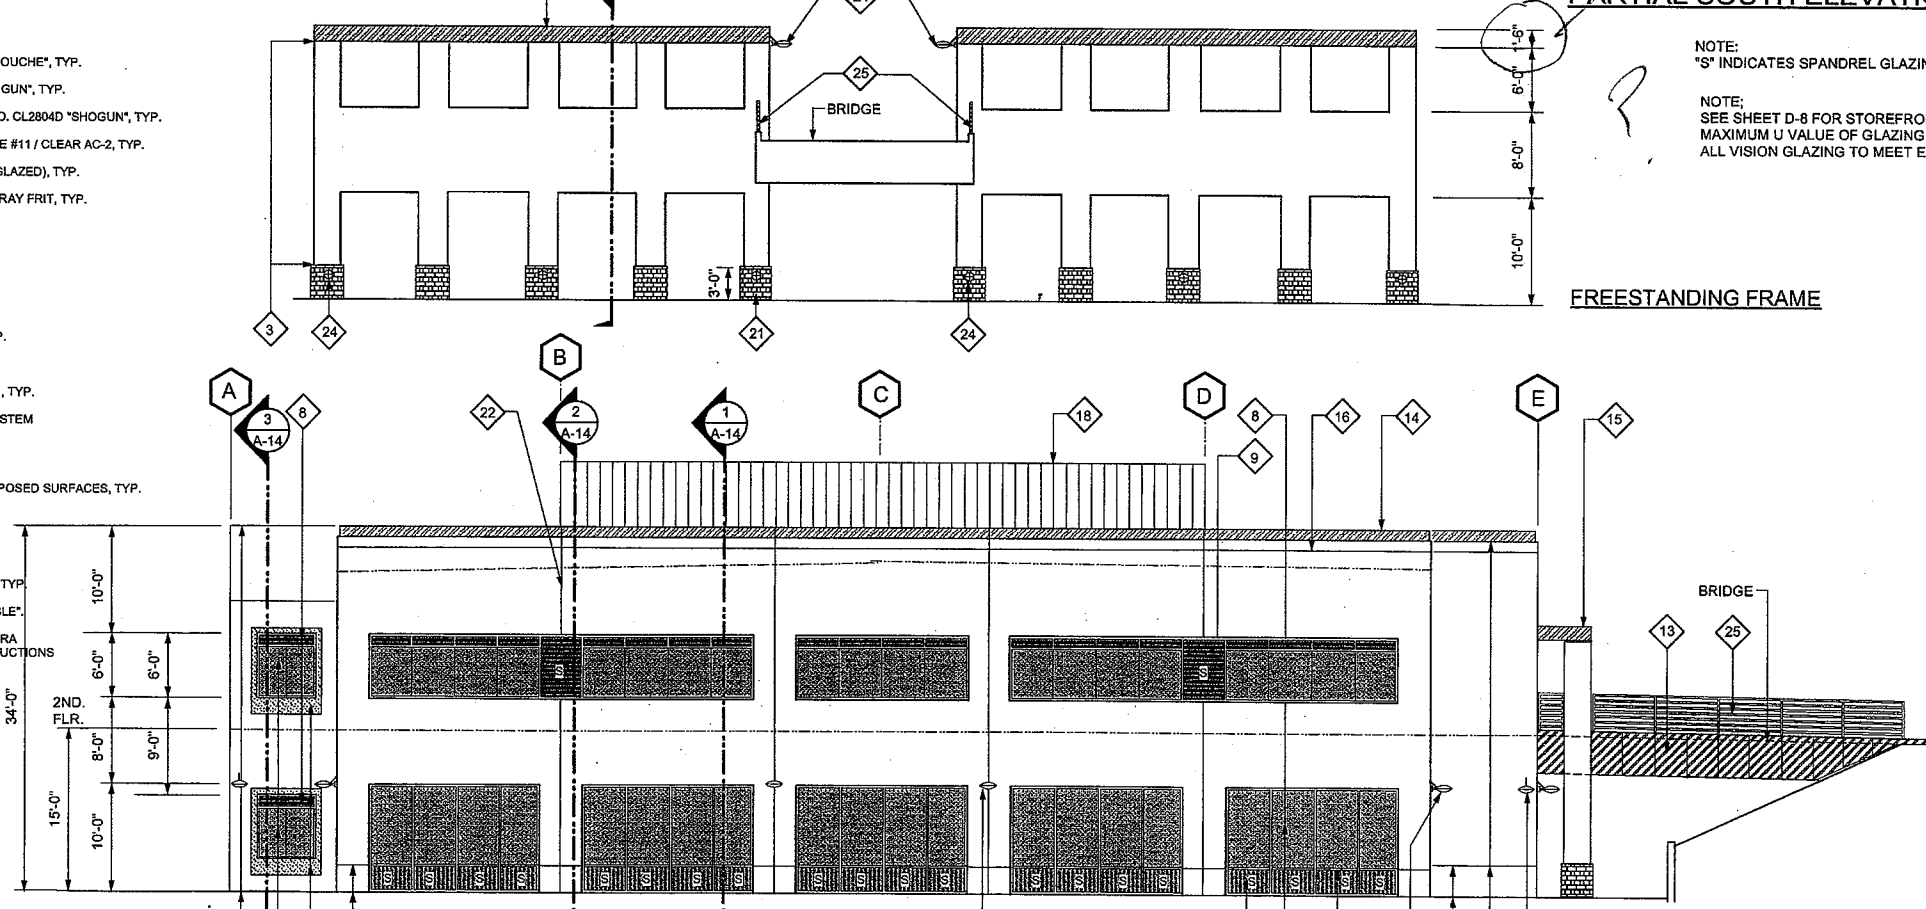

**WEST ELEVATION**

SC: 1/8" = 1'-0"



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Revisions

No.	Description

**CABRILLO BUSINESS PARK BUILDING NO. 4**

HOLLISTER AVE  
 GOLETA, CA

**EXTERIOR ELEVATIONS**

Date: 11-18-09  
 Job: 0904  
 Drawn by:  
 Sheet:






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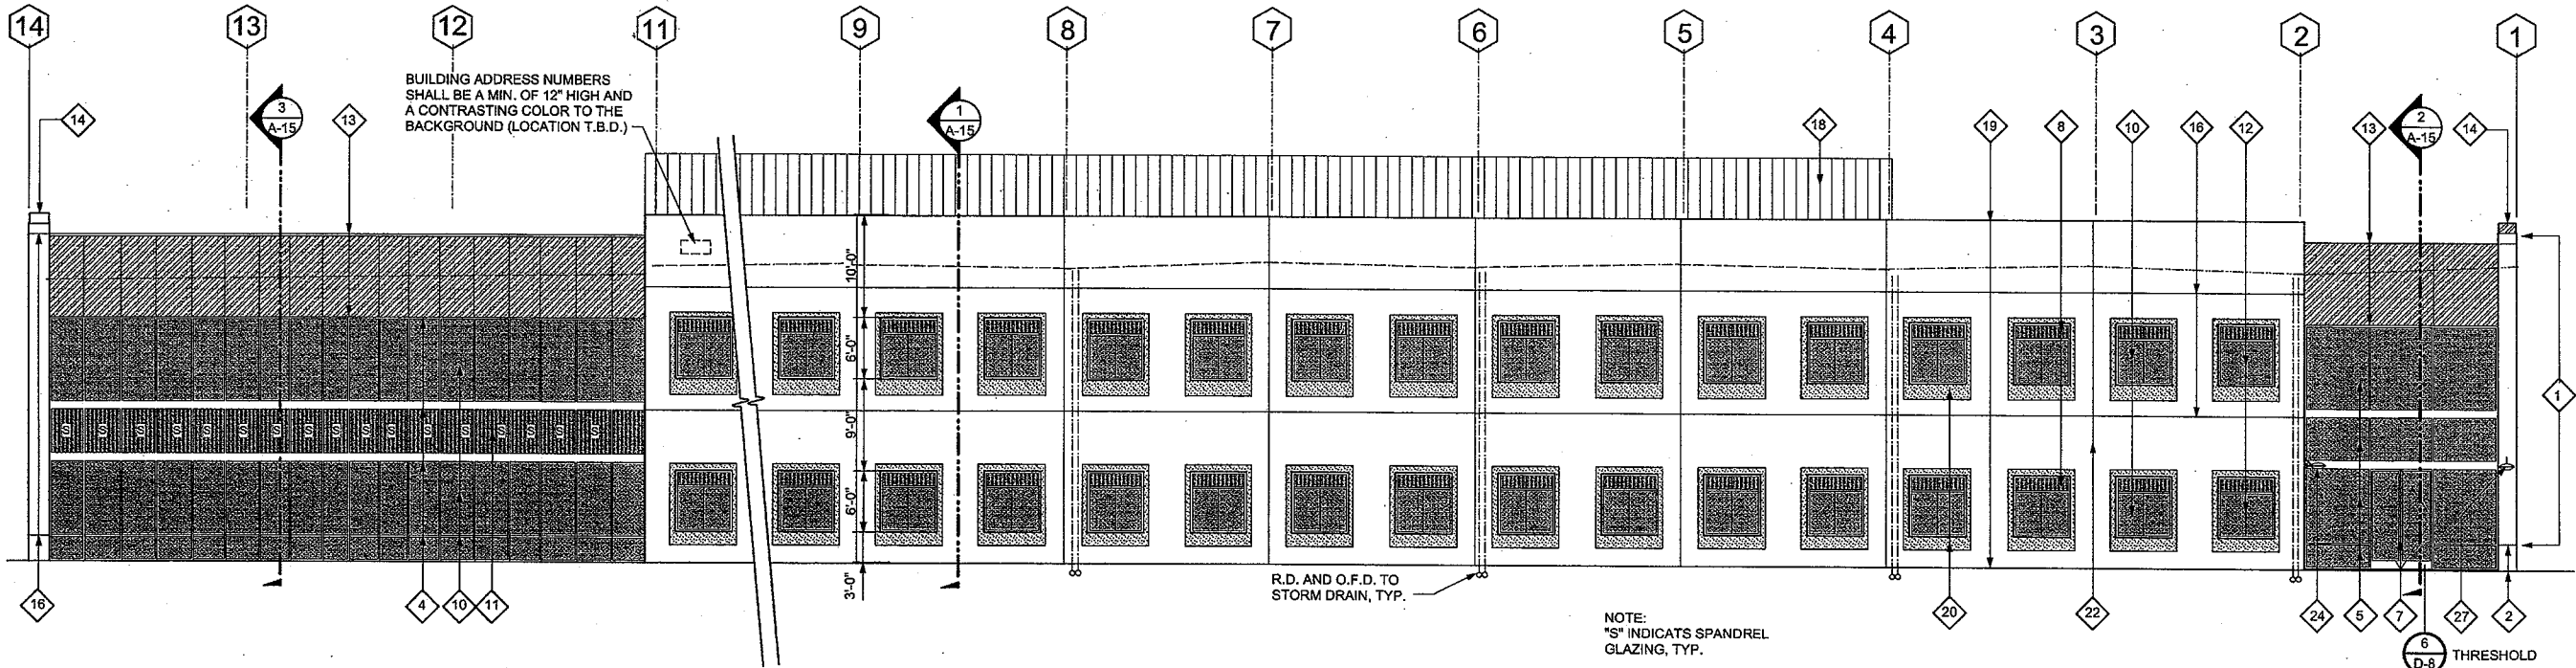
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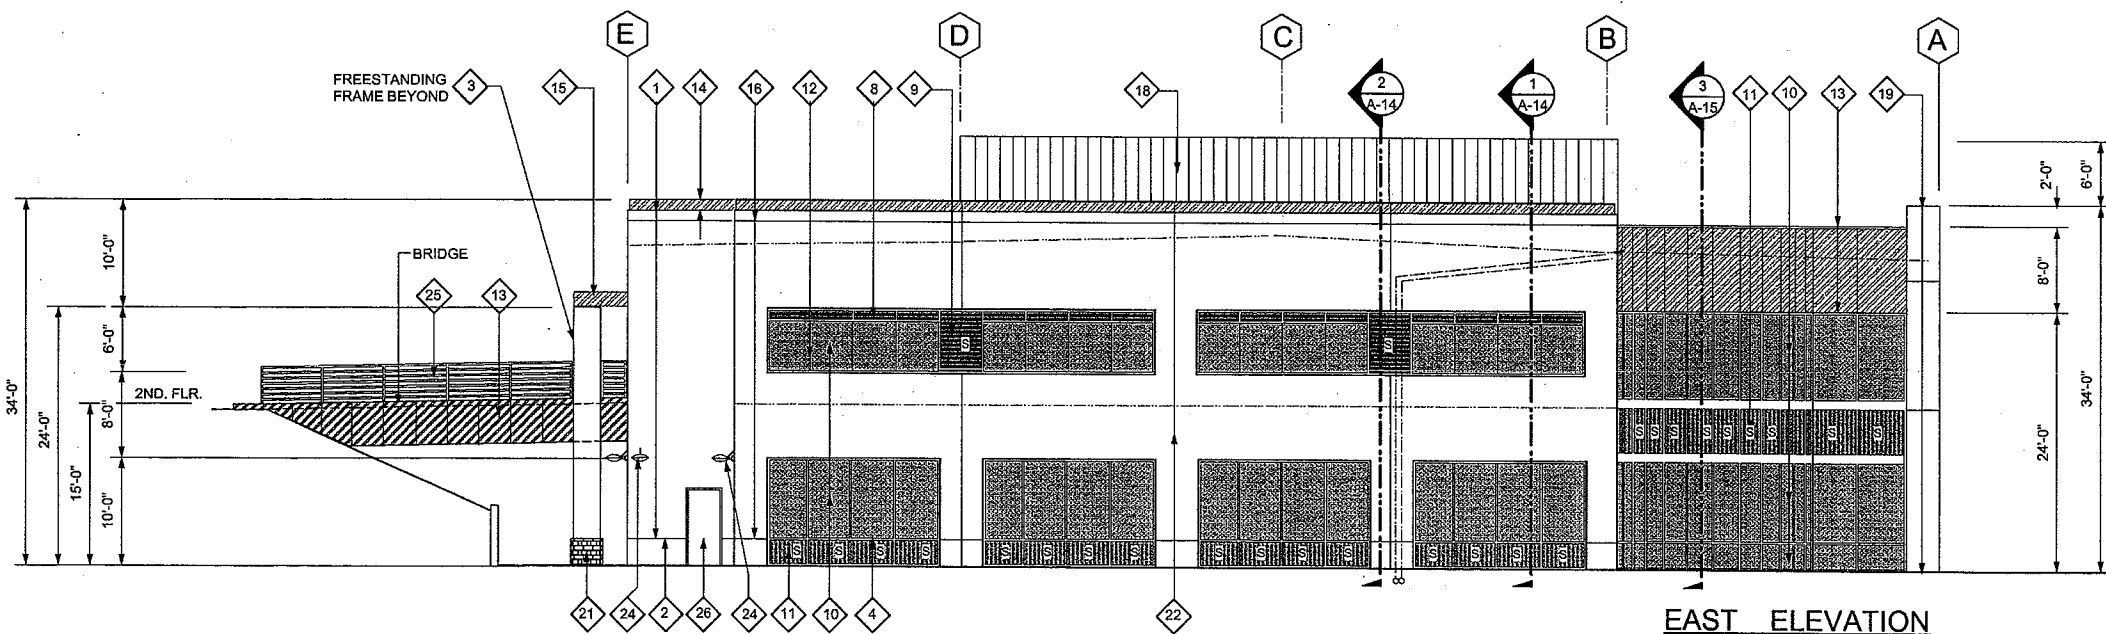
**NORTH ELEVATION**

NOTE:  
THE ALUMINUM STOREFRONT SYSTEM SHALL BE A DEFERRED, TO INCLUDE ALL DOORS AND WINDOWS.  
SUBMITTAL. THE CONTRACTOR SHALL SUBMIT SHOP DRAWING'S TO THIS OFFICE FOR REVIEW PRIOR TO SUBMITTING TO BUILDING AND SAFETY. THE SUBMITTAL SHALL INCLUDE:  
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3. DESIGN PER ASCE 7, SECTION 13.5.9 AND ASTM E 1300. SEE EQUATION 24-1 [2404].  
4. PROVIDE DETAILS AND CALC'S FOR OUT OF PLANE SUPPORTING SYSTEMS.  
MAXIMUM "U" VALUE OF GLAZING TO BE 0.57, TYP.  
ALL VISION GLAZING TO MEET ENERGY REQUIREMENTS.



**PARTIAL NORTH ELEVATION**

NOTE:  
"S" INDICATS SPANDREL GLAZING, TYP.  
NOTE:  
SEE SHEET D-8 FOR STOREFRONT DETAILS, TYPICAL  
MAXIMUM U VALUE OF GLAZING TO BE 0.57, TYP.  
ALL VISION GLAZING TO MEET ENERGY REQUIREMENTS.

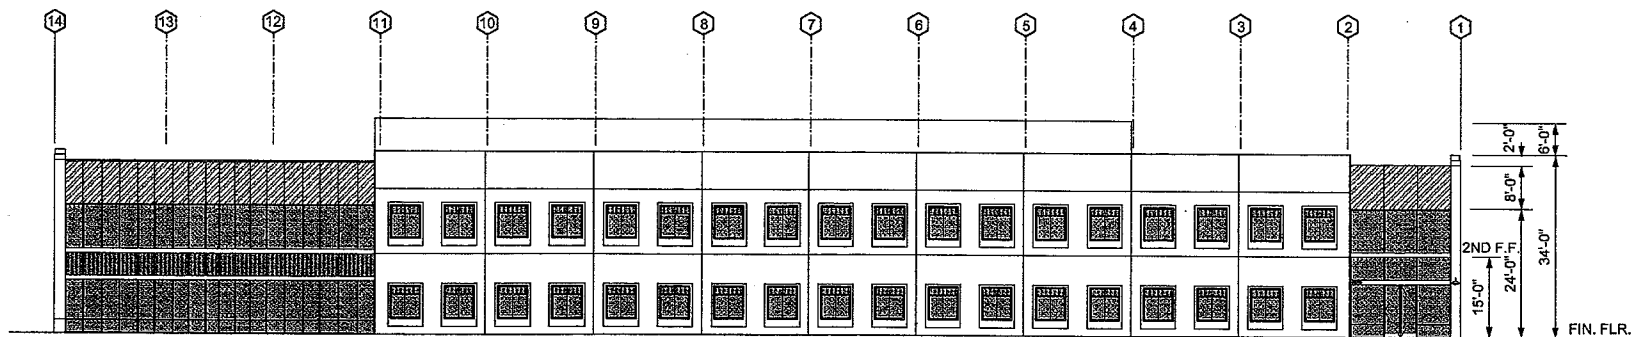

**EAST ELEVATION**

SC: 1/8" = 1'-0"

NOTE:  
SEE SHEET A-2 FOR 'KEYNOTES'

**CABRILLO  
BUSINESS PARK  
BUILDING NO. 4**

HOLLISTER AVE  
GOLETA, CA

**EXTERIOR  
ELEVATIONS**


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Job: 0904

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1 NOTE: SEE SHEET A-2 FOR KEYNOTES

**TRASH ENCLOSURE ELEVATIONS**

SEE SHEET D-15 FOR CONSTRUCTION DETAILS SC: 1/4" = 1'-0"

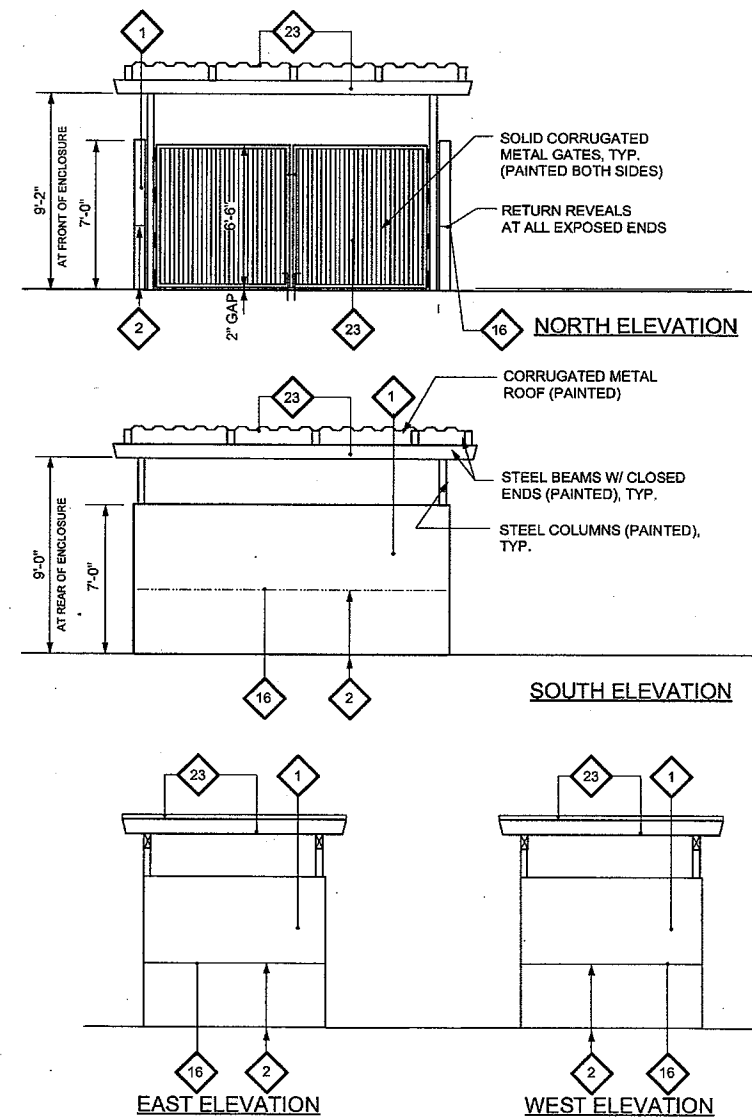

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**CABRILLO  
BUSINESS PARK  
BUILDING NO. 4**

HOLLISTER AVE  
GOLETA, CA

**TRASH  
ENCLOSURE  
ELEVATIONS**

Date: 11-18-09

Job: 0804

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Sheet:




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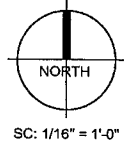
NOTE:  
SEE SHEET M-6 FOR "FORM PERFF-1" AND "ENV-C-1"  
SPECIFYING THE REQUIRED ENERGY FEATURES  
FOR WALL / CEILING INSULATION, WINDOW AREAS  
AND TYPES, HVAC SYSTEMS, DUCT INSULATION  
AND TESTING, LIGHTING TYPE AND SWITCHING,  
WATER HEATER TYPE AND PIPE/HEATER INSULATION

NOTE:  
FOR WALL LEGEND AND TYPICAL NOTES, SEE  
"ABBREVIATION AND LEGEND SHEET"  
FOR REQUIRED CLEARANCES AT INTERIOR DOORS  
SEE 4-D-4

**CABRILLO  
BUSINESS PARK  
BUILDING NO. 4**  
HOLLISTER AVE  
GOLETA, CA

**FIRST FLOOR  
PLAN**

Date:	11-18-09
Job:	0904
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Sheet:	

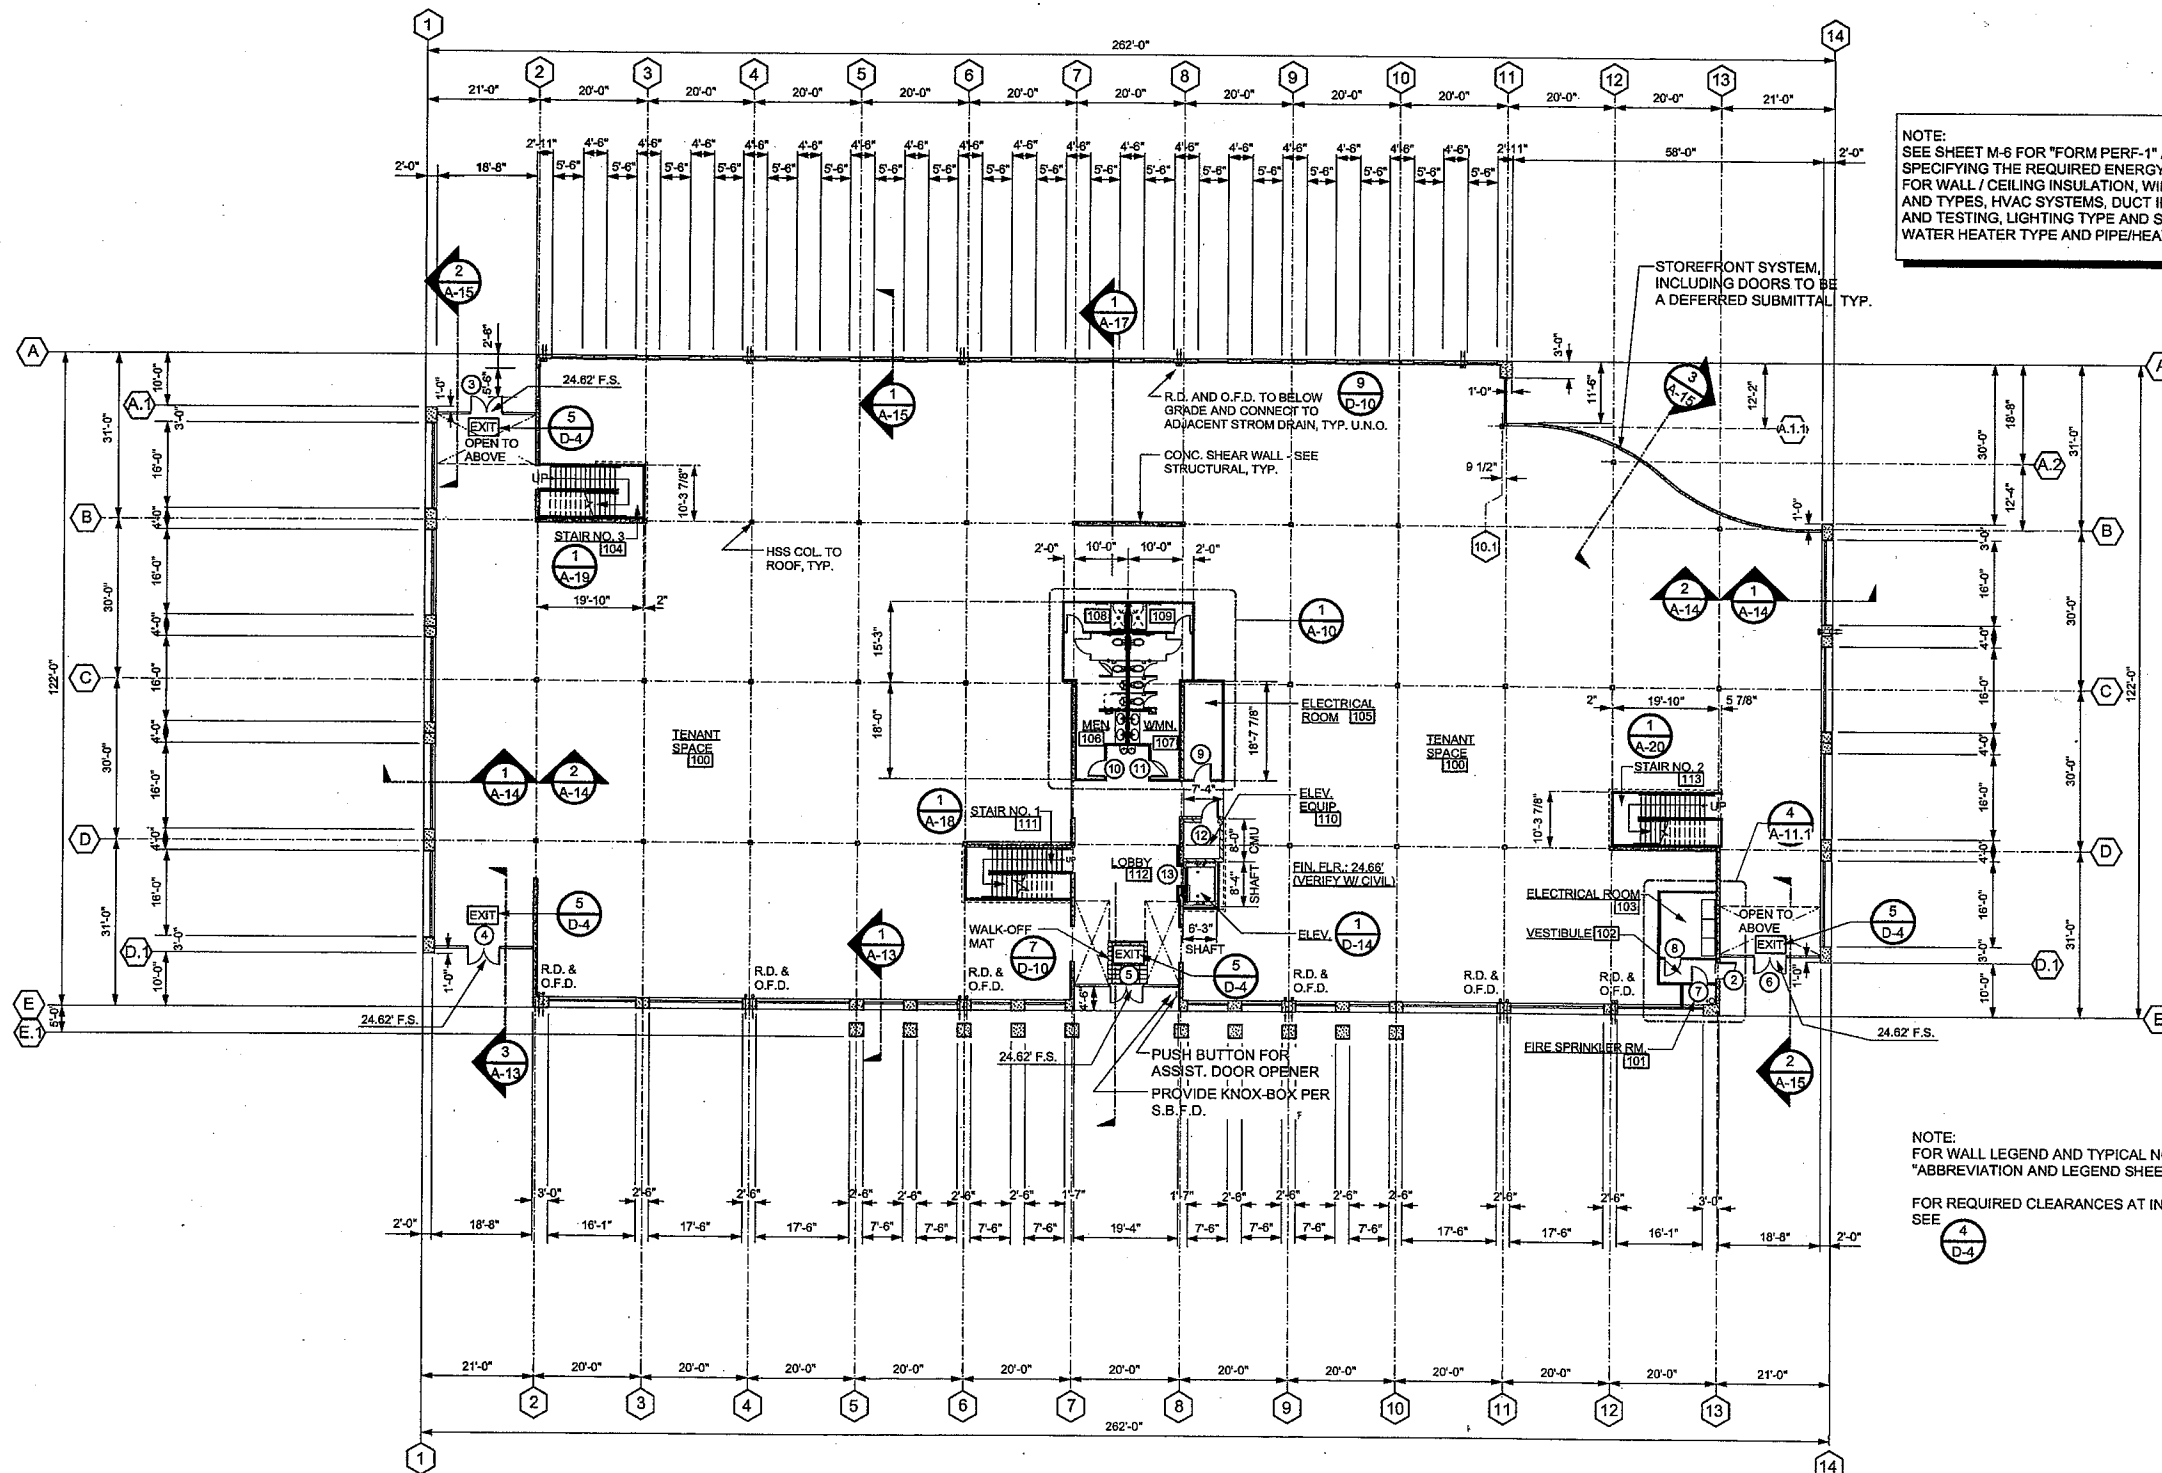


SC: 1/16" = 1'-0"

**FIRST FLOOR PLAN**  
±29,950 SF

**A-4**




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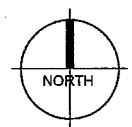
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Revisions

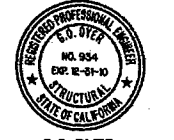

NOTE:  
1. RESTROOMS SHALL BE PROVIDED WITH LED DOWNLIGHTS.  
2. REMAINING AREAS TO BE LITE WITH T8 FLUORESCENT FIXTURES WITH ELECTRONIC BALLASTS.  
3. ENTIRE BUILDING SHALL BE PROVIDED WITH LIGHTING CONTROL SYSTEMS AND INDIVIDUAL ROOM OCCUPANCY SENSORS.



SC: 1/16" = 1'-0"

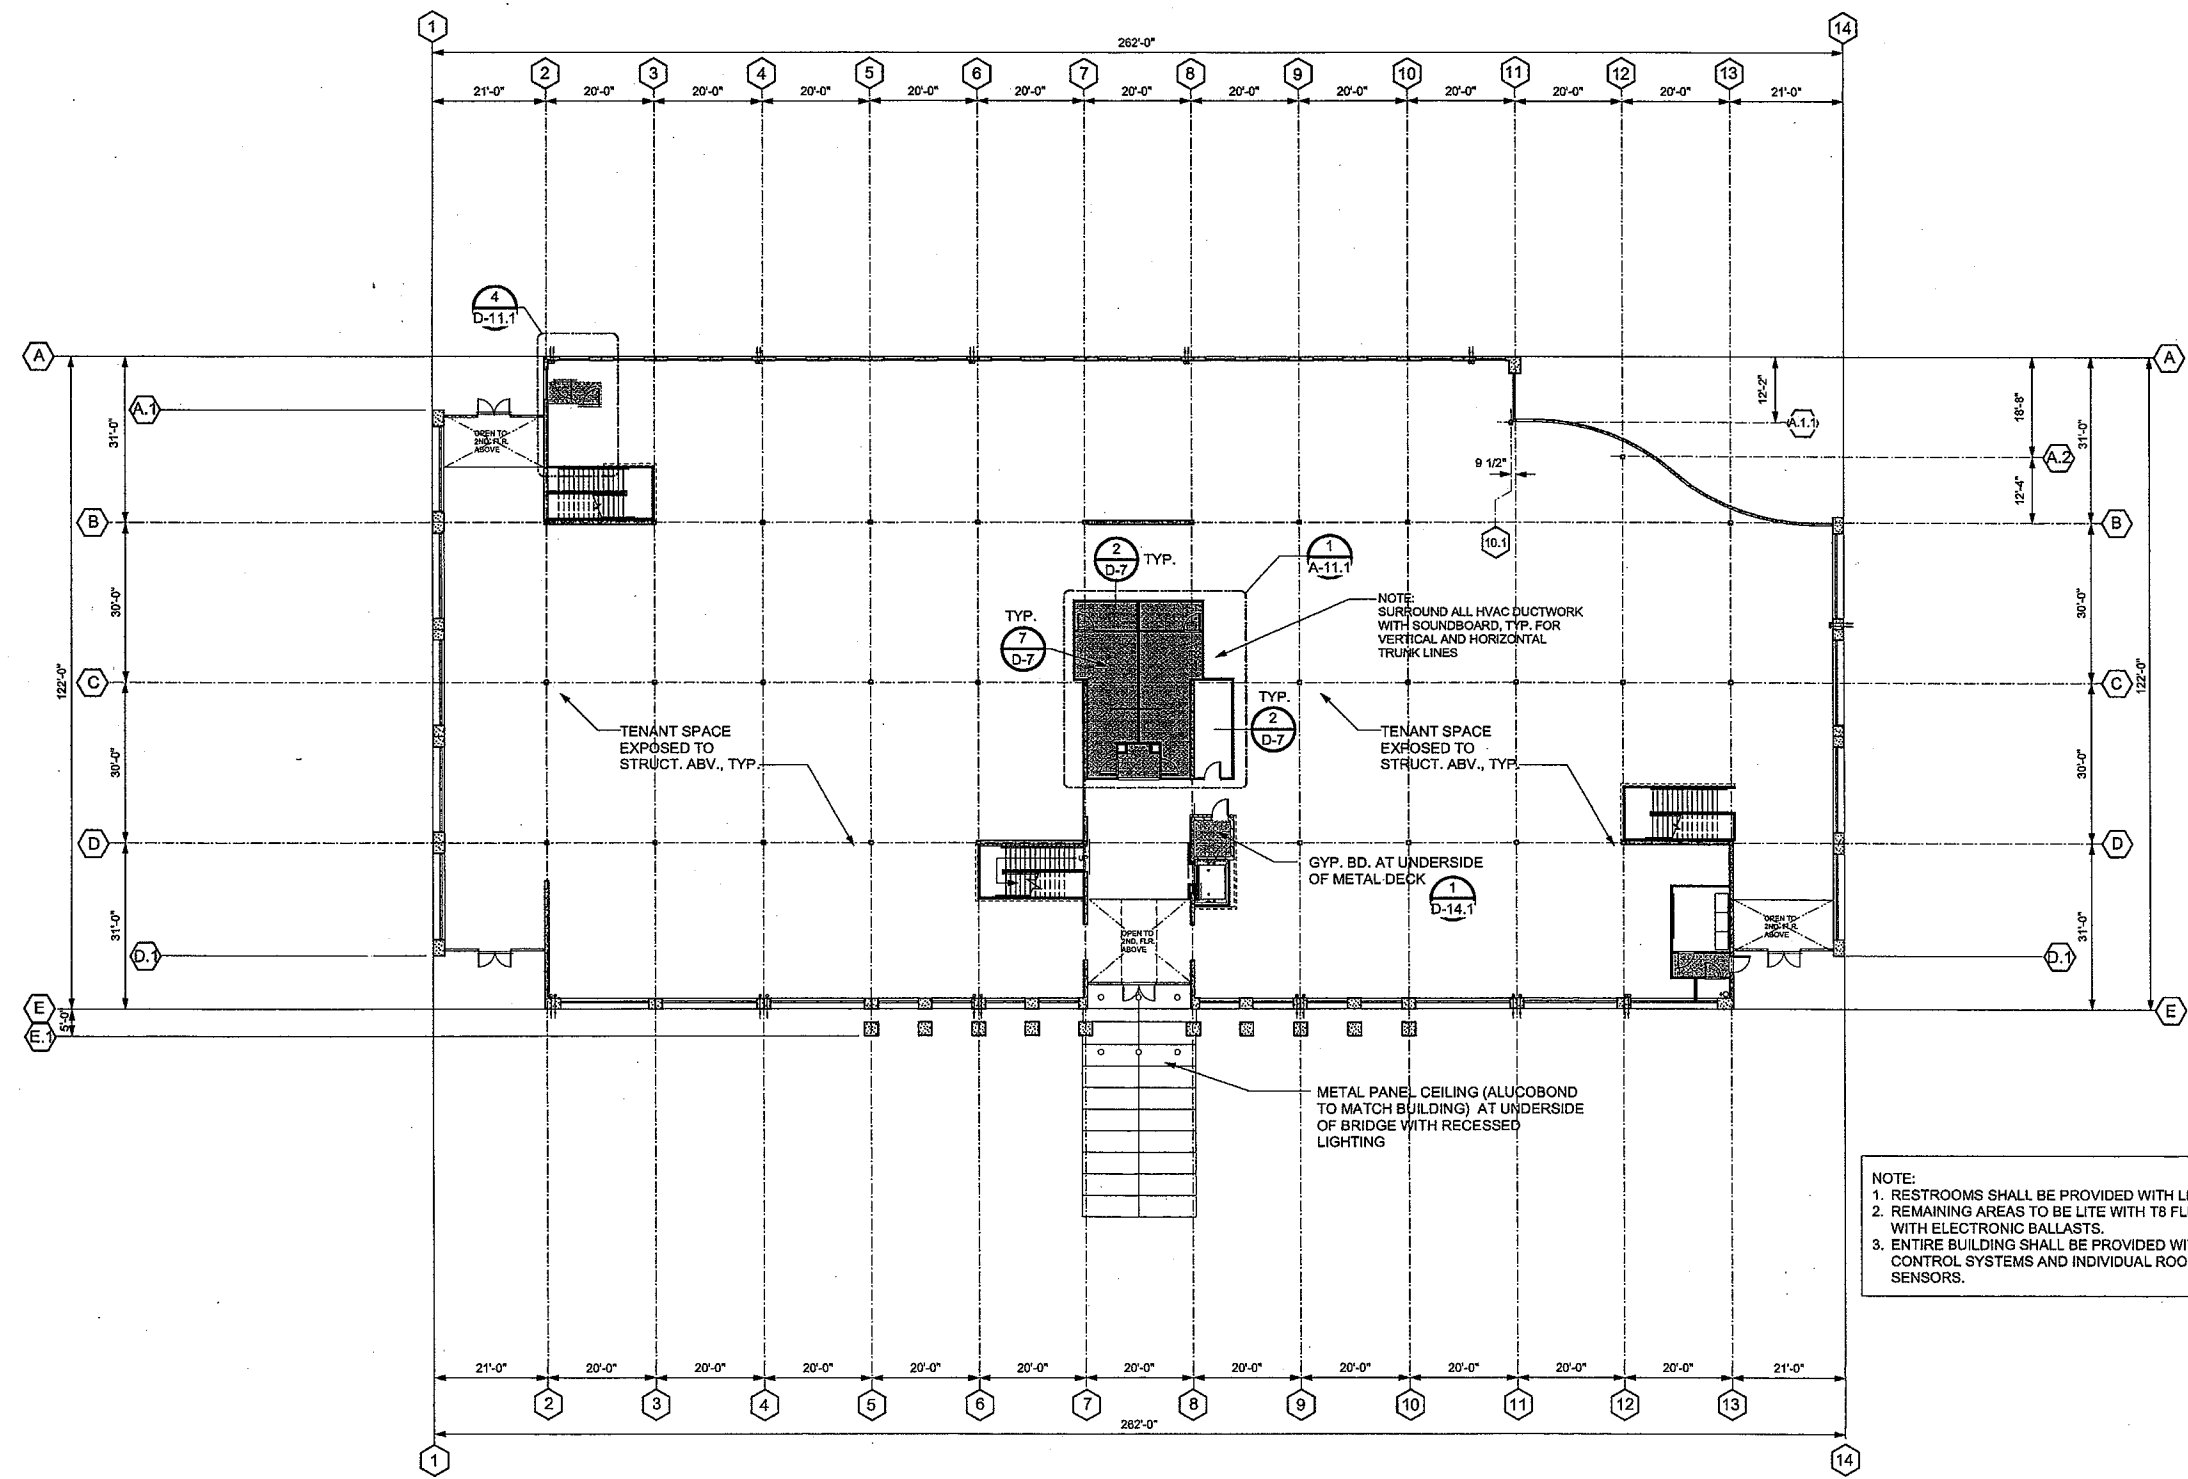FIRST FLOOR  
CEILING PLAN

**CABRILLO  
BUSINESS PARK  
BUILDING NO. 4**

HOLLISTER AVE  
GOLETA, CA

**FIRST FLOOR  
CEILING PLAN**

Date: 11-18-09

Job: 0904

Drawn by:

Sheet:

A-5





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 C-12762




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 EXP. 12-31-10

Revisions


**EXITING LEGEND**

- AREA → AREA IN SQ. FT. (NET)
- B/F → OCCUPANT FACTOR (S.F./PERSON)
- OCC. → OCCUPANT LOAD
- X/XX → TOTAL MIN. EGRESS WIDTH (LOAD x 0.15")
- → MIN. REQ'D. NO. OF EXITS
- → GROUP OCCUPANCY
- ← → EXITING PATH
- EXIT → ILLUMINATED EXIT SIGN
- OCC. → OCCUPANT LOAD EXITING
- X/XX → OPENING SIZE
- → REQ'D MIN. CLEAR OPNG. (.2") AT STAIRWAY

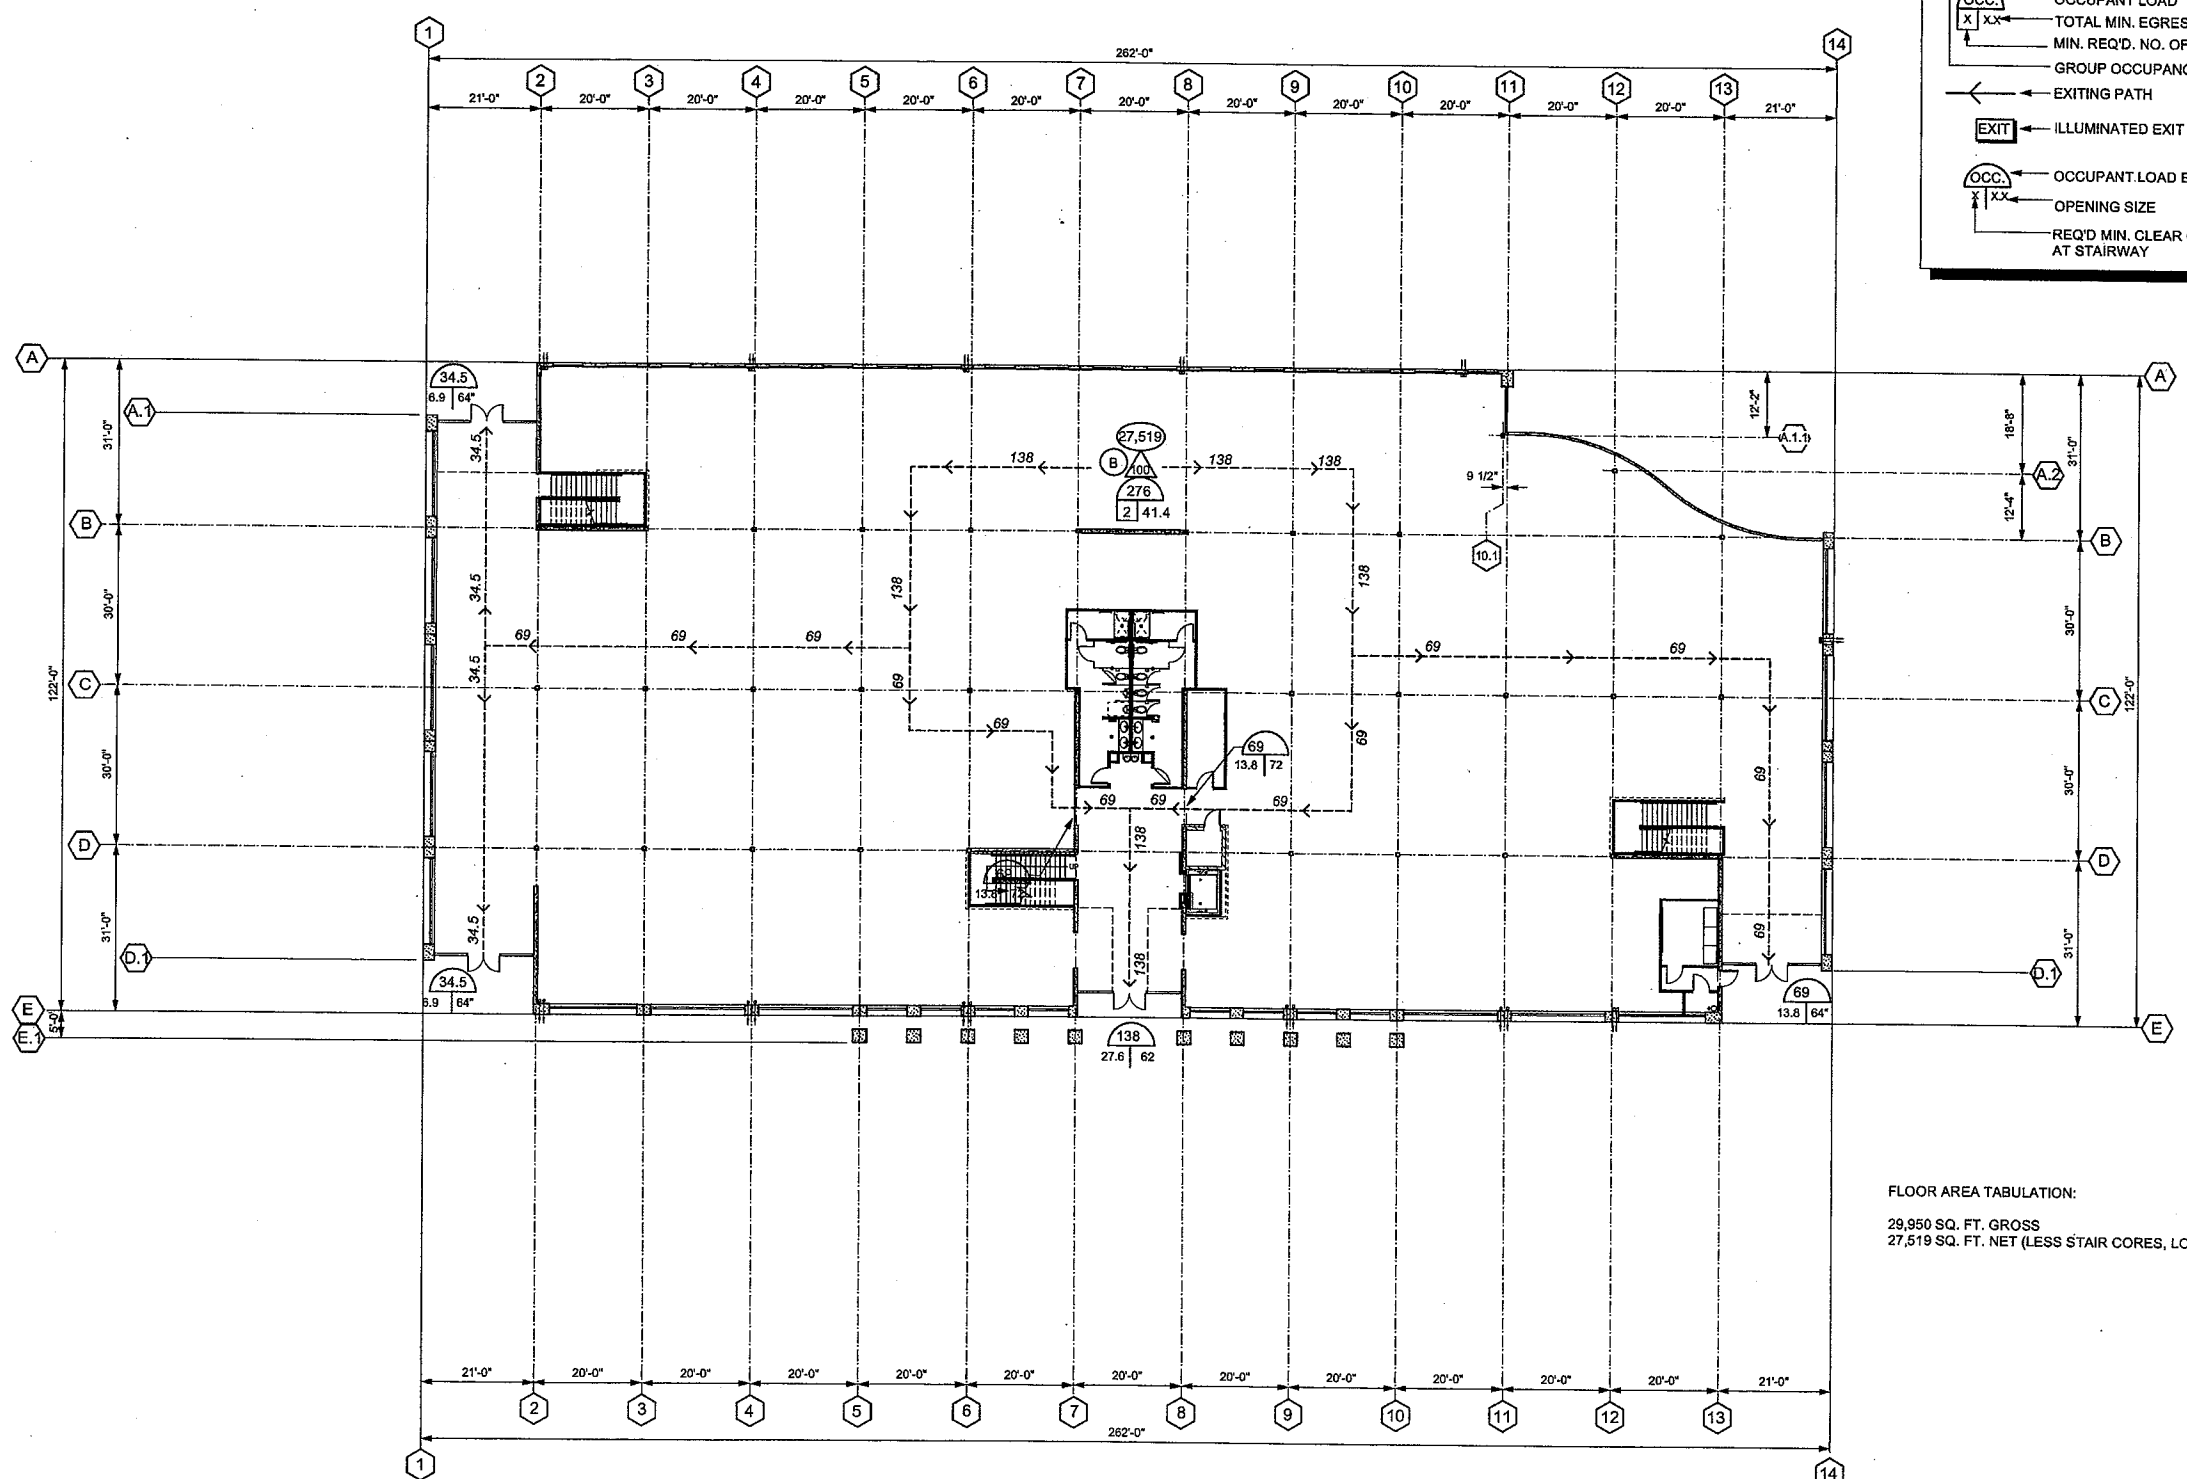


FLOOR AREA TABULATION:  
 29,950 SQ. FT. GROSS  
 27,519 SQ. FT. NET (LESS STAIR CORES, LOBBY AND RESTROOM CORES).

**CABRILLO  
 BUSINESS PARK  
 BUILDING NO. 4**  
 HOLLISTER AVE  
 GOLETA, CA

**FIRST FLOOR  
 EXITING PLAN**

Date: 11-18-09  
 Job: 0904  
 Drawn by:  
 Sheet:

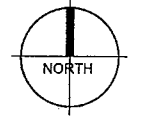

SC: 1/16" = 1'-0"

FIRST FLOOR  
 EXITING PLAN




VINCENT DYER  
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G.O. DYER  
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Revisions




NOTE:  
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SPECIFYING THE REQUIRED ENERGY FEATURES  
FOR WALL / CEILING INSULATION, WINDOW AREAS  
AND TYPES, HVAC SYSTEMS, DUCT INSULATION  
AND TESTING, LIGHTING TYPE AND SWITCHING,  
WATER HEATER TYPE AND PIPE/HEATER INSULATION

STOREFRONT SYSTEM INCLUDING DOORS  
TO BE DEFERRED SUBMITTAL, TYP.

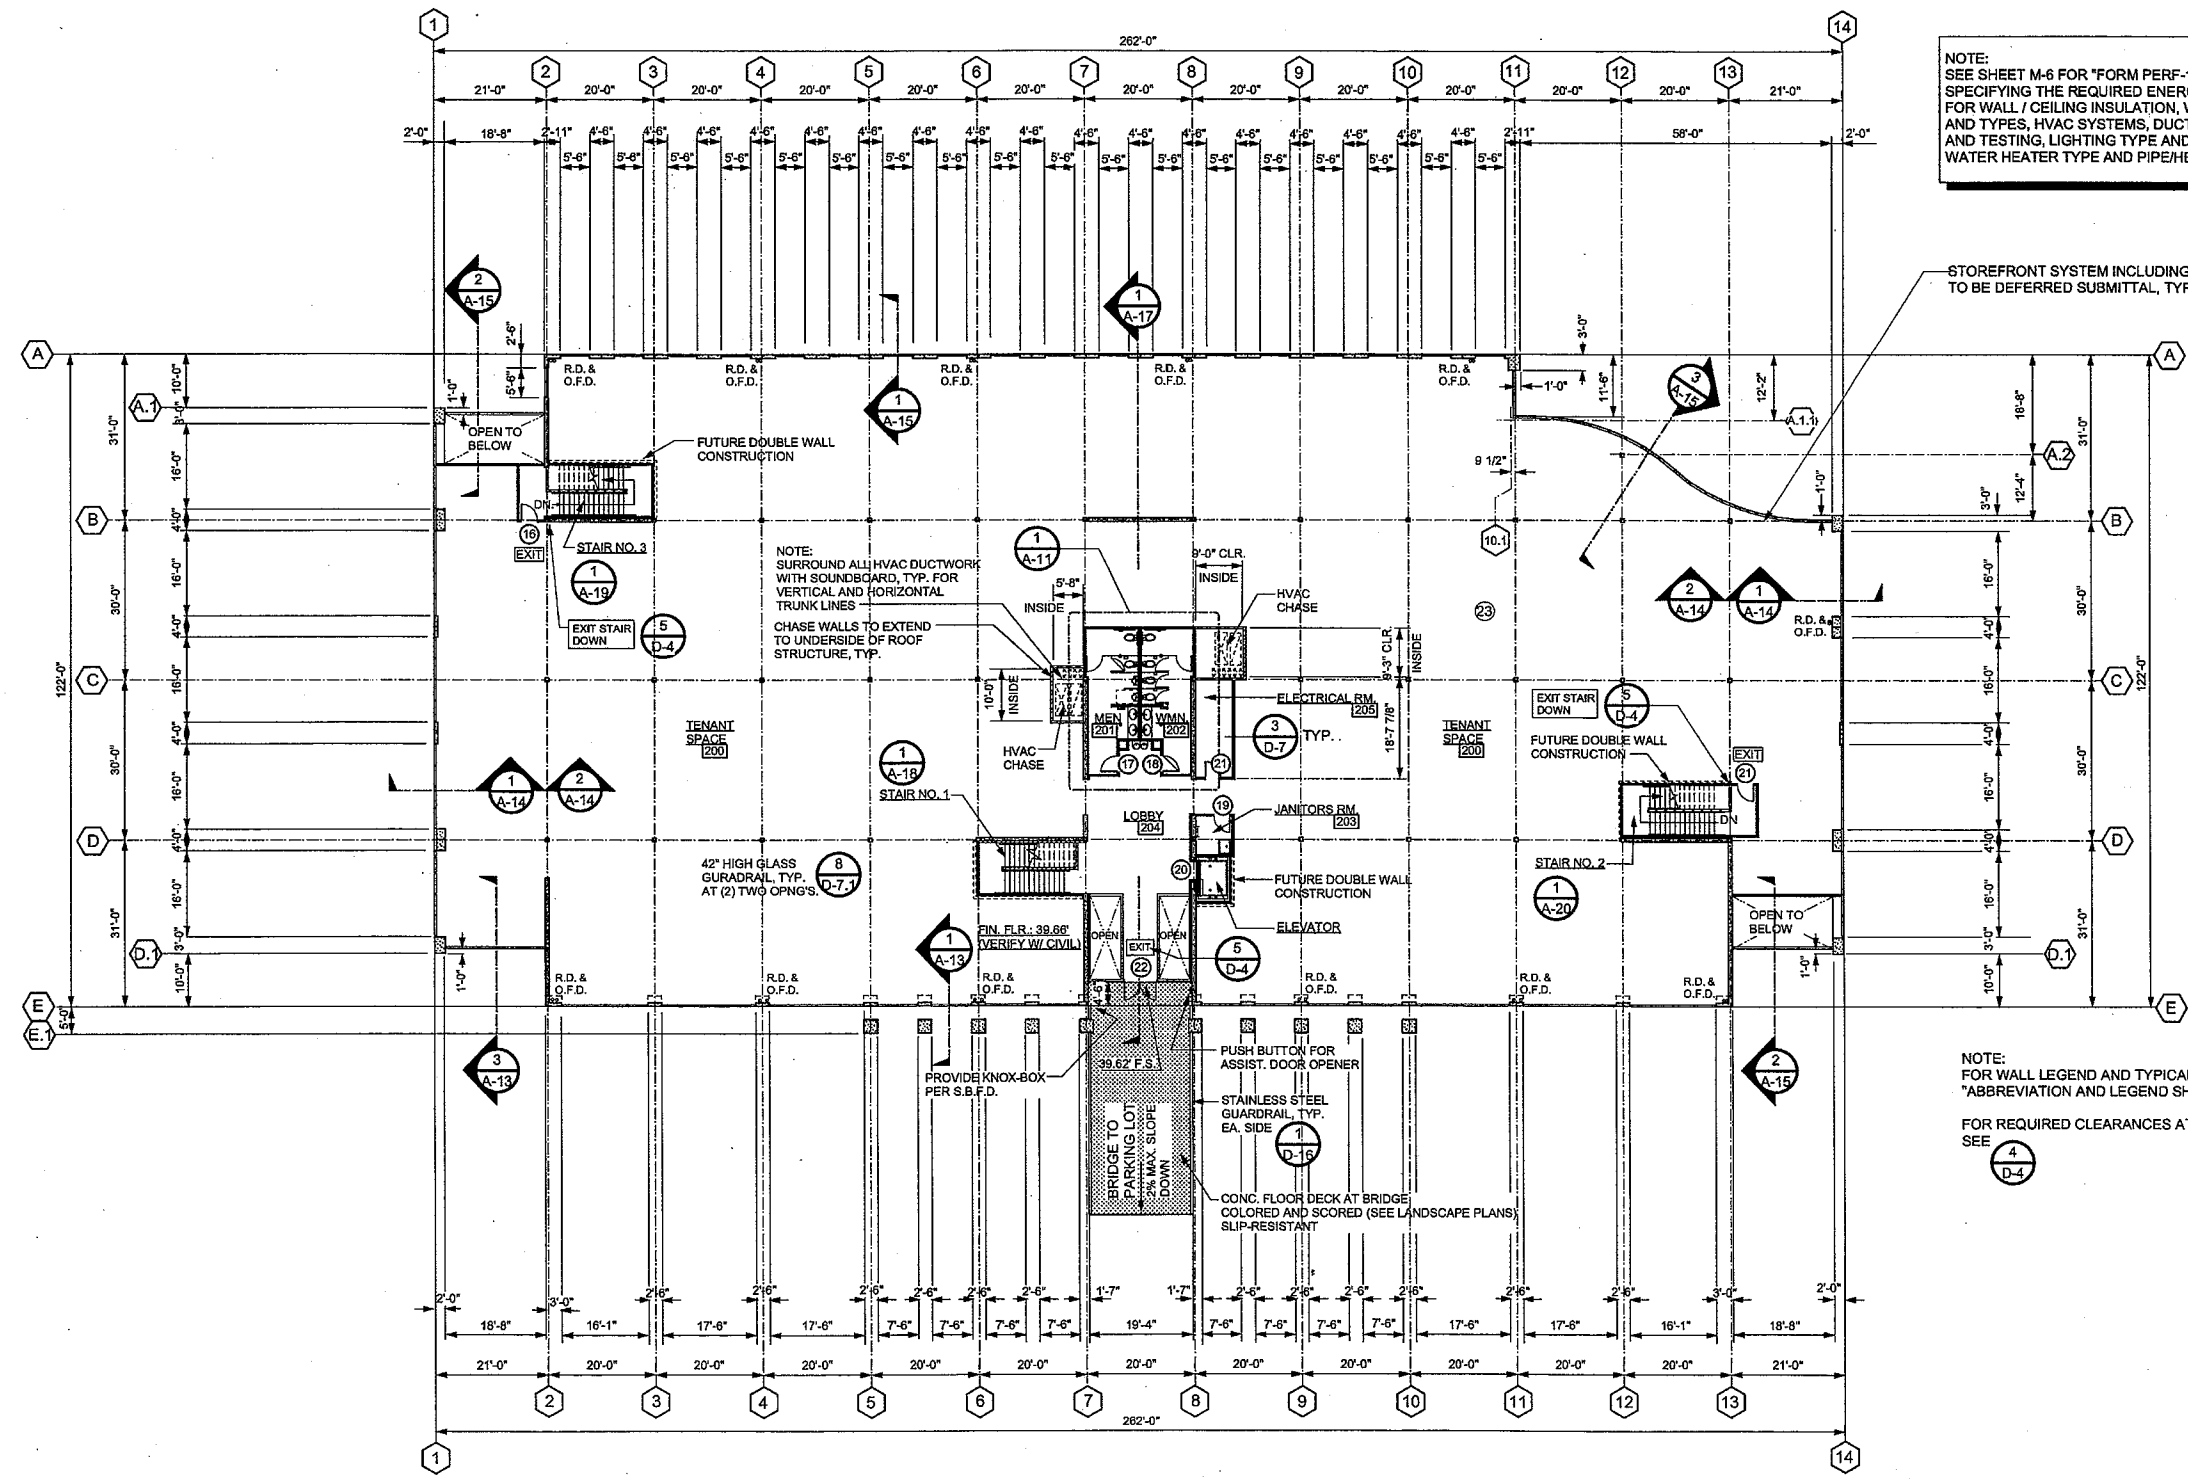NOTE:  
SURROUND ALL HVAC DUCTWORK  
WITH SOUNDBOARD, TYP. FOR  
VERTICAL AND HORIZONTAL  
TRUNK LINES  
CHASE WALLS TO EXTEND  
TO UNDERSIDE OF ROOF  
STRUCTURE, TYP.

NOTE:  
FOR WALL LEGEND AND TYPICAL NOTES, SEE  
"ABBREVIATION AND LEGEND SHEET"  
FOR REQUIRED CLEARANCES AT INTERIOR DOORS  
SEE 4 D-4

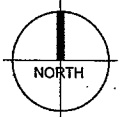

SC: 1/16" = 1'-0"

SECOND FLOOR PLAN  
±28,725 SF

**CABRILLO  
BUSINESS PARK  
BUILDING NO. 4**  
HOLLISTER AVE  
GOLETA, CA

**SECOND FLOOR  
PLAN**

Date: 11-18-09  
Job: 0904  
Drawn by:  
Sheet:

A-7




VINCENT DYER  
 C-12762




G.O. DYER  
 NO. 934  
 EXP. 12-31-10

Revisions

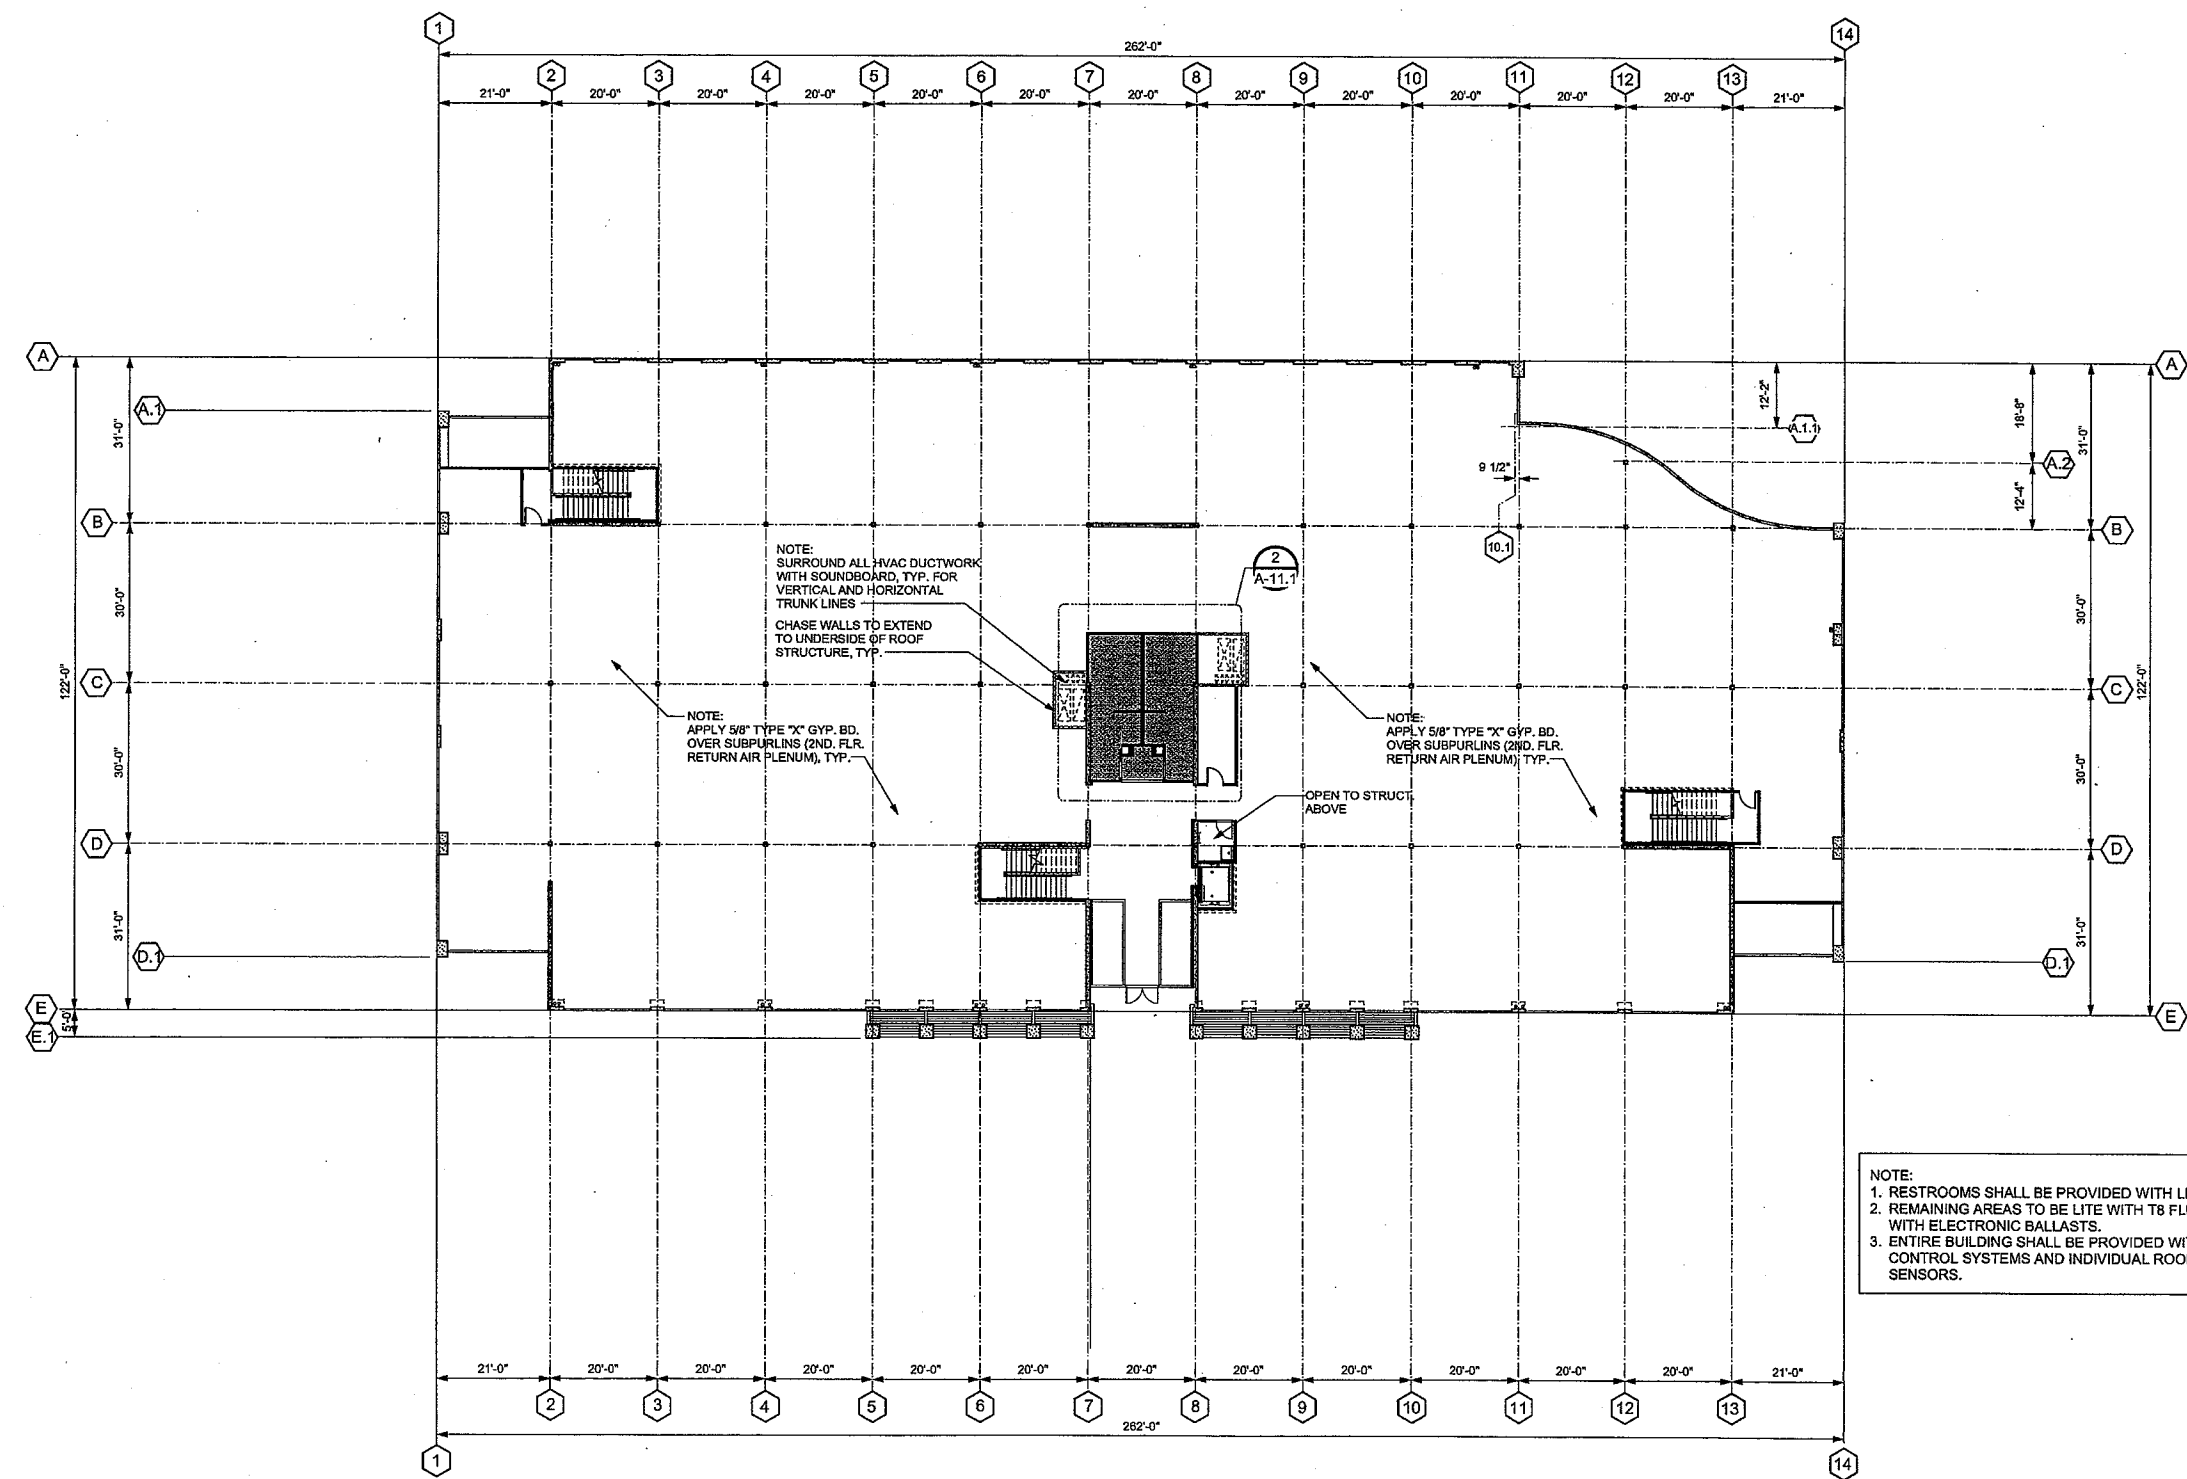NOTE:  
 1. RESTROOMS SHALL BE PROVIDED WITH LED DOWNLIGHTS.  
 2. REMAINING AREAS TO BE LITE WITH T8 FLUORESCENT FIXTURES WITH ELECTRONIC BALLASTS.  
 3. ENTIRE BUILDING SHALL BE PROVIDED WITH LIGHTING CONTROL SYSTEMS AND INDIVIDUAL ROOM OCCUPANCY SENSORS.

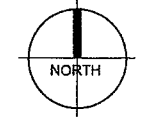

SC: 1/16" = 1'-0"

SECOND FLOOR  
 CEILING PLAN

**CABRILLO  
 BUSINESS PARK  
 BUILDING NO. 4**  
 HOLLISTER AVE  
 GOLETA, CA

**SECOND FLOOR  
 CEILING PLAN**

Date: 11-18-09

Job: 0904


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A-8



VINCENT DYER  
 C-12762





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 NO. 934

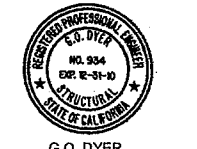Revisions

**EXITING LEGEND**

- (AREA) AREA IN SQ. FT. (NET)
- (OCC.) OCCUPANT FACTOR (S.F./PERSON)
- (X) TOTAL MIN. EGRESS WIDTH (LOAD x 0.15')
- (MIN.) MIN. REQ'D. NO. OF EXITS
- (GROUP) GROUP OCCUPANCY
- (EXIT) ILLUMINATED EXIT SIGN
- (OCC.) OCCUPANT LOAD EXITING
- (X) OPENING SIZE
- (X) REQ'D MIN. CLEAR OP'NG. (.2') AT STAIRWAY

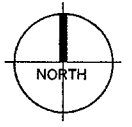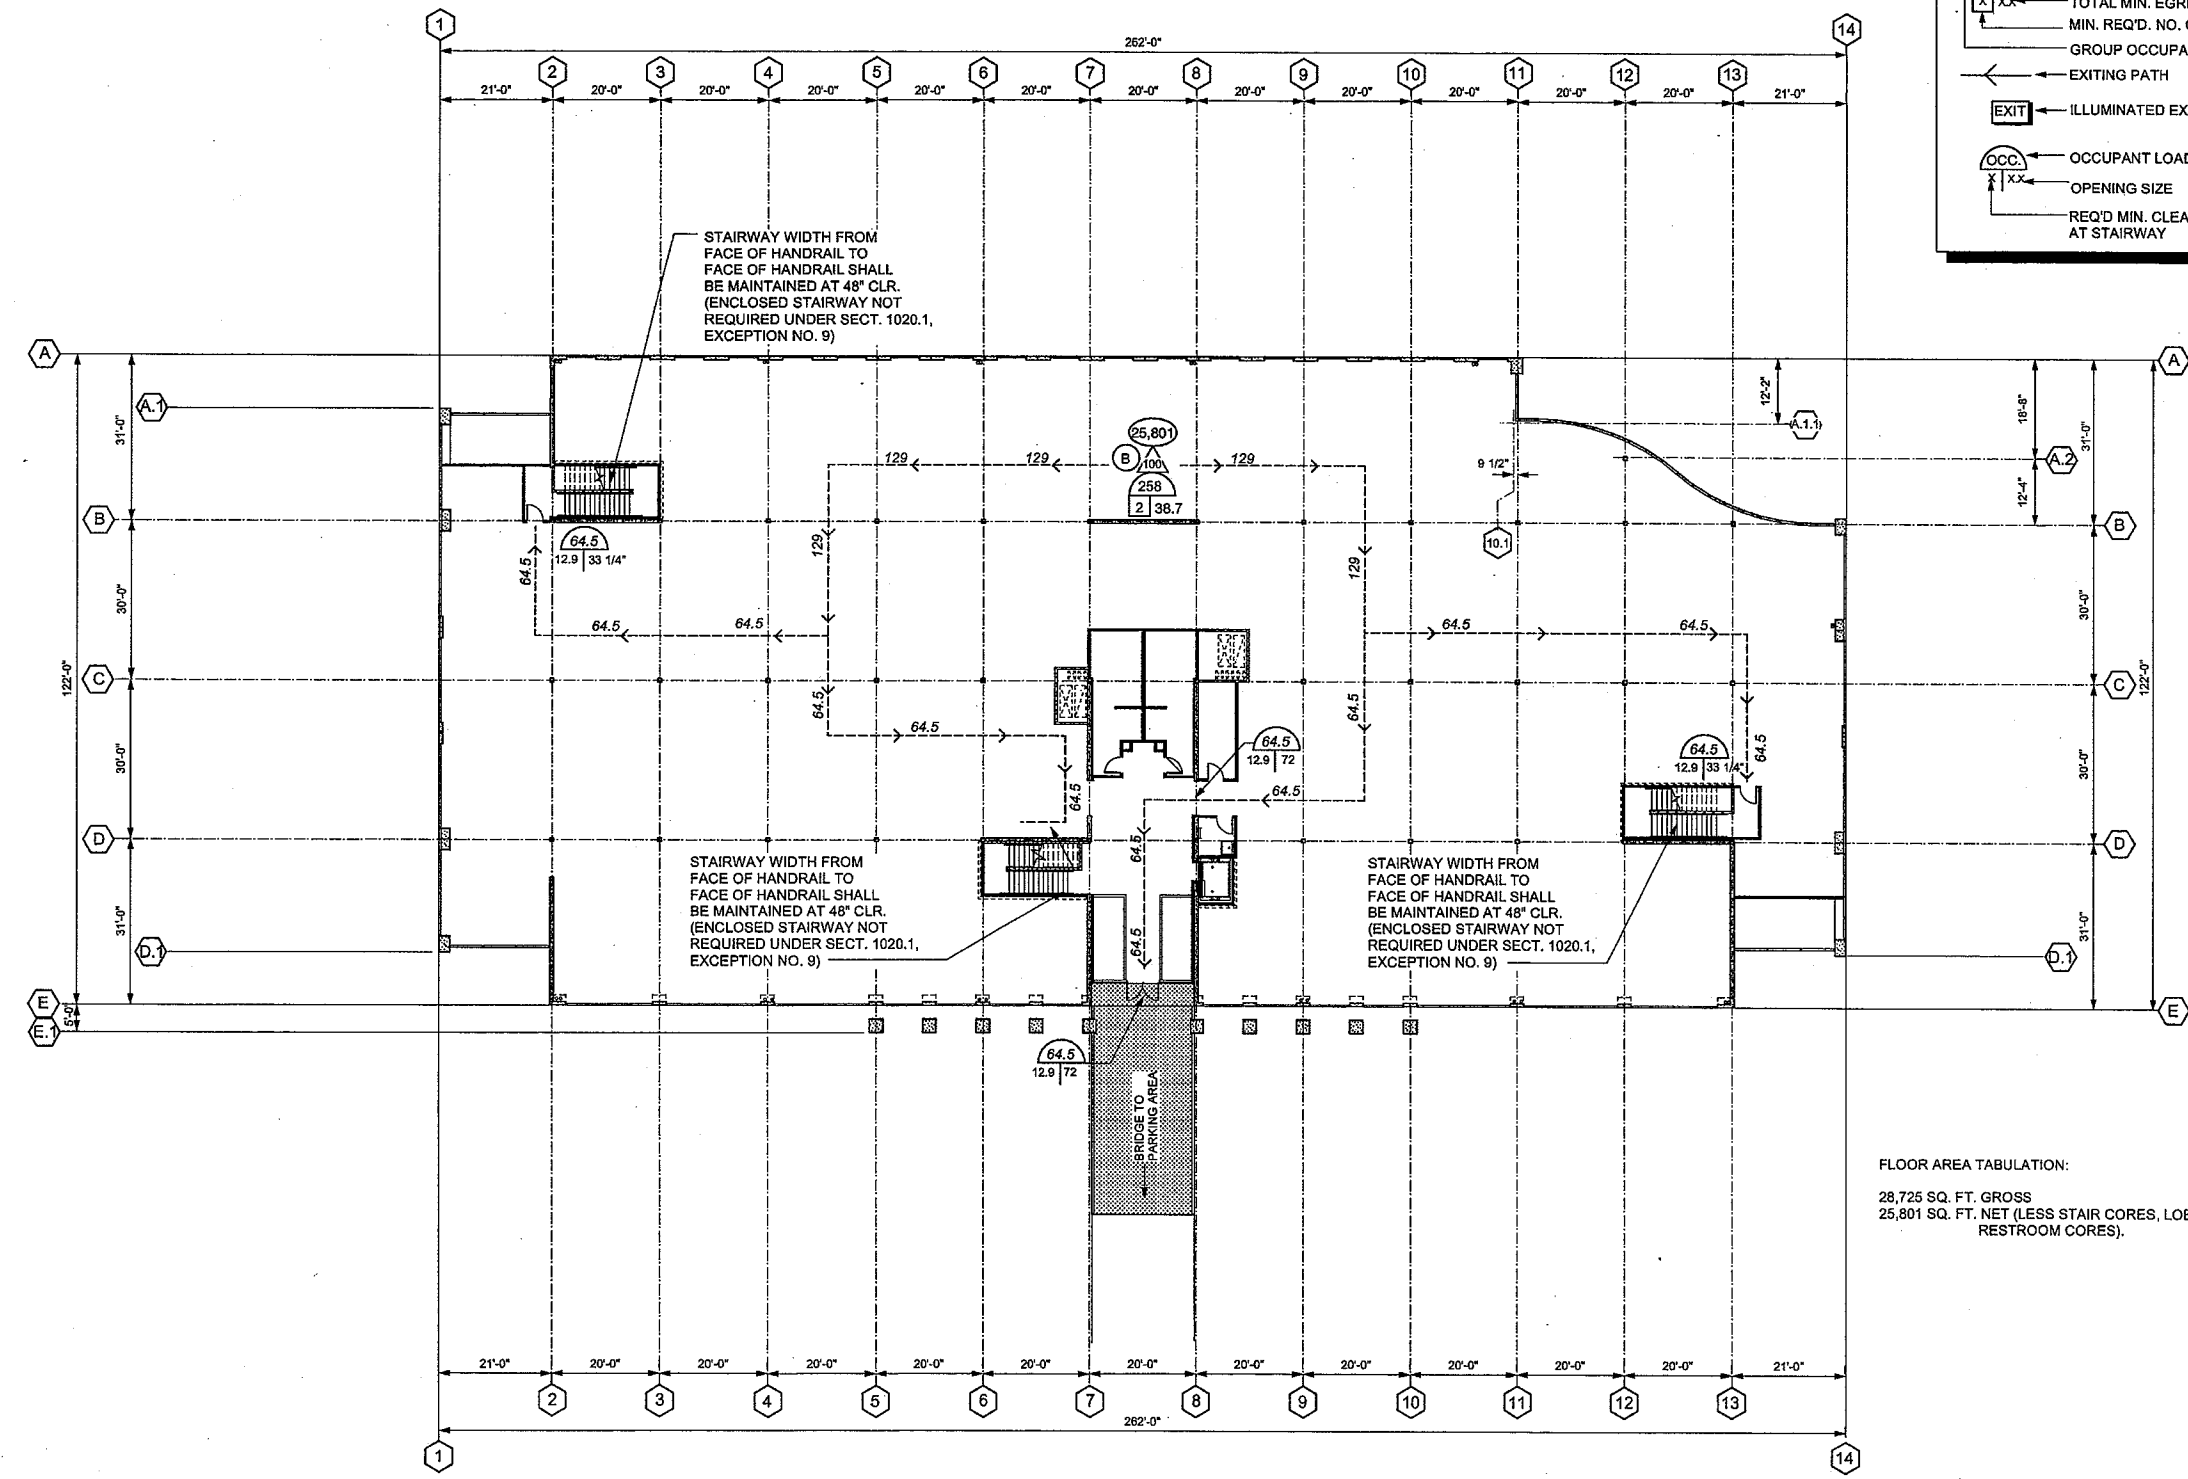


SC: 1/16" = 1'-0"  
**SECOND EXITING FLOOR PLAN**

**CABRILLO BUSINESS PARK BUILDING NO. 4**  
 HOLLISTER AVE  
 GOLETA, CA


**SECOND FLOOR EXITING PLAN**

Date: 11-18-09  
 Job: 0904  
 Drawn by:  
 Sheet:


**A-9**

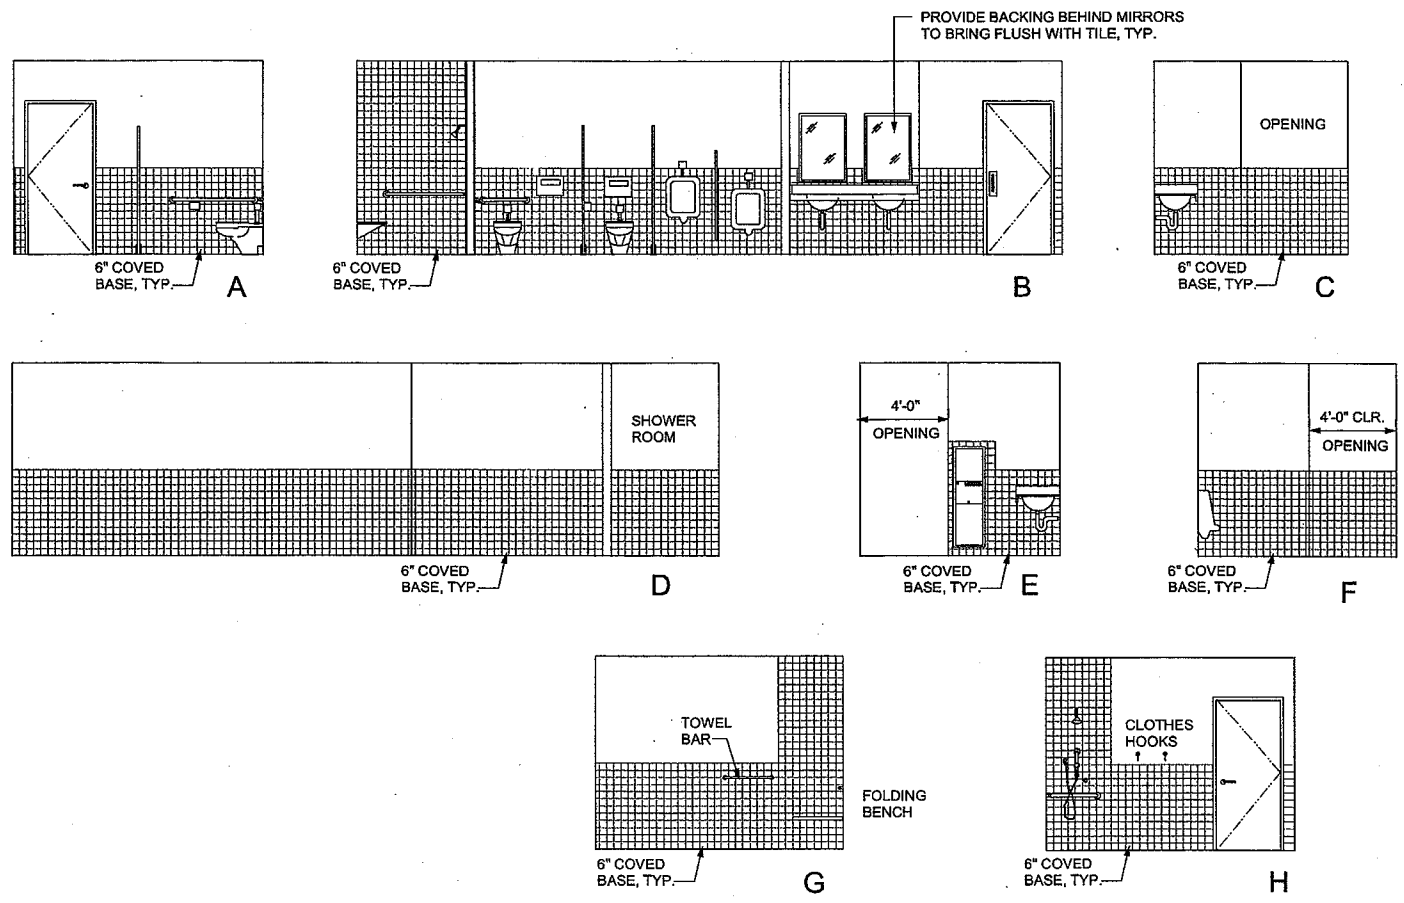

MEN'S RESTROOM - INTERIOR ELEVATIONS 3

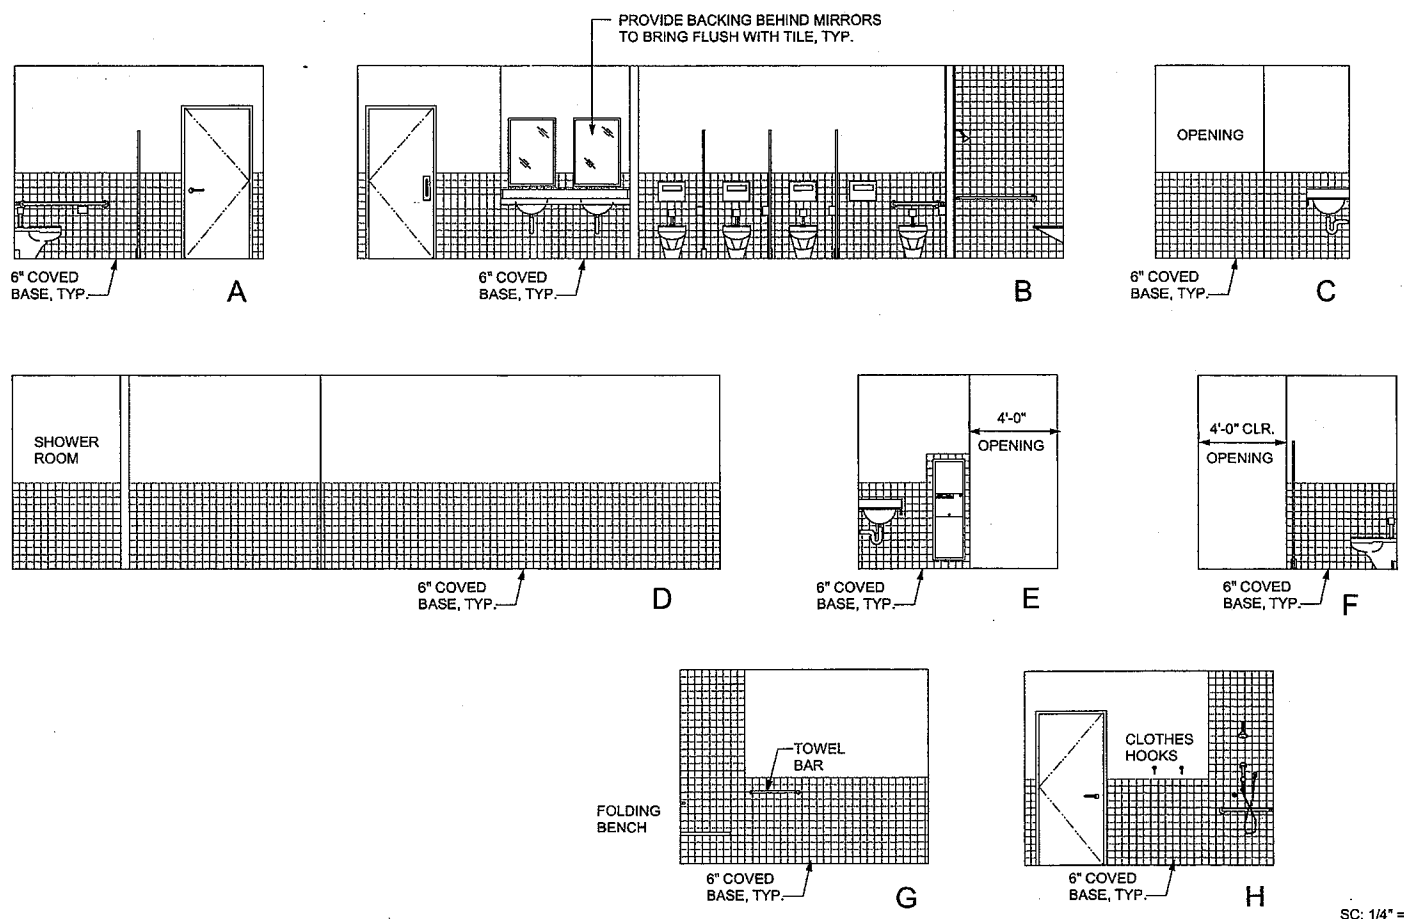

WOMEN'S RESTROOM - INTERIOR ELEVATIONS 4

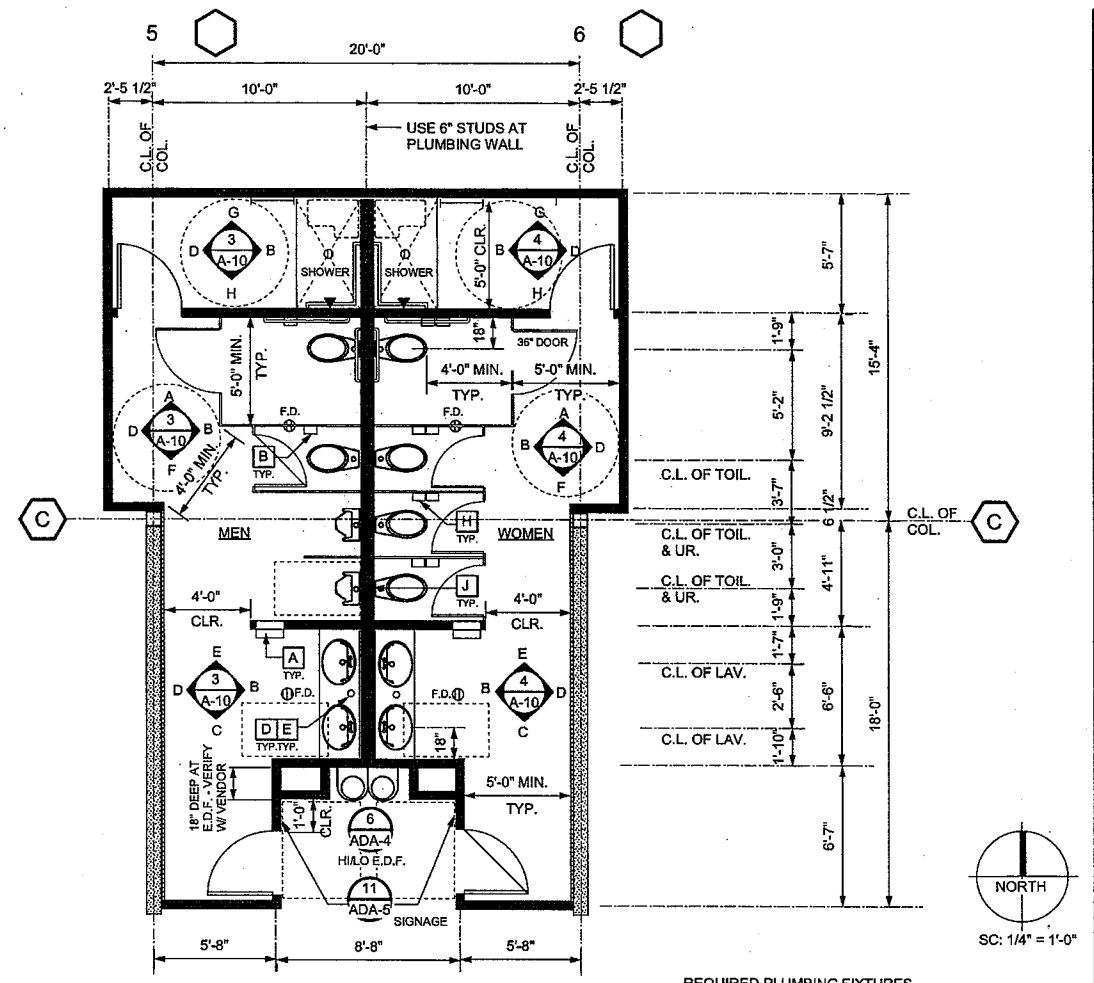

REQUIRED PLUMBING FIXTURES  
SECOND LEVEL = 27,349 SF (NET - LESS RESTROOMS STAIRS AND MECH. ROOMS)

OCCUPANT LOAD (CPC 2007 TABLE 4-1)  
27,349 = 137 137 = 69 / PER SEX  
200 2

MEN	WOMEN
3 W/C	5 W/C
1 UR	
2 LAV	2 LAV

(WC / URINAL REDUCTION PER TABLE 4-1 NOTE 4)

NOTE:  
1. FIXTURES TO BE LOW FLOW TYPE.  
2. LAVS AND DRINKING FOUNTAIN SHALL BE EQUIPPED WITH SELF-CLOSING VALVES.  
3. SEE SHEET D-4 FOR ACCESSORIES [A] TYPICAL.  
4. SEE SHEETS ADA-1 THROUGH ADA-5 FOR DISABLE ACCESS NOTES AND DETAILS.  
5. SEE DETAIL 8 / D-7 FOR BACKING AT GRAB BARS, TYP.  
6. FOR DIMENSIONS NOT SHOWN SEE DETAILS [3] THRU [10] ADA-5

RESTROOMS - FIRST FLOOR 1

**RESTROOM FINISHES**

CERAMIC TILE FLOORS (INC. SHOWER): DAL TILE KEYSTONE 1" X 1" DK04 "BEACH":

CERAMIC TILE WALLS & WAINSCOT: DAL TILE GROUP 1 4" X 4" MATTE ALMOND X735

CERAMIC TILE ACCENT DETAIL: DAL TILE GROUP 1 4" X 4" MATTE URBAN PUTTY 0761 & ELEMENTAL TAN 0766 (SEE DETAIL)

CERAMIC TILE BASE: DAL TILE GROUP 1 4" X 4" MATTE ALMOND X735

SANDED GROUT: CUSTOMS BUILDING PRODUCTS NO. 283 "BONE"


TOILET PARTITIONS: METPAR FLOOR MOUNTED - STAINLESS STEEL

WALL PAINT (ABOVE TILE): DUNN EDWARDS NO. DE6197 "MODERN IVORY"

CEILING PAINT: DUNN EDWARDS NO. DE6198 "CREAM WAVE"

INTERIOR DOORS: DUNN EDWARDS NO. DE6199 "PALE BEACH"

PLASTIC LAMINATE COUNTER: FORMICA MATTE FINISH 7240-58 "PARCHMENT"

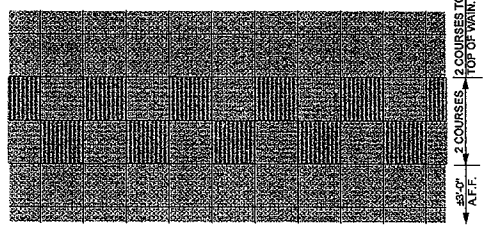

TILE DETAIL 2



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NO. 934  
EXP. 12-31-10


Revisions


**CABRILLO BUSINESS PARK BUILDING NO. 4**  
HOLLISTER AVE  
GOLETA, CA

**RESTROOM PLANS**


Date: 11-18-09  
Job: 0904  
Drawn by:  
Sheet :



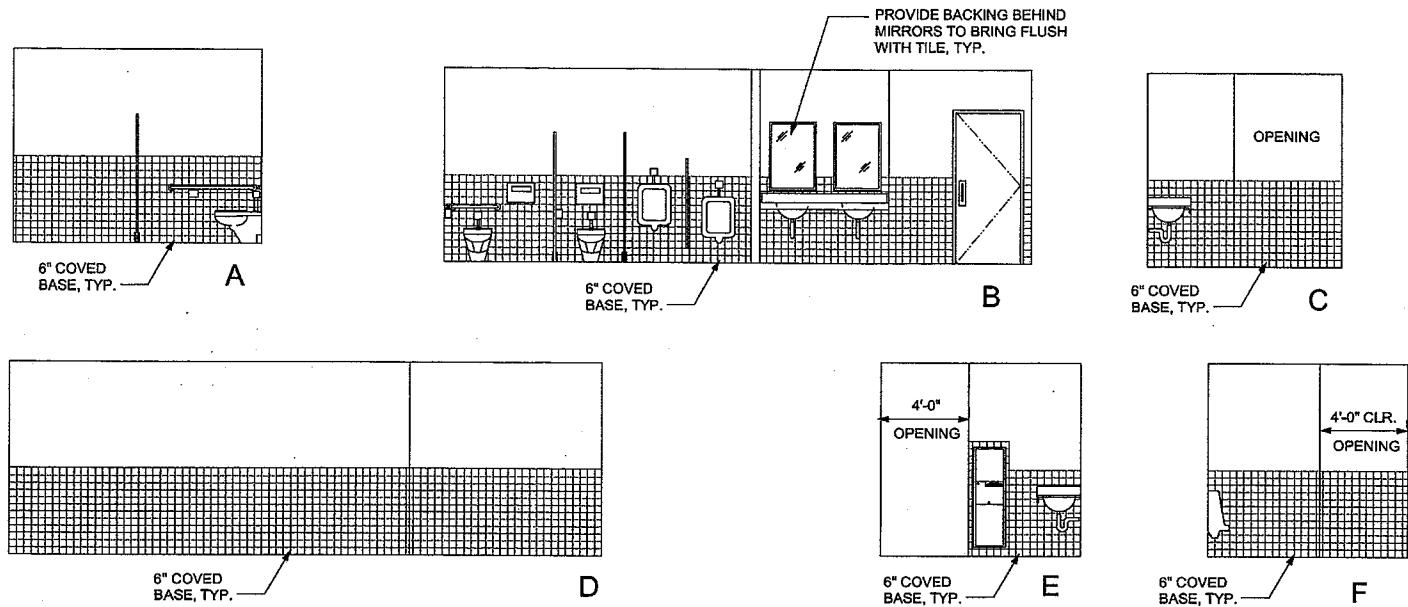


SC: 1/4" = 1'-0"

MEN'S RESTROOM - INTERIOR ELEVATIONS 3

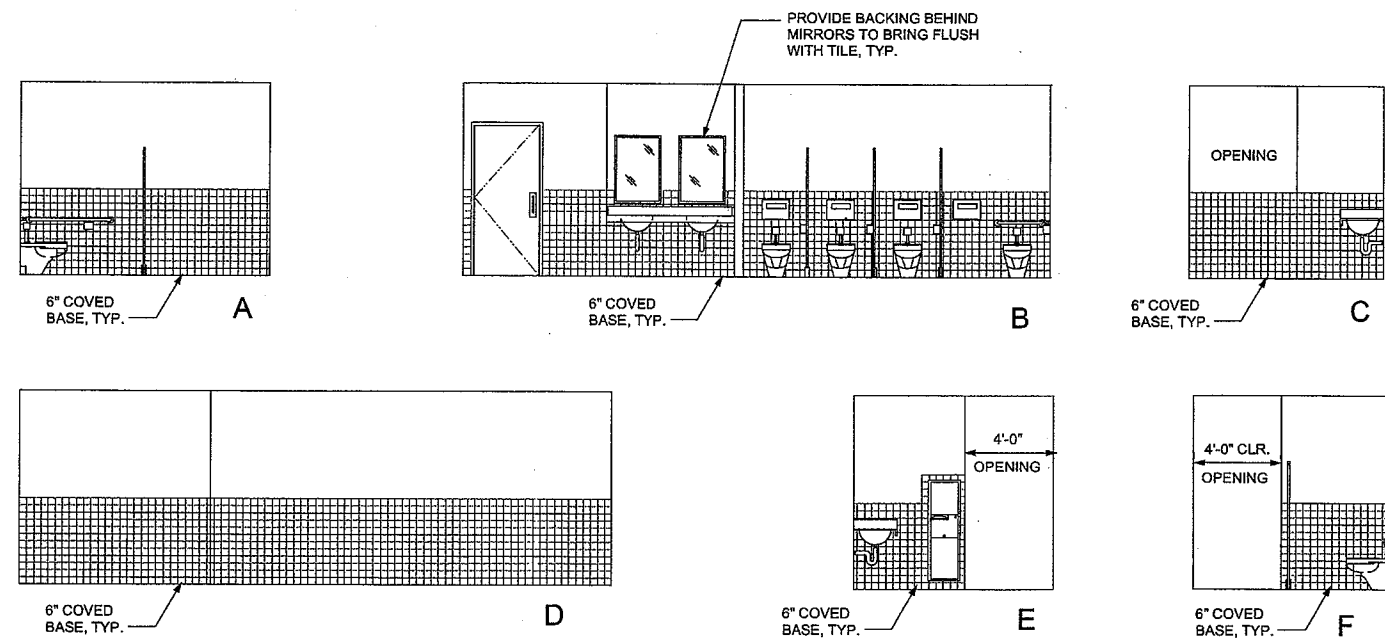

SC: 1/4" = 1'-0"

WOMEN'S RESTROOM - INTERIOR ELEVATIONS 4

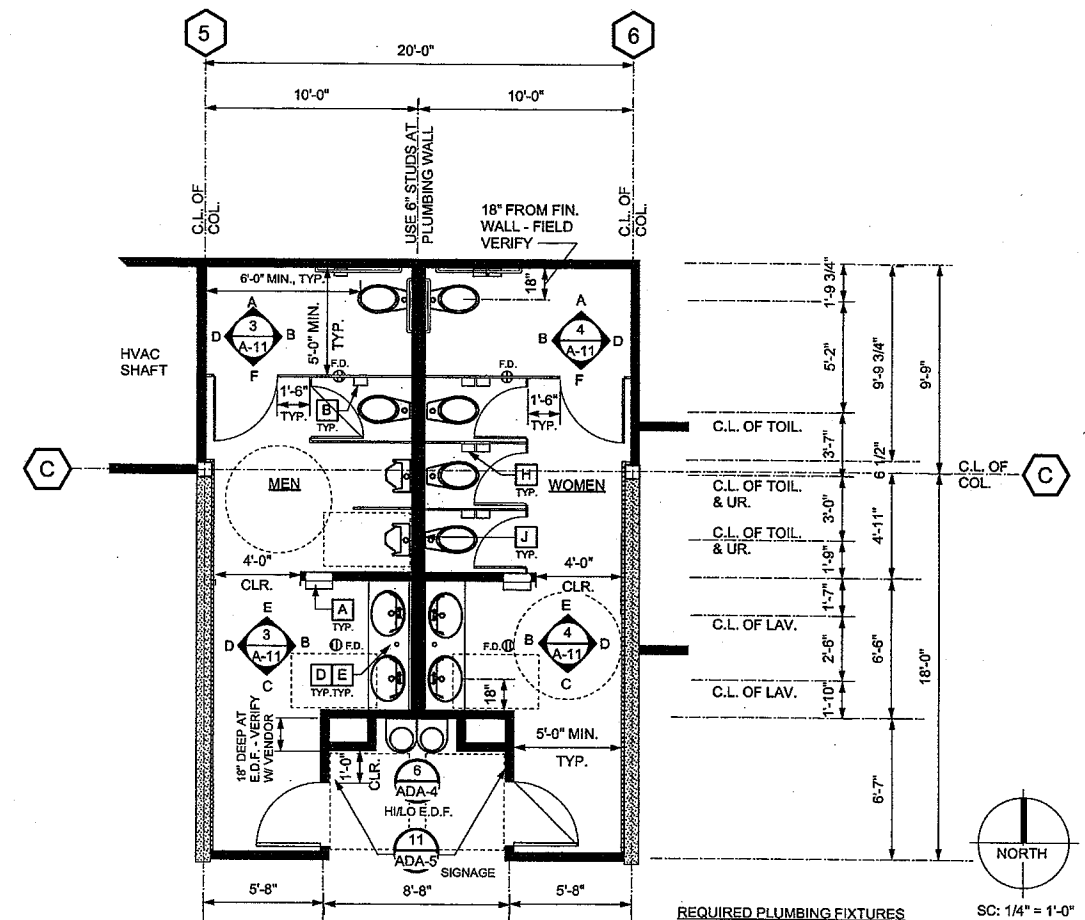

NOTE:

1. FIXTURES TO BE LOW FLOW TYPE.
2. LAV'S AND DRINKING FOUNTAIN SHALL BE EQUIPPED WITH SELF-CLOSING VALVES.
3. SEE SHEET D-4 FOR ACCESSORIES [A] TYPICAL.
4. SEE SHEETS ADA-1 THROUGH ADA-5 FOR DISABLE ACCESS NOTES AND DETAILS.
5. SEE DETAIL 8 / D-7 FOR BACKING AT GRAB BARS, TYP.
6. FOR DIMENSIONS NOT SHOWN SEE DETAILS [3] THRU [10] ADA-5

REQUIRED PLUMBING FIXTURES  
SECOND LEVEL = 27,976 SF (NET-LESS RESTROOMS, STAIRS AND MECH. ROOM)


OCCUPANT LOAD (CPC 2007 TABLE 4-1)  
27,976 = 140 140 = 70 / PER SEX  
200 2

MEN	WOMEN
3 W/C	5 W/C
1 UR	
2 LAV	2 LAV
(WC / URINAL REDUCTION PER TABLE 4-1 NOTE 4)	

RESTROOMS - 2ND. FLOOR 1

RESTROOM FINISHES


CERAMIC TILE FLOORS (INC. SHOWER):	DAL TILE KEYSTONE 1" X 1" DK04 "BEACH"
CERAMIC TILE WALLS & WAINSCOT:	DAL TILE GROUP 1 4" X 4" MATTE ALMOND X735
CERAMIC TILE ACCENT DETAIL:	DAL TILE GROUP 1 4" X 4" MATTE URBAN PUTTY 0761 & ELEMENTAL TAN 0766 (SEE DETAIL)
CERAMIC TILE BASE:	DAL TILE GROUP 1 4" X 4" MATTE ALMOND X735
SANDED GROUT:	CUSTOMS BUILDING PRODUCTS NO. 283 "BONE"
TOILET PARTITIONS:	METPAR FLOOR MOUNTED - STAINLESS STEEL
WALL PAINT (ABOVE TILE):	DUNN EDWARDS NO. DE6197 "MODERN IVORY"
CEILING PAINT:	DUNN EDWARDS NO. DE6198 "CREAM WAVE"
INTERIOR DOORS:	DUNN EDWARDS NO. DE6199 "PALE BEACH"
PLASTIC LAMINATE COUNTER:	FORMICA MATTE FINISH 7240-58 "PARCHMENT"

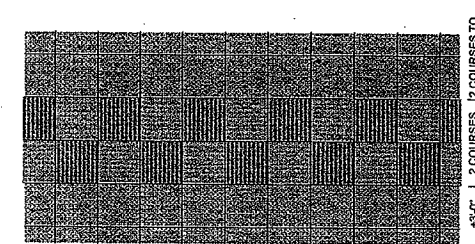

TILE DETAIL  
TYPICAL ALL TILE WALLS



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NO. 934
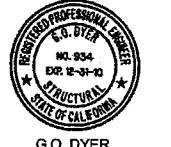
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Revisions

CABRILLO  
BUSINESS PARK  
BUILDING NO. 4

HOLLISTER AVE  
GOLETA, CA

RESTROOM  
PLANS

Date:

11-18-09

Job:

0804

Drawn by:

Sheet:

A-11

CEILING JOIST SCHEDULE						
MARK	JOIST SIZE	SPACING	MAX. SPAN	HT. ABV. FLOOR	GYP. BD.	REMARKS
CJ-1	20 XHD 600	16" O.C.	12'-0"	8'-0"	BOTTOM	SEE NOTE # 4
CJ-2	20 XHD 600	16" O.C.	10'-0"	8'-0"	BOTTOM	SEE NOTE # 4
CJ-3	20 HDS 400	16" O.C.	5'-0"	9'-0"	BOTTOM	N.A.

**PRODUCT IDENTIFICATION CODE**


CEMCO (ICC - ESR 3403P) DEFINITION: ECS OR HDS FLANGE = 1.25" CS OR XHD FLANGE = 1.625" XCS OR XXHD FLANGE = 2.00"

THE CONTRACTOR SHALL INQUIRE FROM JDO/Dyer, L.L.P. OR CONSULT I.C.B.O. REPORTS FOR ANY CLARIFICATION PRIOR TO ORDERING AND INSTALING METAL STUDS & JOISTS. THE FINAL ACCEPTANCE OF ANY ERRORS IN CONSTRUCTION IS WITH ENGINEER-OF-RECORD. SUBCONTRACTOR SHALL PROVIDE SHOP DRAWINGS FOR METAL STUD FRAMING THAT HAS A DIFFERENT I.C.B.O. NUMBER THAN ABOVE.

- NOTES:
- SEE GENERAL NOTES SECTION 20 ON SHEET D-1 FOR INSULATION.
  - FOR STRUCTURAL GENERAL NOTES SEE SHEET D-2.
  - WHERE WALLS RUN PARALLEL TO CEILING JOIST, PROVIDE HORIZONTAL BLOCKING PER 12/D-7.
  - PROVIDE CONT. TOP FLANGE LATERAL SUPPORT WITH 20 GAUGE X 1 1/2" WIDE STRAP OVER BLOCKING AT MAX. 8'-0" FEET SPACING WITH THE SAME GAUGE & SIZE BLOCKING AS THE CEILING JOISTS PER 12/D-7, WHERE CEILING IS NOT COVERED ON TOP AND OVER 8'-0" SPANS.
  - SELF-TAPPING / SELF DRILLING FASTENERS SHALL BE DART OR EQ. MANUFACTURED BY COMPASS INTERNATIONAL (ICBO ER-5202).
  - PROVIDE DOUBLE JOISTS AS HEADERS OVER OPENINGS MATCHING THE GAUGE AND SIZE AS THE ADJACENT CEILING JOIST CONSTRUCTION, UNLESS REFERRED TO LINTIEL SCHEDULE AS DETAILED.
  - SEE ELECTRICAL PLANS FOR LIGHTING LAYOUT, MECHANICAL PLANS FOR DIFFUSER LAYOUT AND FIRE SPRINKLER PLANS FOR SPRINKLER HEAD LAYOUT.
  - TOP TRACK OF ALL METAL STUD WALLS SHALL BE CONTINUOUS OR PROPERLY SPLICED WITH 24" OVERLAP AND MINIMUM 12 - #8 SCREWS.
  - CONTINUOUS COLD ROLLED LATERAL BRACING, 16 GAGE, 3/4" x 1 1/2" (BLACK IRON) SHALL BE PROVIDED AT MAXIMUM SPACING OF 8'-0" O.C. ALONG THE HEIGHT WHERE GYP. BD. COVERING OCCURS AT ONE SIDE ONLY.

CEILING JOIST SCHEDULE AND NOTES

3

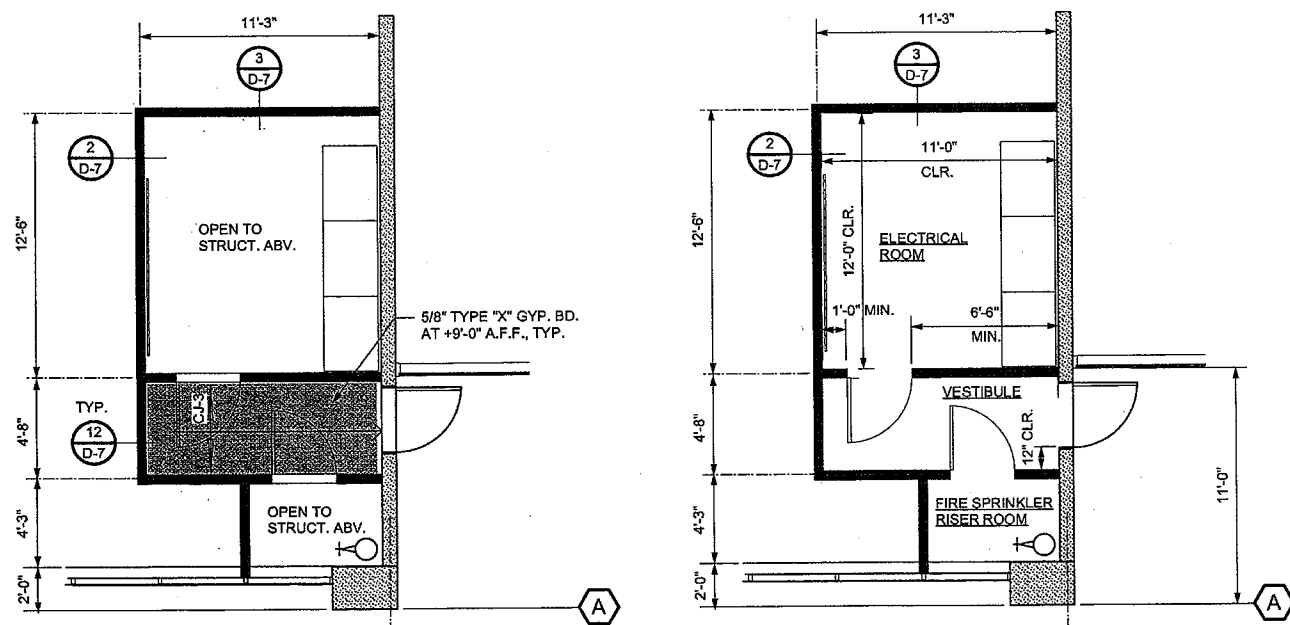


CEILING PLAN

FLOOR PLAN

NOTE:  
SEE TYPICAL NOTES AND JOIST SCHEDULE - SEE 3/A-11.1  
SEE ELECTRICAL FOR LIGHTING SEE MECHANICAL FOR VENTILATION

FLOOR AND CEILING PLAN

4

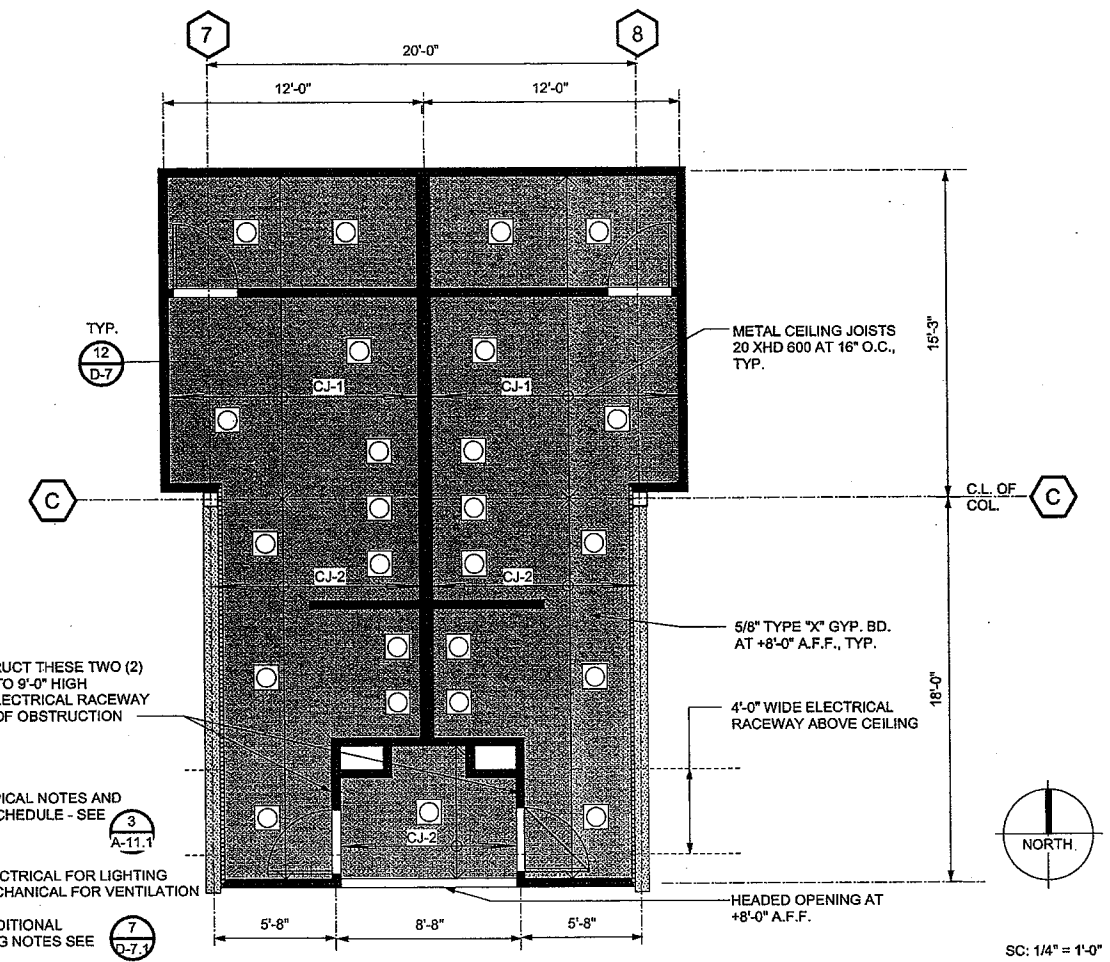


1ST. FLOOR RESTROOM - CEILING PLAN

1

CONSTRUCT THESE TWO (2) WALLS TO 9'-0" HIGH KEEP ELECTRICAL RACEWAY CLEAR OF OBSTRUCTION

NOTE:  
SEE TYPICAL NOTES AND JOIST SCHEDULE - SEE 3/A-11.1  
SEE ELECTRICAL FOR LIGHTING SEE MECHANICAL FOR VENTILATION  
FOR ADDITIONAL FRAMING NOTES SEE 7/D-7.1

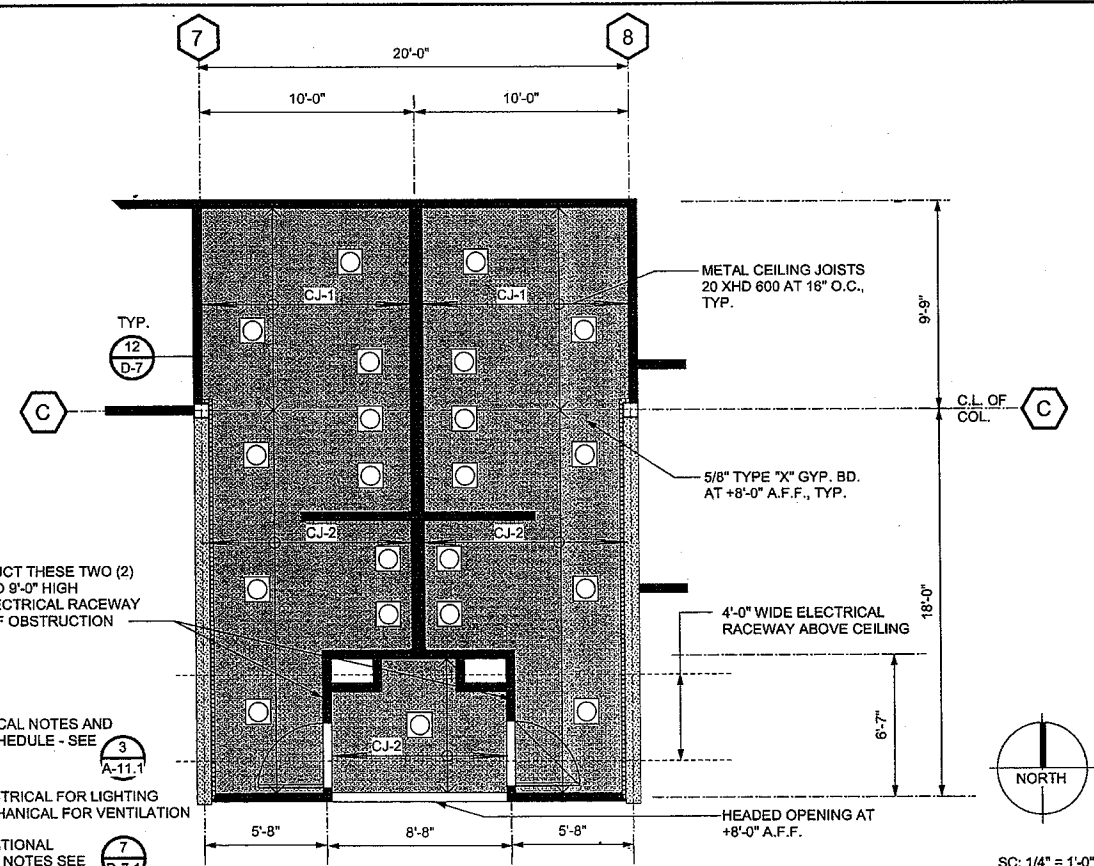

2ND. FLOOR RESTROOM - CEILING PLAN

2

CONSTRUCT THESE TWO (2) WALLS TO 9'-0" HIGH KEEP ELECTRICAL RACEWAY CLEAR OF OBSTRUCTION

NOTE:  
SEE TYPICAL NOTES AND JOIST SCHEDULE - SEE 3/A-11.1  
SEE ELECTRICAL FOR LIGHTING SEE MECHANICAL FOR VENTILATION  
FOR ADDITIONAL FRAMING NOTES SEE 7/D-7.1



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C 12762



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NO. 934

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**CABRILLO  
BUSINESS PARK  
BUILDING NO. 4**

HOLLISTER AVE  
GOLETA, CA



**ROOF PLAN**

Date: 11-18-09

Job: 0904

Drawn by:


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SC: 1/8" = 1'-0"

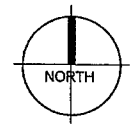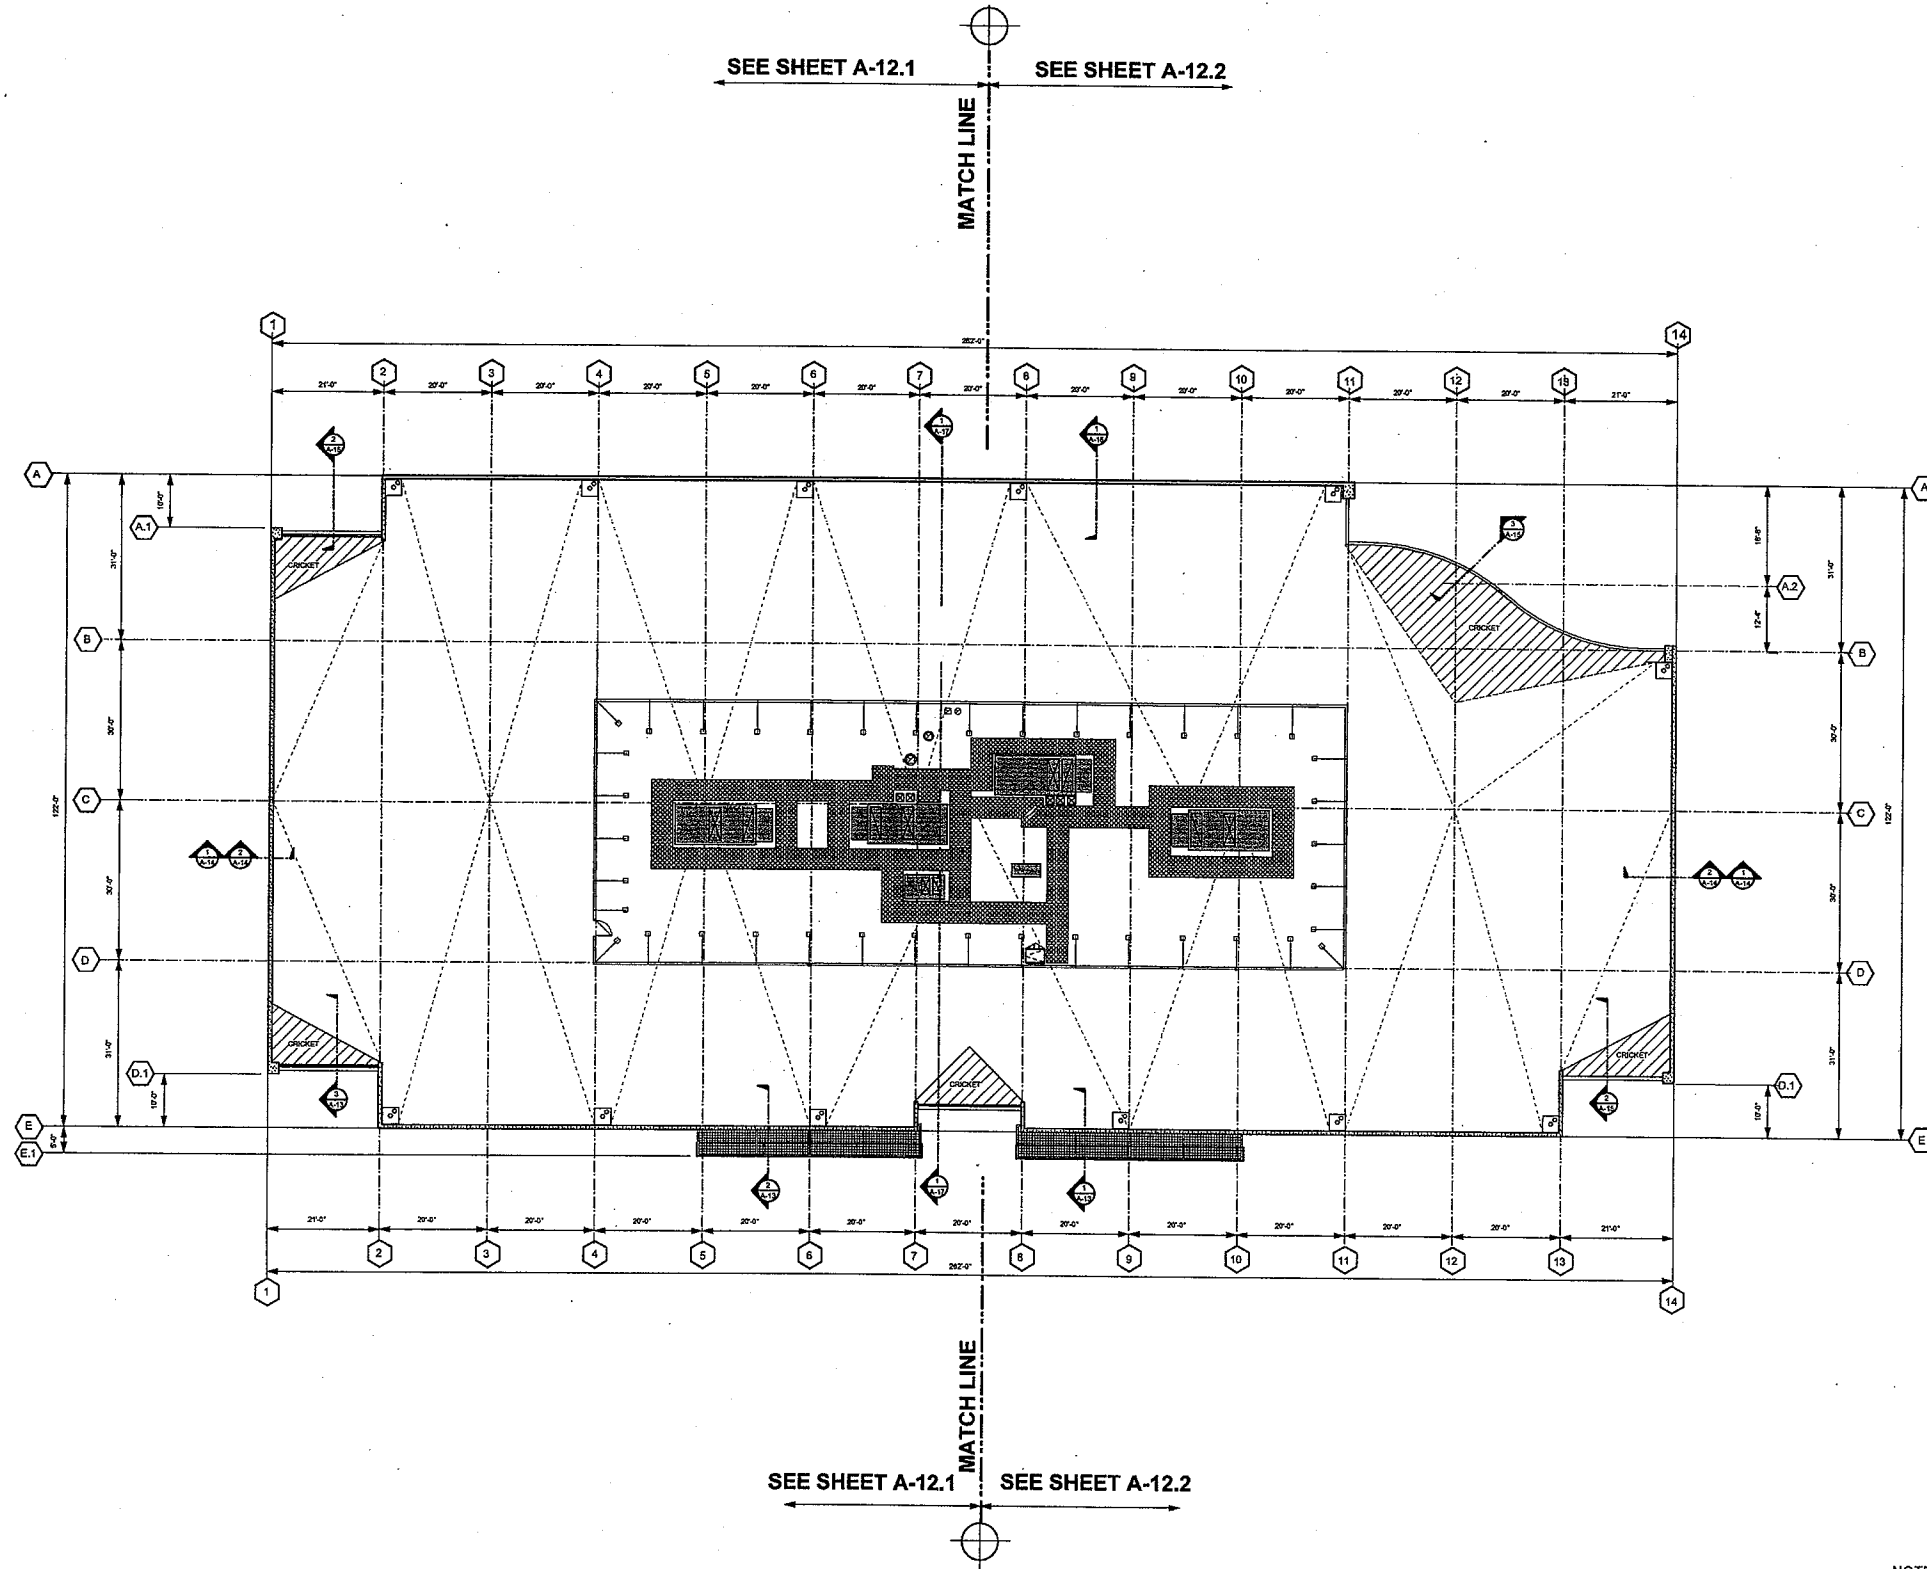NOTE: SEE SHEET S-5 FOR ROOF HEIGHTS


BUILT-UP ROOFING ASSEMBLY SHALL BE A DEFERRED SUBMITTAL. ROOF COVERING ASSEMBLIES SHALL BE AN ICC-ES OR UL LISTED CLASS A OR B FIRE-RESISTIVE ASSEMBLY COMPLYING WITH ASTM E108 OR UL 790. THE REPORT SHALL BE A PART OF THE SUBMITTAL AND SHALL ADDRESS WIND-LIFT INFORMATION.



SEE SHEET A-12.2 FOR CONTINUATION

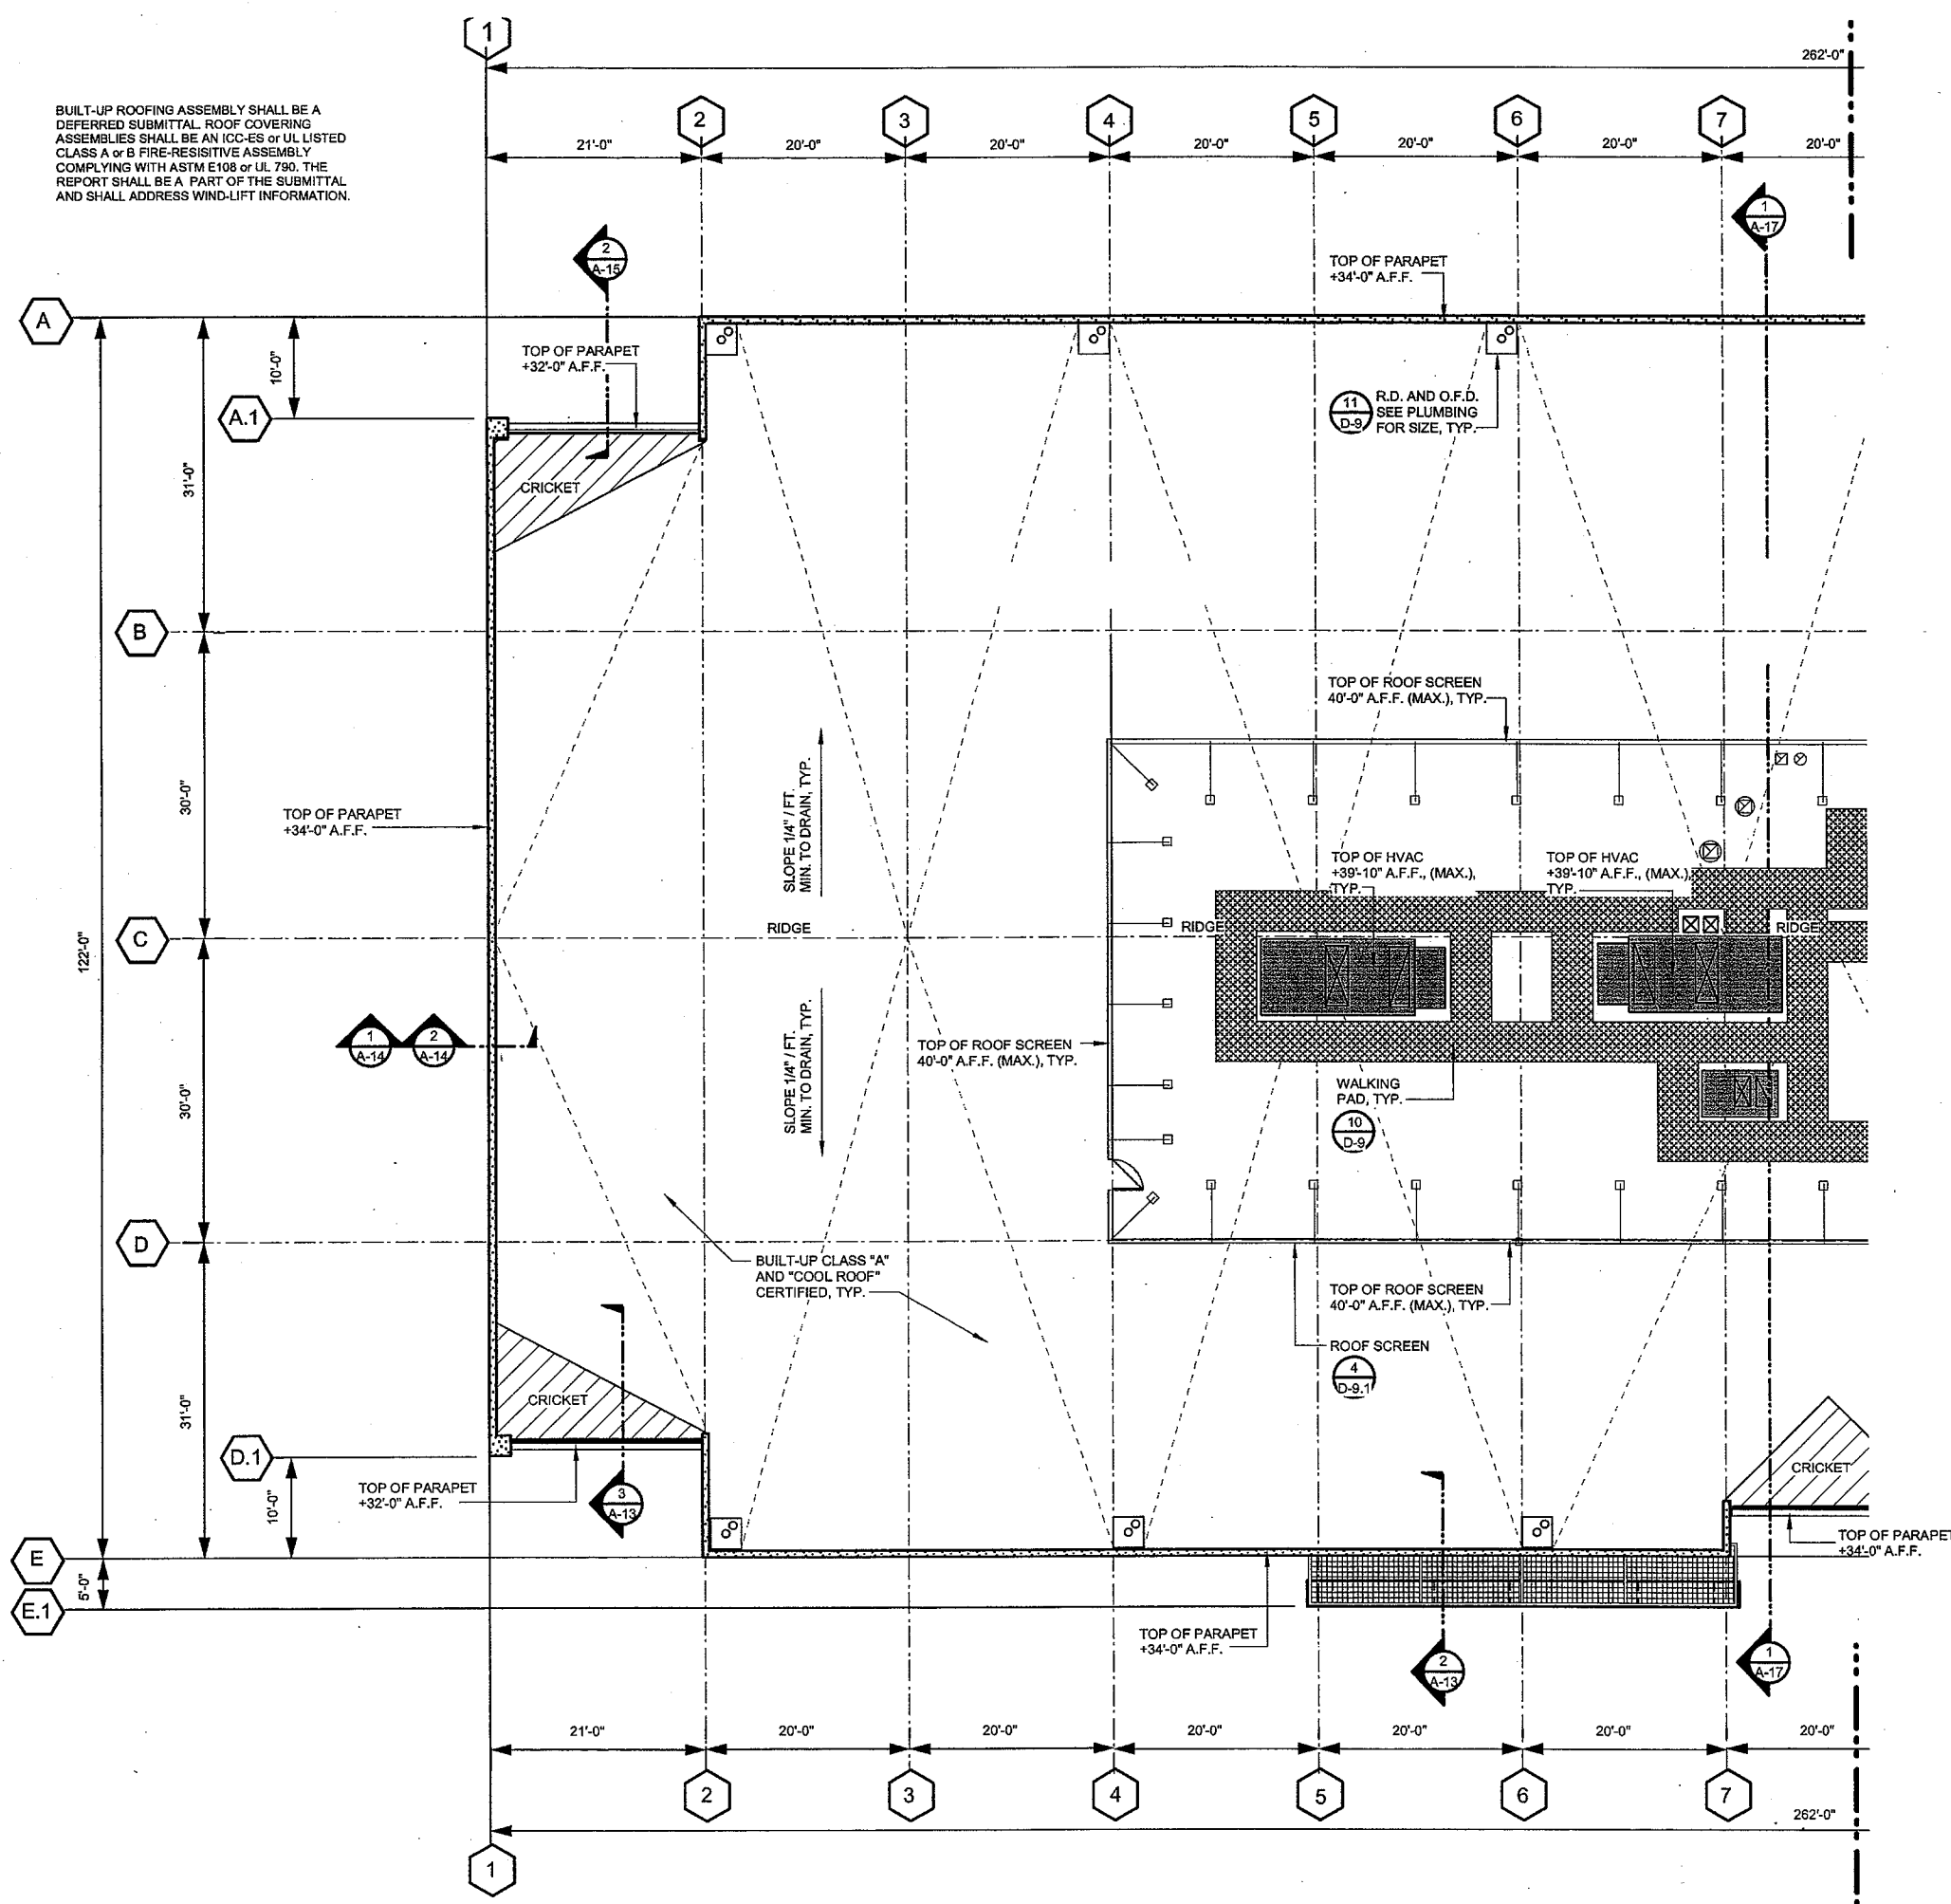

SC: 1/8" = 1'-0"  
NOTE: SEE SHEET S-5 FOR ROOF HEIGHTS

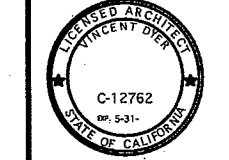

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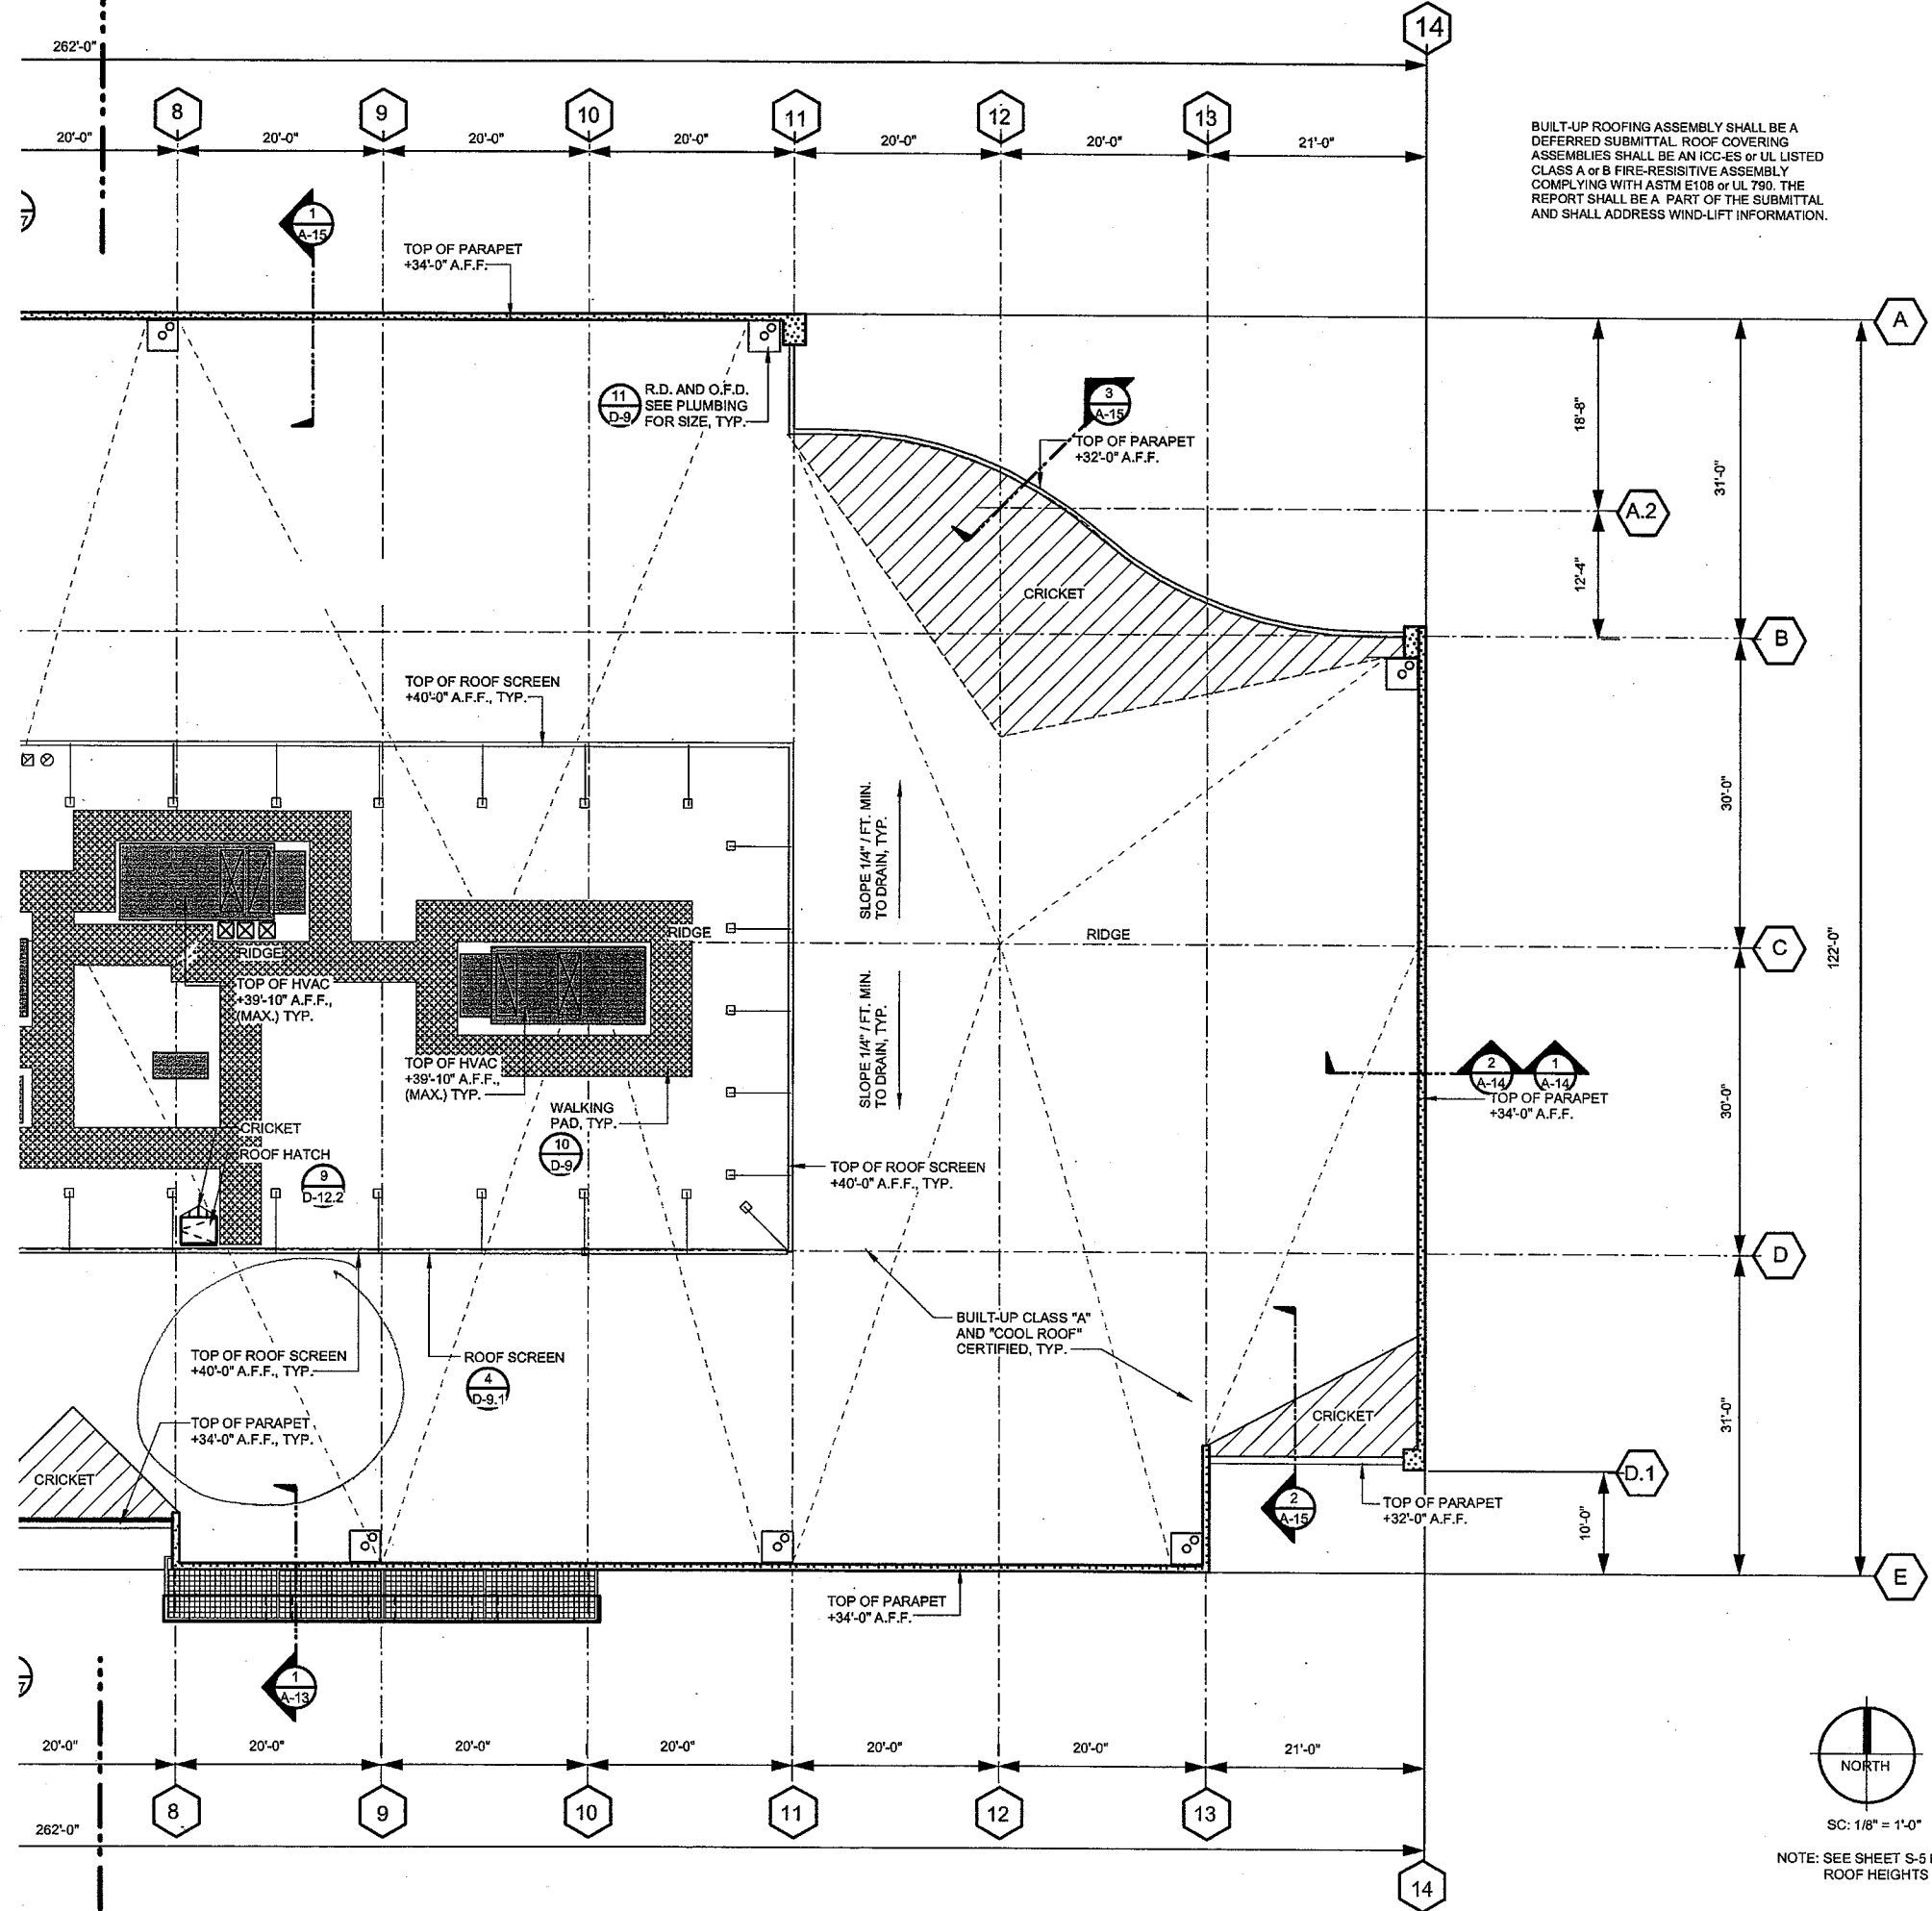
Revisions


**CABRILLO BUSINESS PARK BUILDING NO. 4**

HOLLISTER AVE  
GOLETA, CA

**PARTIAL ROOF PLAN**

Date: 11-18-09  
Job: 0904  
Drawn by:  
Sheet:



SEE SHEET A-12.1  
FOR CONTINUATION

BUILT-UP ROOFING ASSEMBLY SHALL BE A DEFERRED SUBMITTAL. ROOF COVERING ASSEMBLIES SHALL BE AN ICC-ES OR UL LISTED CLASS A OR B FIRE-RESISTIVE ASSEMBLY COMPLYING WITH ASTM E108 OR UL 790. THE REPORT SHALL BE A PART OF THE SUBMITTAL AND SHALL ADDRESS WIND-LIFT INFORMATION.

**JDO Dyer**  
Architecture | Engineering  
5376 N. Sterling Center Drive  
Westlake Village, CA 91361  
Phone 818.706.3997  
Fax 818.706.2453




G.O. DYER  
NO. 934  
EXPIRES 12-31-10

Revisions


**CABRILLO BUSINESS PARK BUILDING NO. 4**  
HOLLISTER AVE  
GOLETA, CA

**PARTIAL ROOF PLAN**

Date: 11-18-09  
Job: 0904  
Drawn by:  
Sheet:

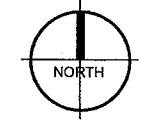


NOTE: SEE SHEET S-5 FOR ROOF HEIGHTS

**A-12.2**







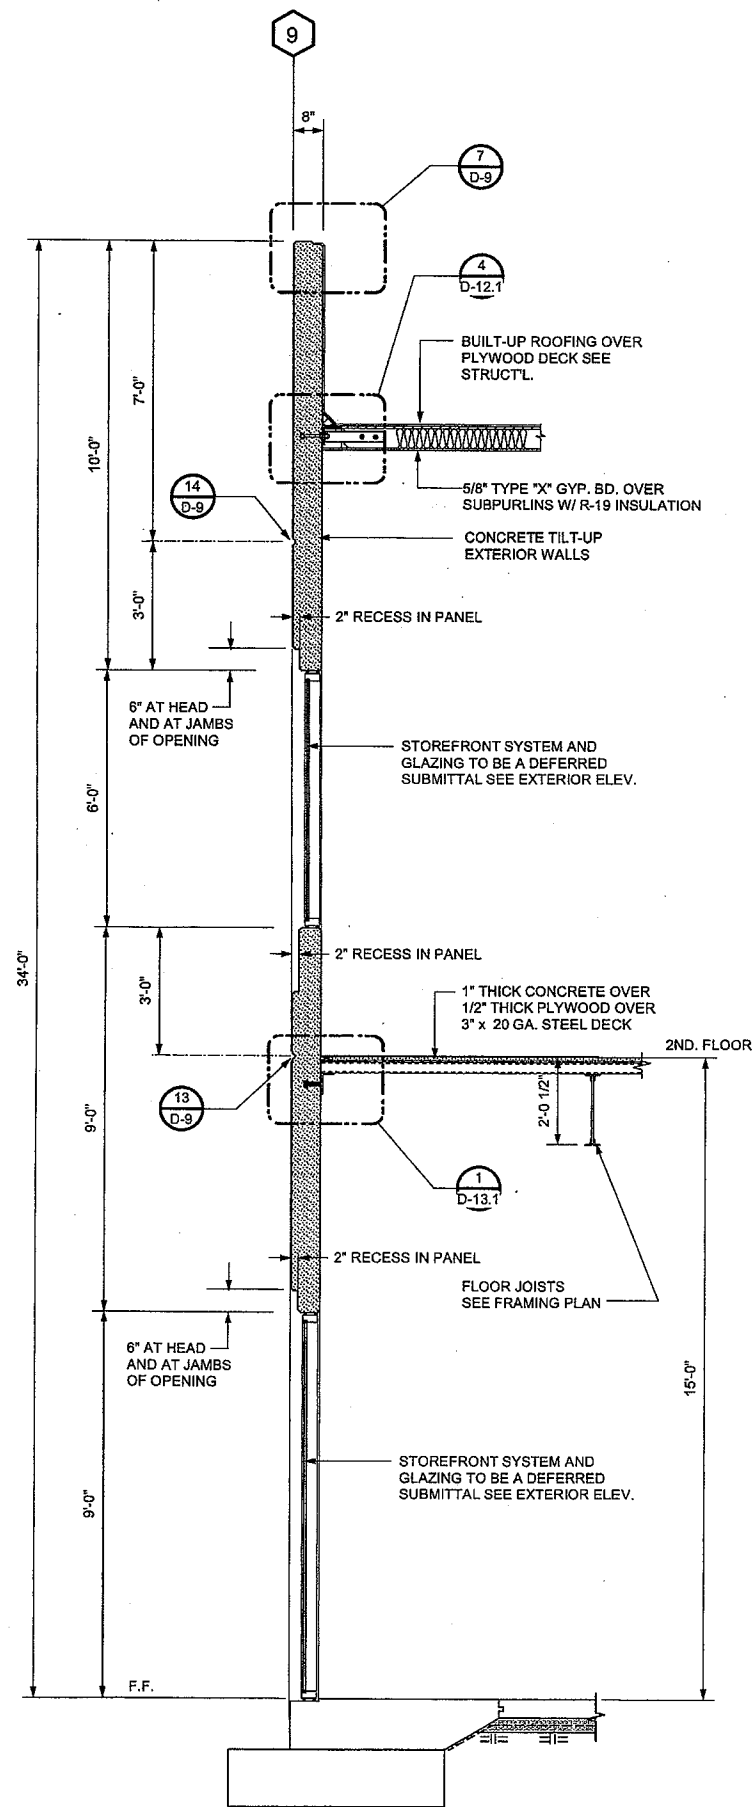


NOTE:  
SEE EXTERIOR ELEVATIONS  
FOR AREAS TO BE  
SANDBLASTED

SC: 1/2" = 1'-0"

TYPICAL WALL SECTION


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SC: 1/2" = 1'-0"

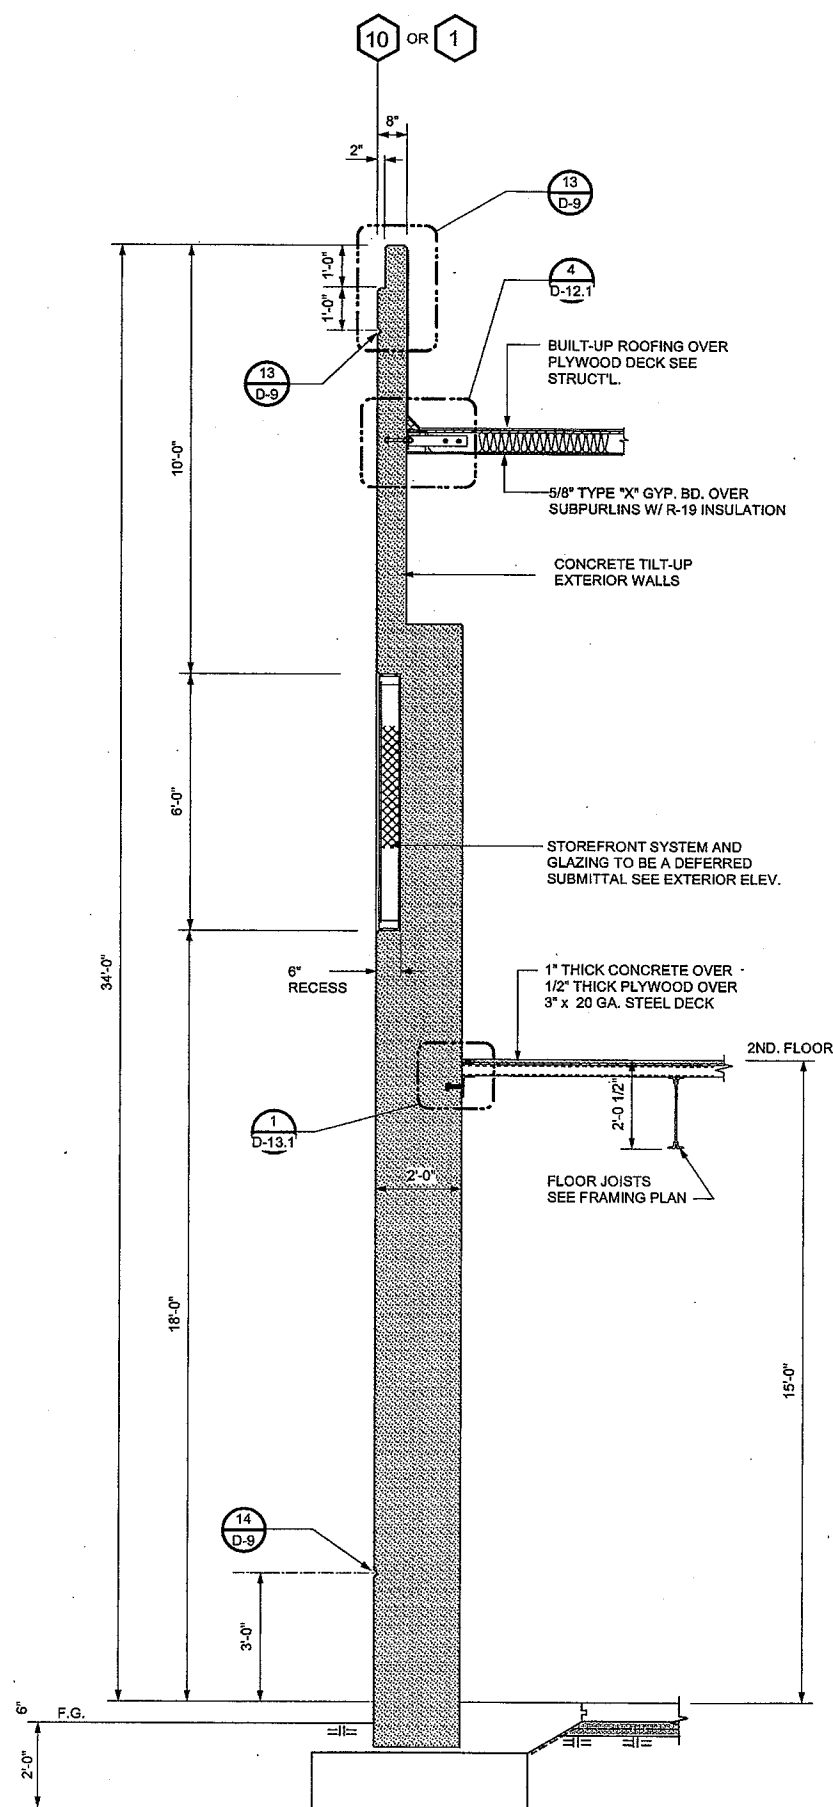TYPICAL WALL SECTION


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SC: 1/2" = 1'-0"

TYPICAL WALL SECTION

1

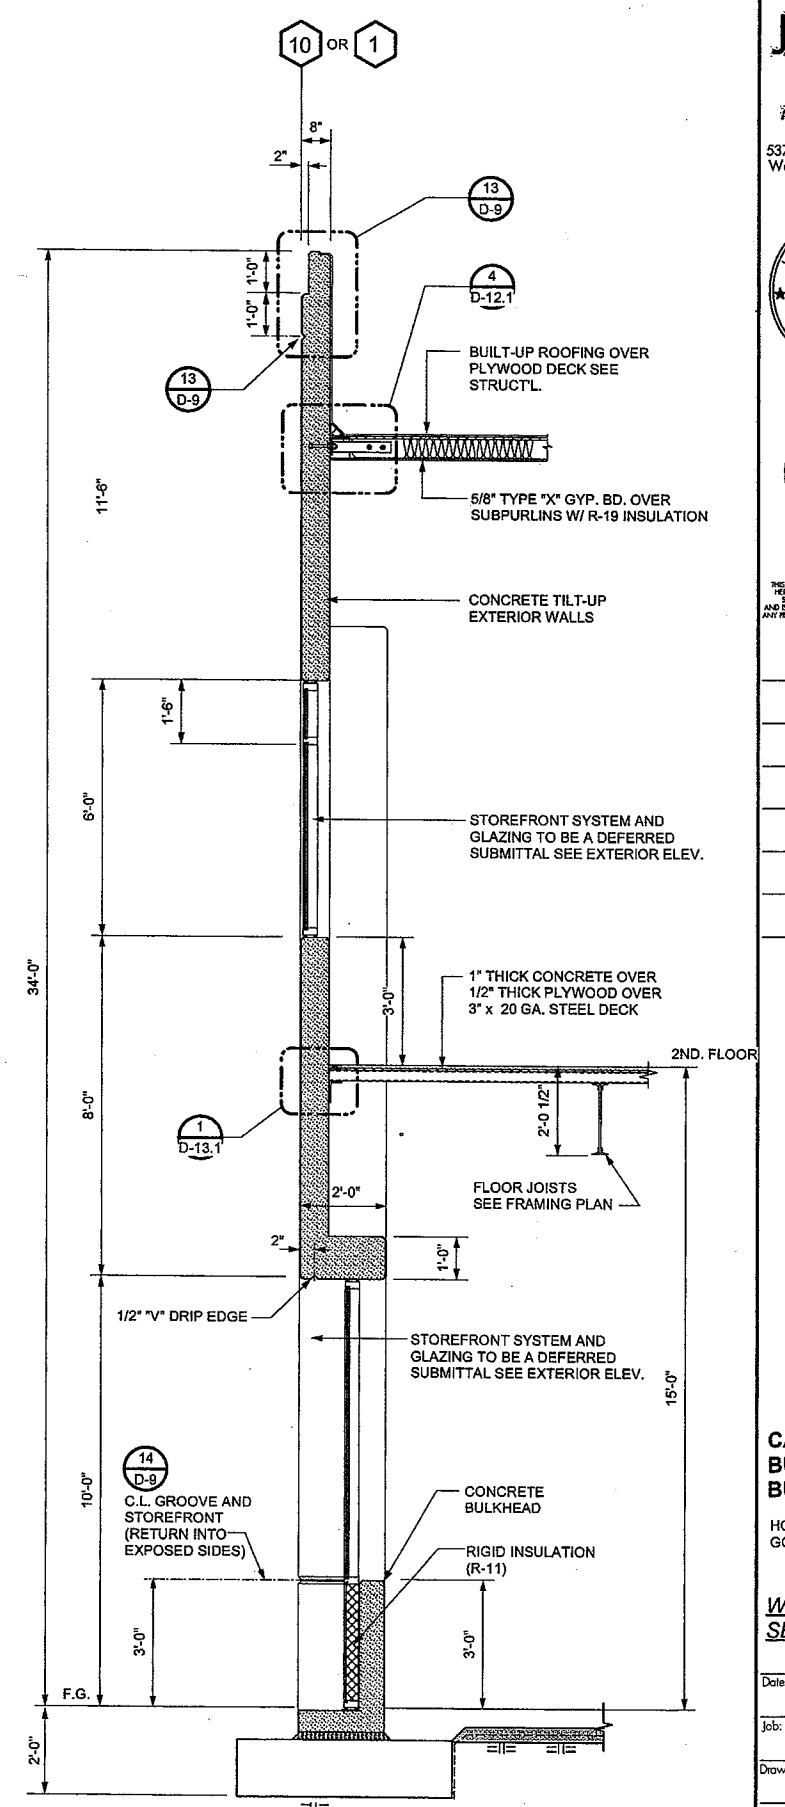

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NO. 934

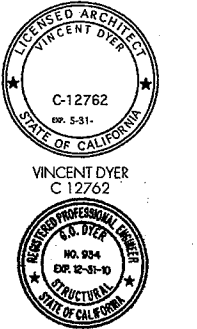Revisions


**CABRILLO  
BUSINESS PARK  
BUILDING NO. 4**  
HOLLISTER AVE  
GOLETA, CA

**WALL  
SECTIONS**

Date: 11-18-09  
Job: 0904  
Drawn by:  
Sheet:




VINCENT DYER  
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G.O. DYER  
NO. 934


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Revisions


SC: 1/2" = 1'-0"

SECTION AT FACETED CURTAIN WALL 3

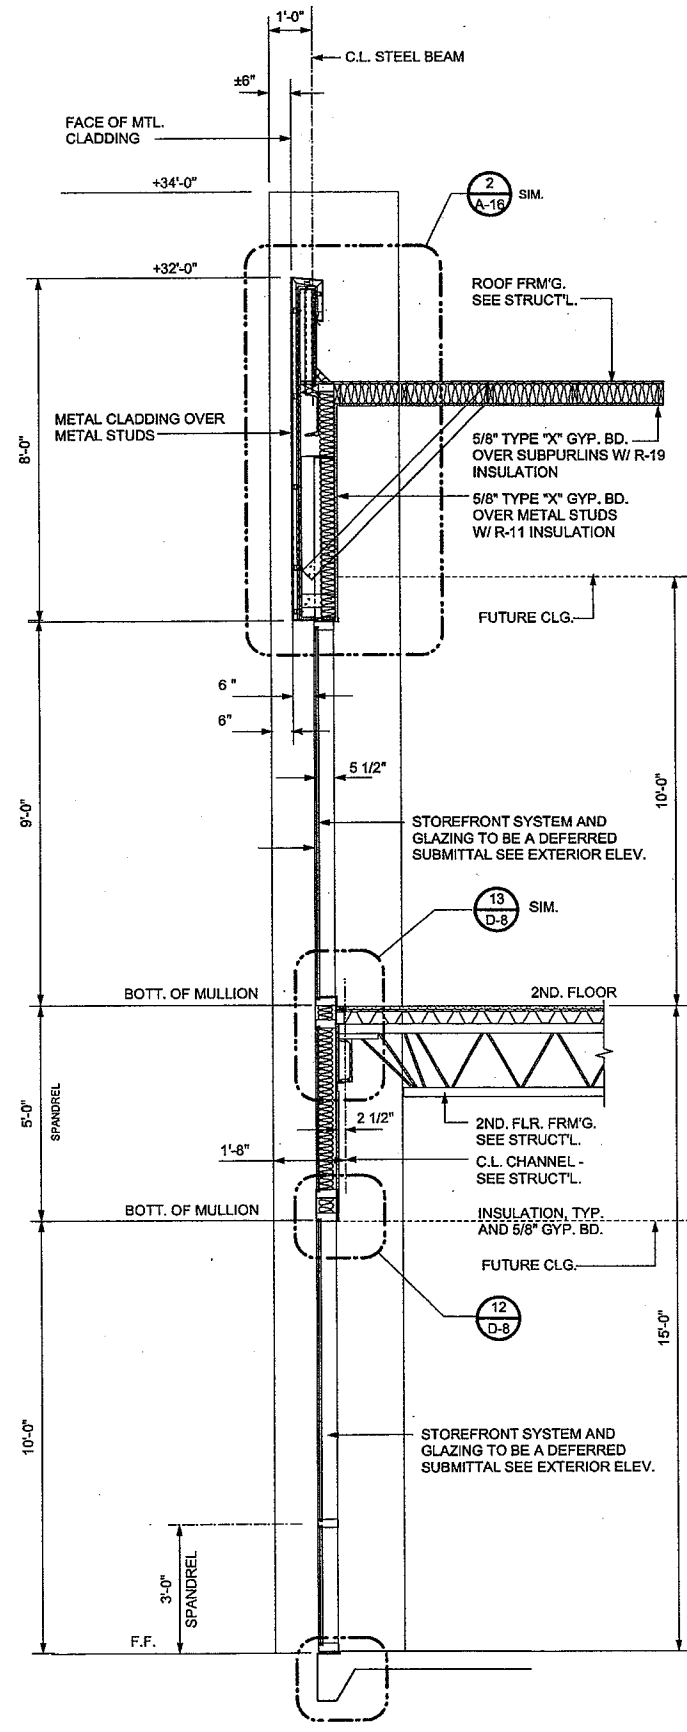

SC: 1/2" = 1'-0"

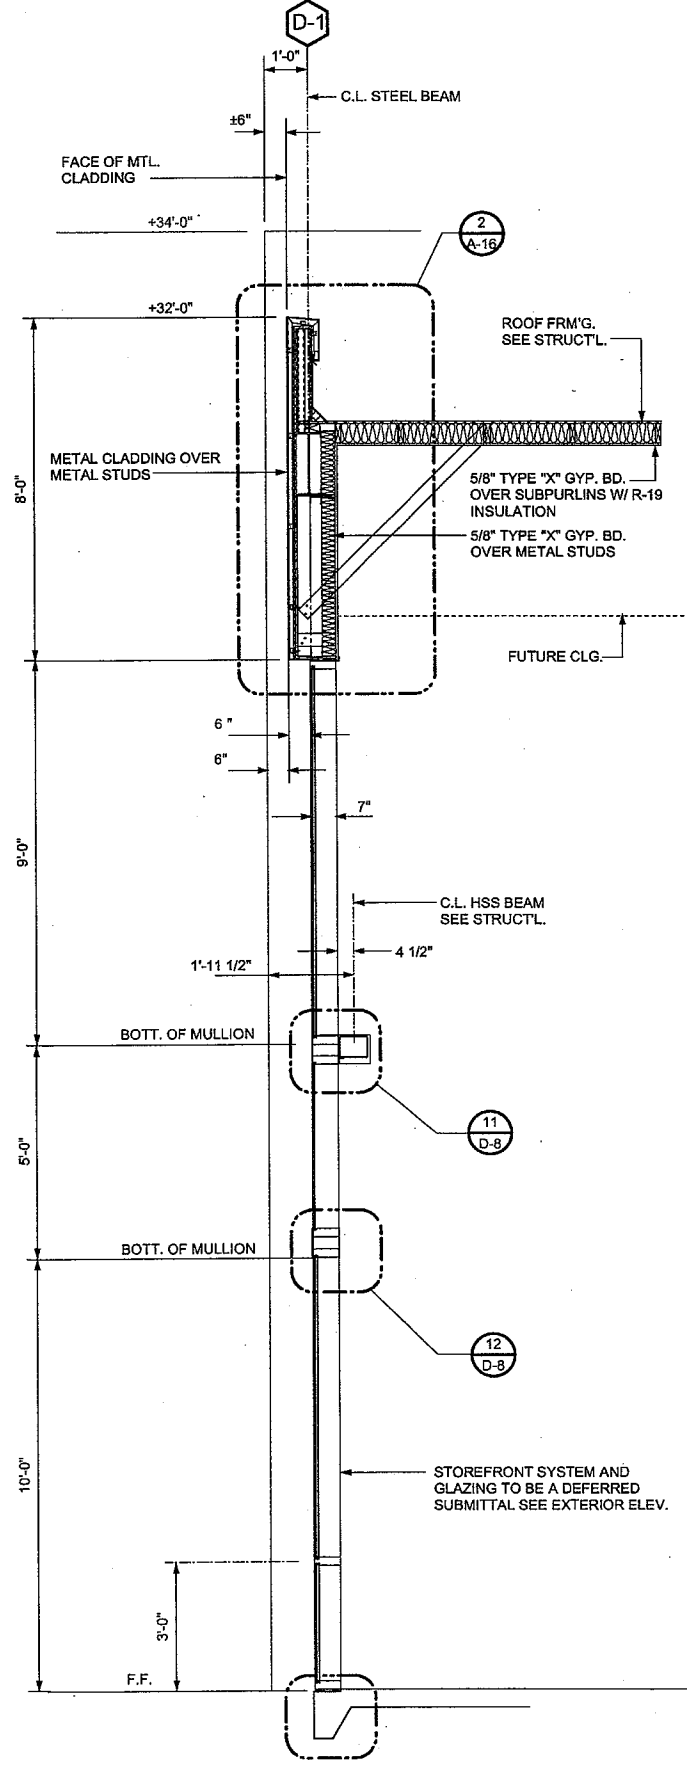TYPICAL WALL SECTION 2

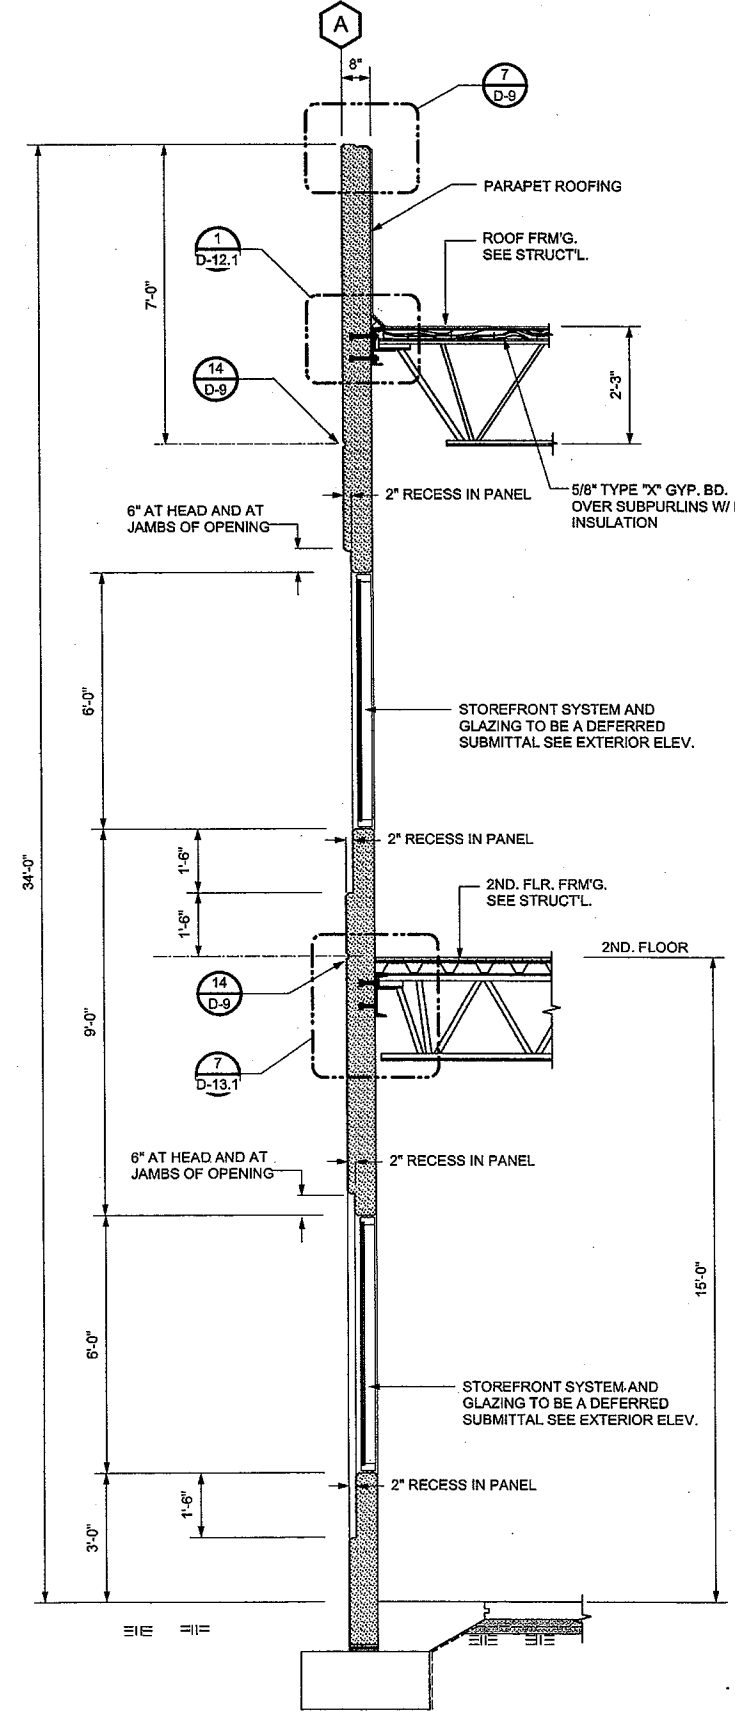

SC: 1/2" = 1'-0"

TYPICAL WALL SECTION 1

CABRILLO BUSINESS PARK BUILDING NO. 4

HOLLISTER AVE  
GOLETA, CA

WALL SECTIONS

Date: 11-18-09


Job: 0904

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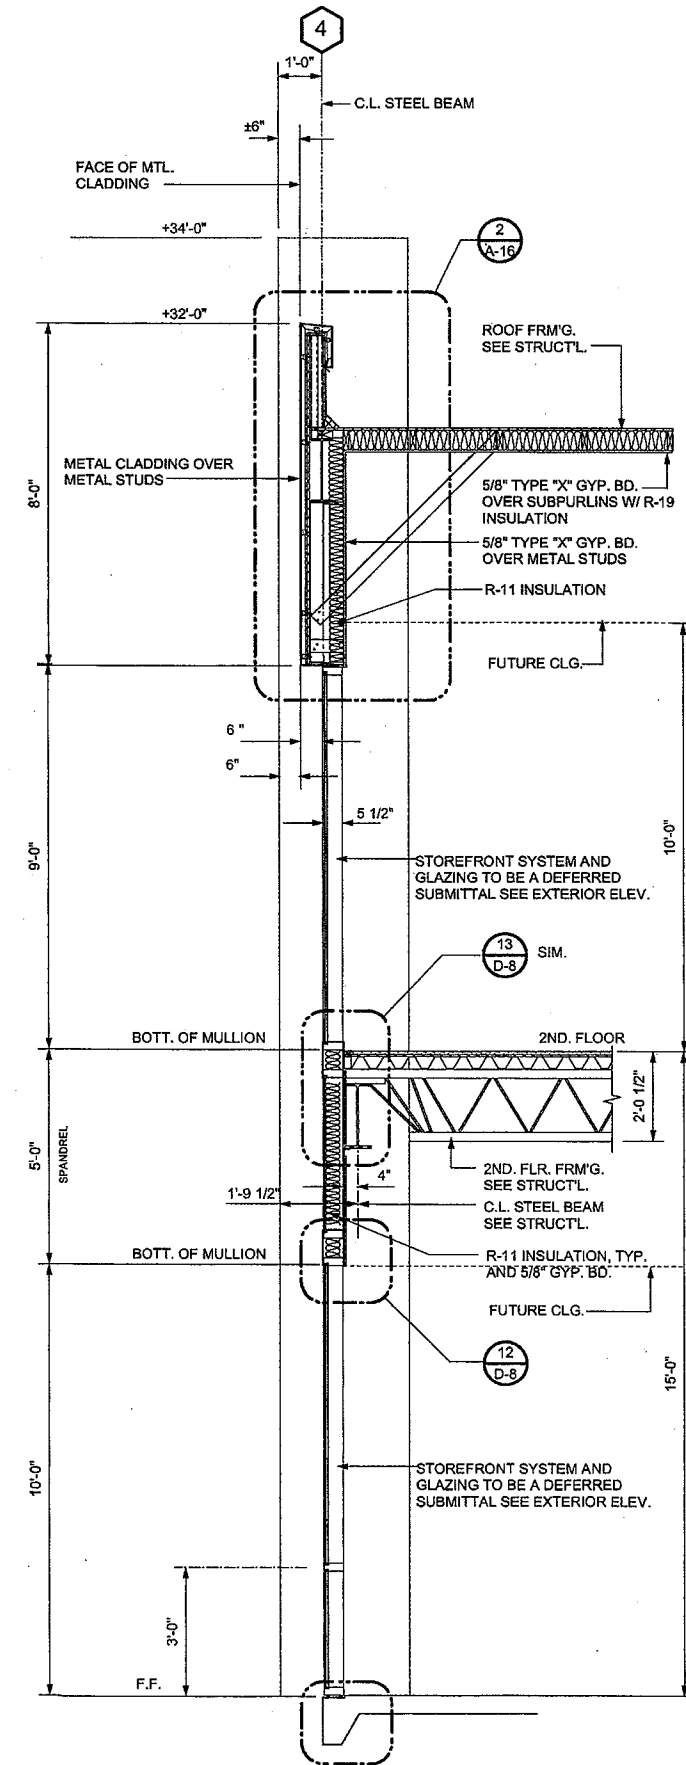
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A-15


NOT USED



TYPICAL WALL SECTION

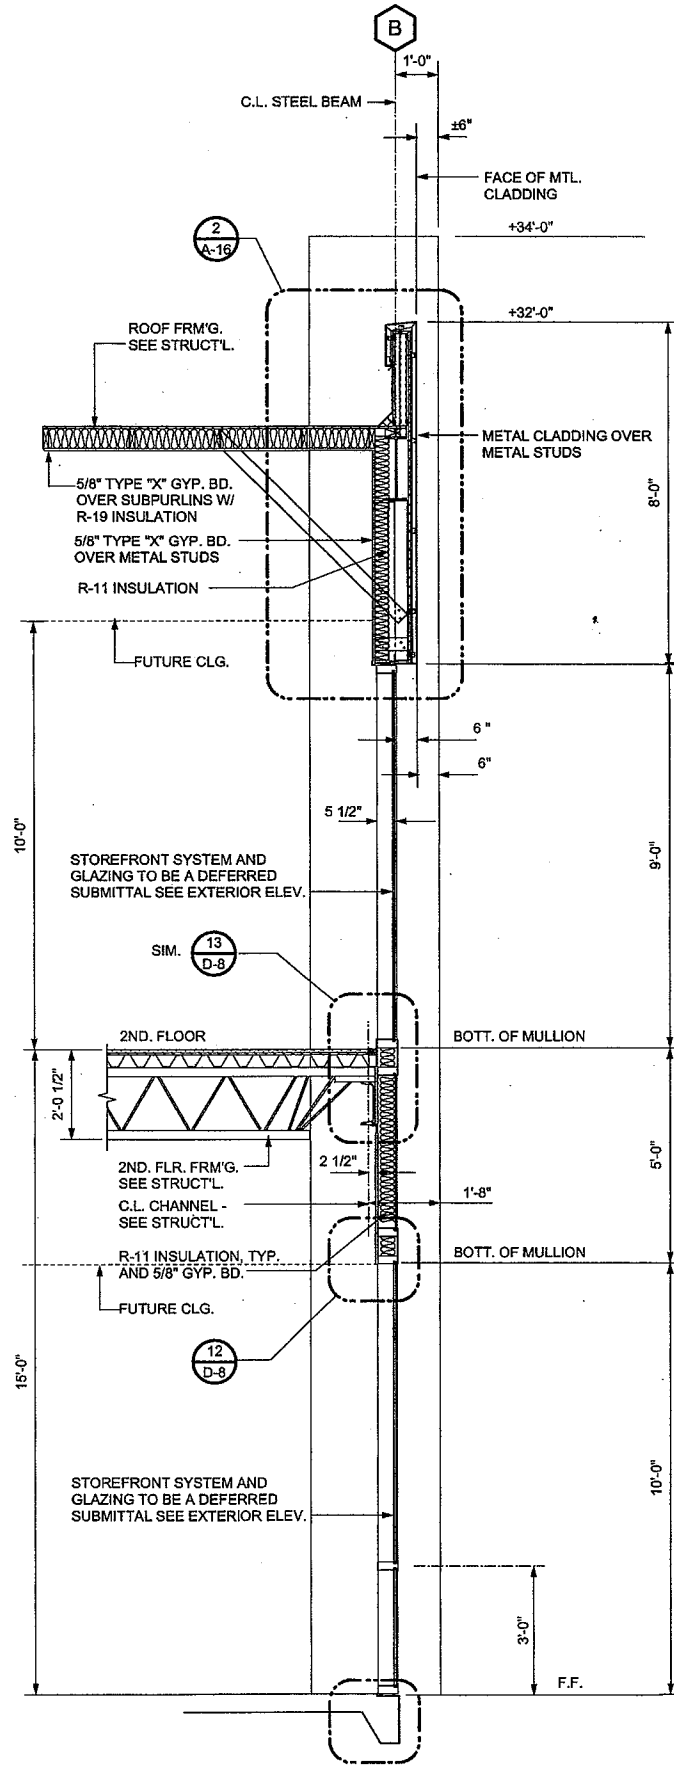

TYPICAL WALL SECTION

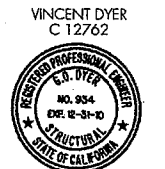

VINCENT DYER  
C 12762  
G.O. DYER  
NO. 934

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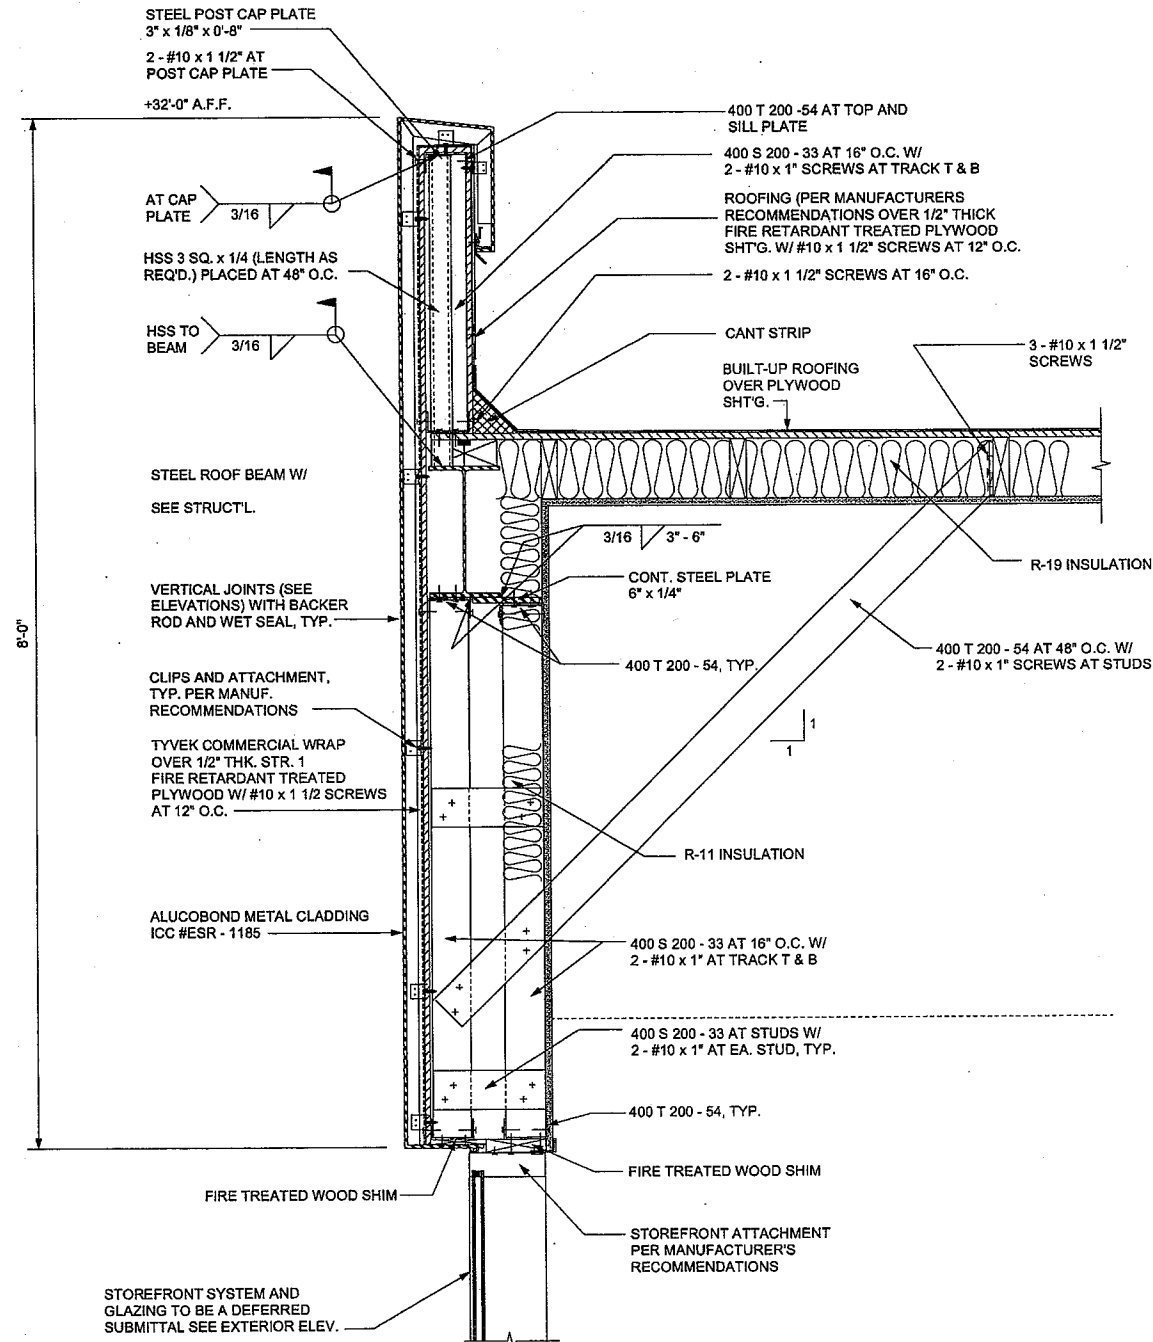

CABRILLO  
BUSINESS PARK  
BUILDING NO. 4  
HOLLISTER AVE  
GOLETA, CA

WALL  
SECTIONS

Date:	11-18-09
Job:	0904
Drawn by:	
Sheet:	



NOTE:  
APPLICATION OF ALUCOBOND METAL CLADDING  
SHALL COMPLY ICC # ESR 1185.




SC: 1 1/2" = 1'-0"

WALL SECTION

2

NOTE:  
APPLICATION OF ALUCOBOND METAL CLADDING  
SHALL COMPLY WITH ICC # ESR 1185.

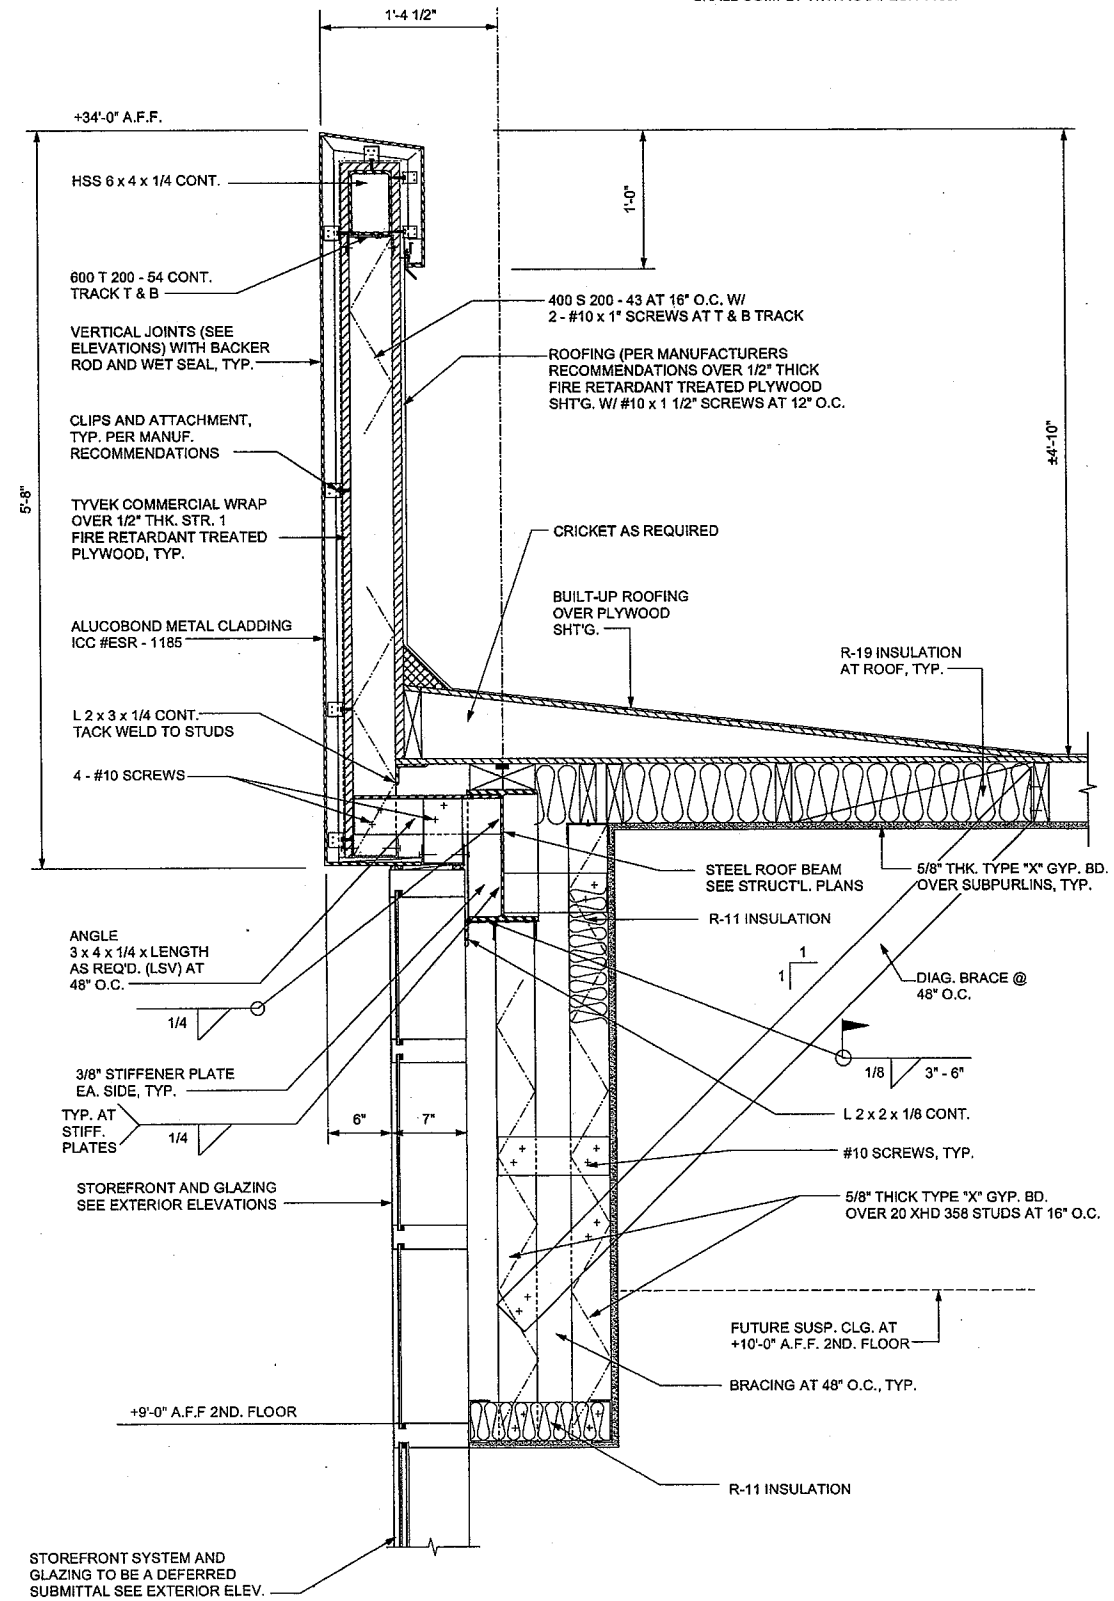

SC: 1 1/2" = 1'-0"

WALL SECTION

1



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C 12762



G.O. DYER  
NO. 934

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Revisions

CABRILLO  
BUSINESS PARK  
BUILDING NO. 4

HOLLISTER AVE  
GOLETA, CA

WALL  
DETAILS

Date:

11-18-09

Job:

0904

Drawn by:

Sheet:

A-16




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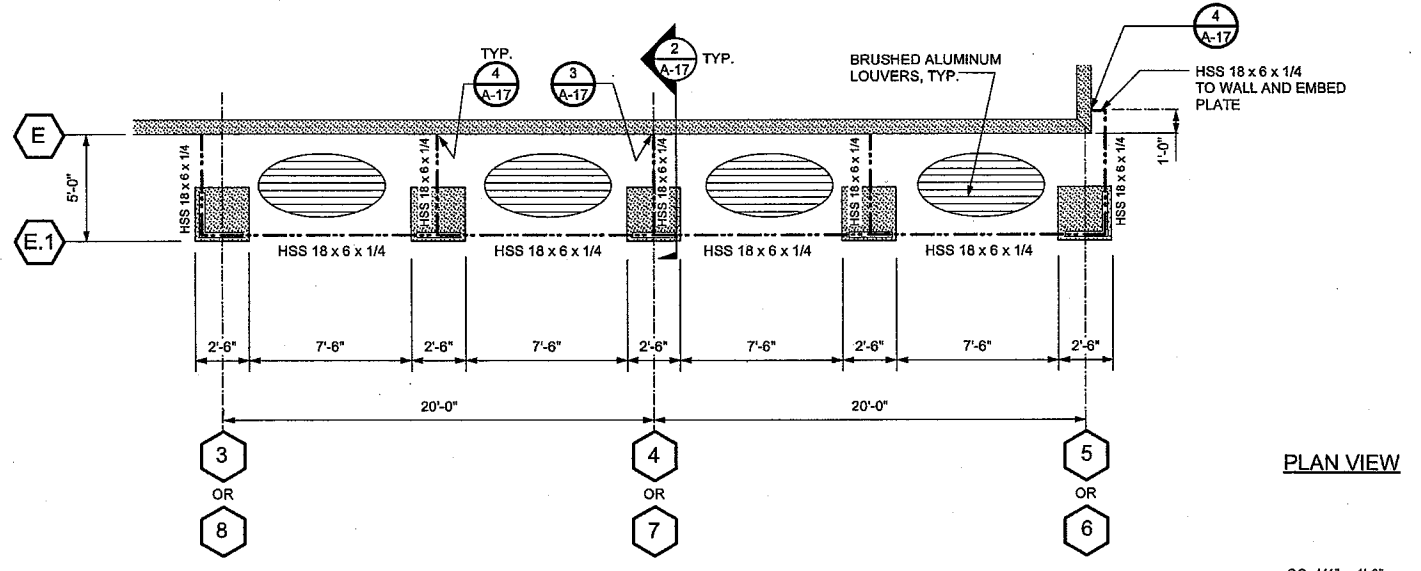


SC: 1/8" = 1'-0"

TYPICAL BUILDING SECTION

1

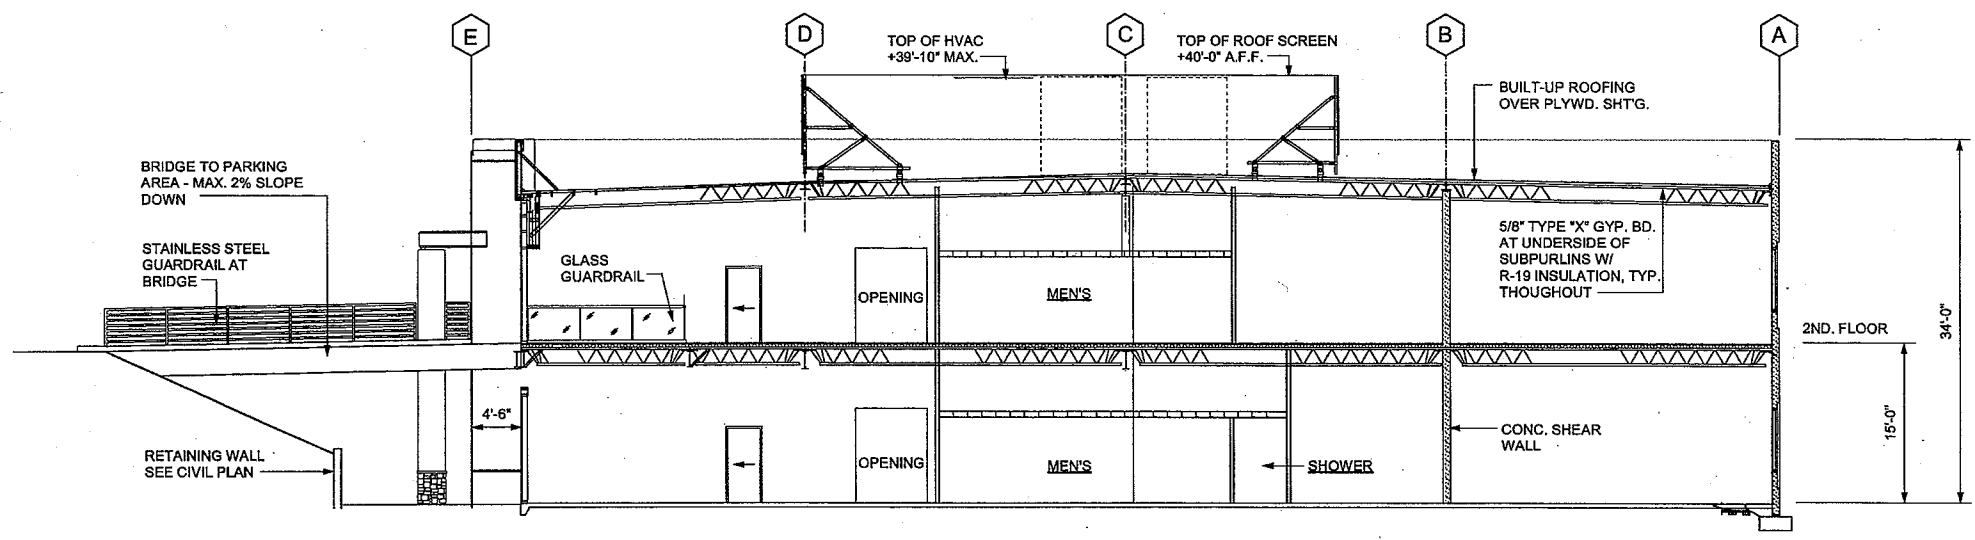Revisions




PLAN VIEW

SC: 1/4" = 1'-0"

TRELLIS


3

NOT USED

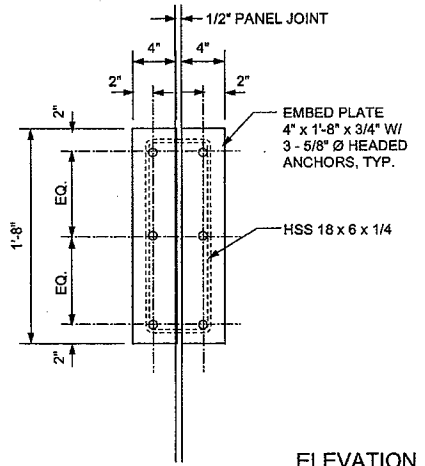


ELEVATION

SC: 1 1/2" = 1'-0"

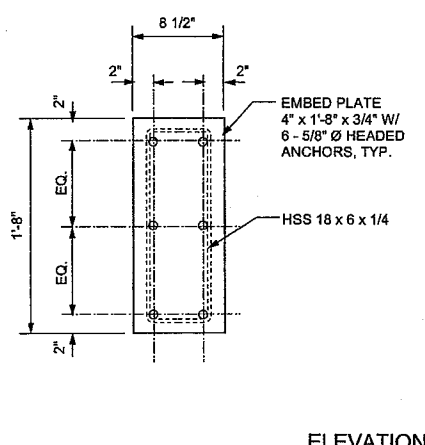

ELEVATION

SC: 1 1/2" = 1'-0"

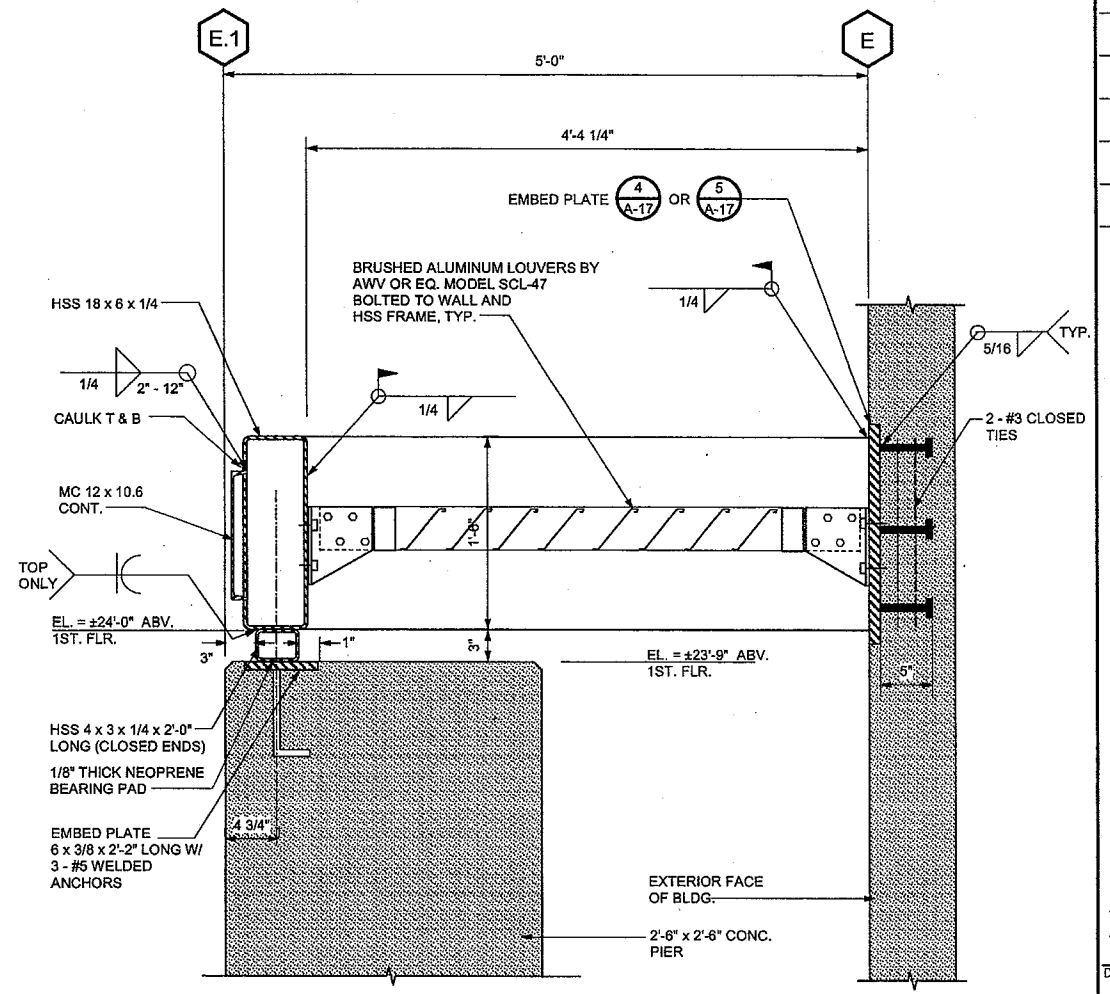

SECTION

SC: 1 1/2" = 1'-0"

WALL SECTION

2

CABRILLO BUSINESS PARK BUILDING NO. 4

HOLLISTER AVE  
 GOLETA, CA

TRELLIS DETAILS


Date: 11-18-09

Job: 0904


Drawn by:

Sheet:


A-17

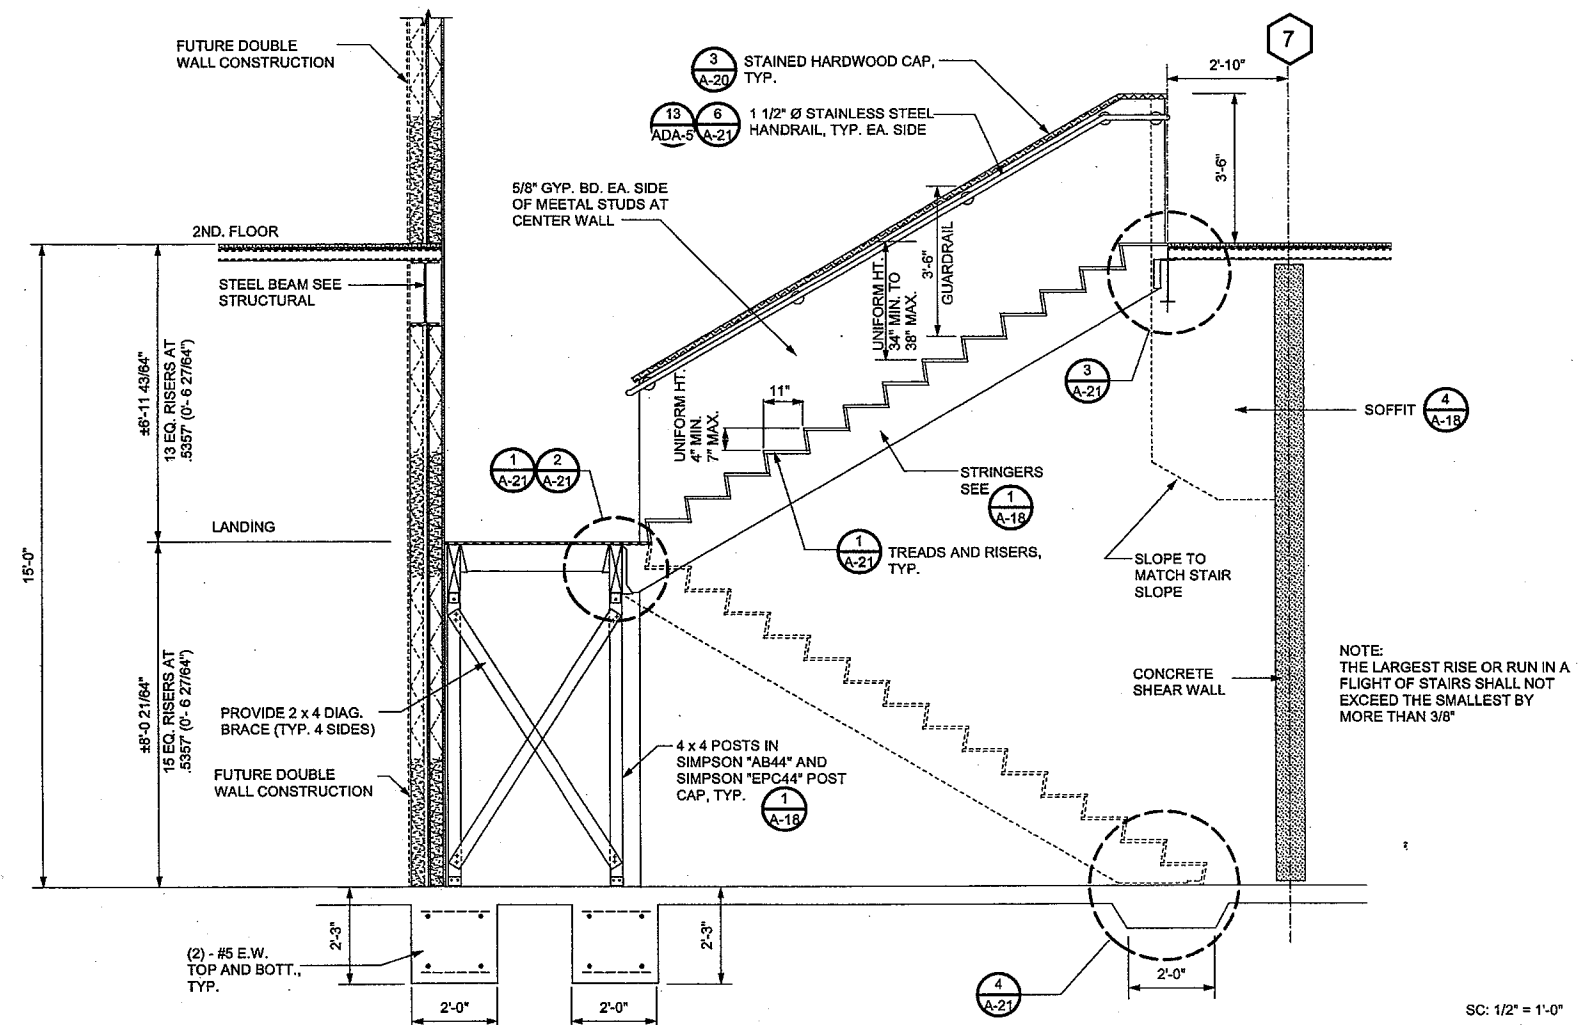


STAIR NO. 1 - SECTION 2

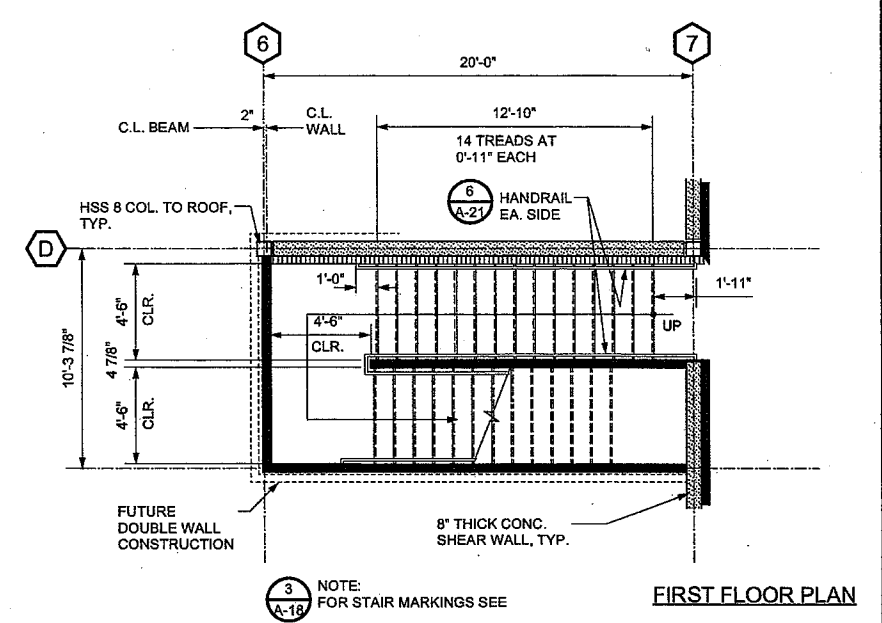


FIRST FLOOR PLAN

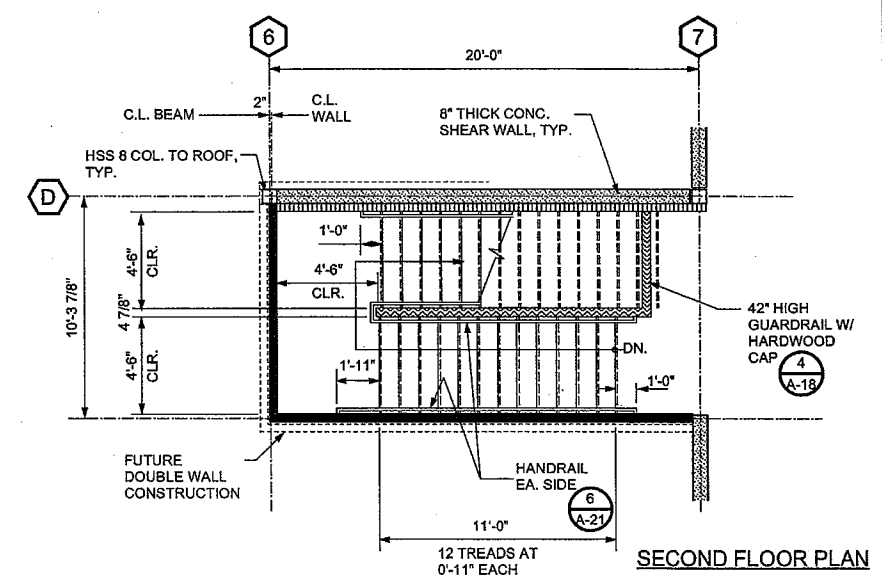


SECOND FLOOR PLAN

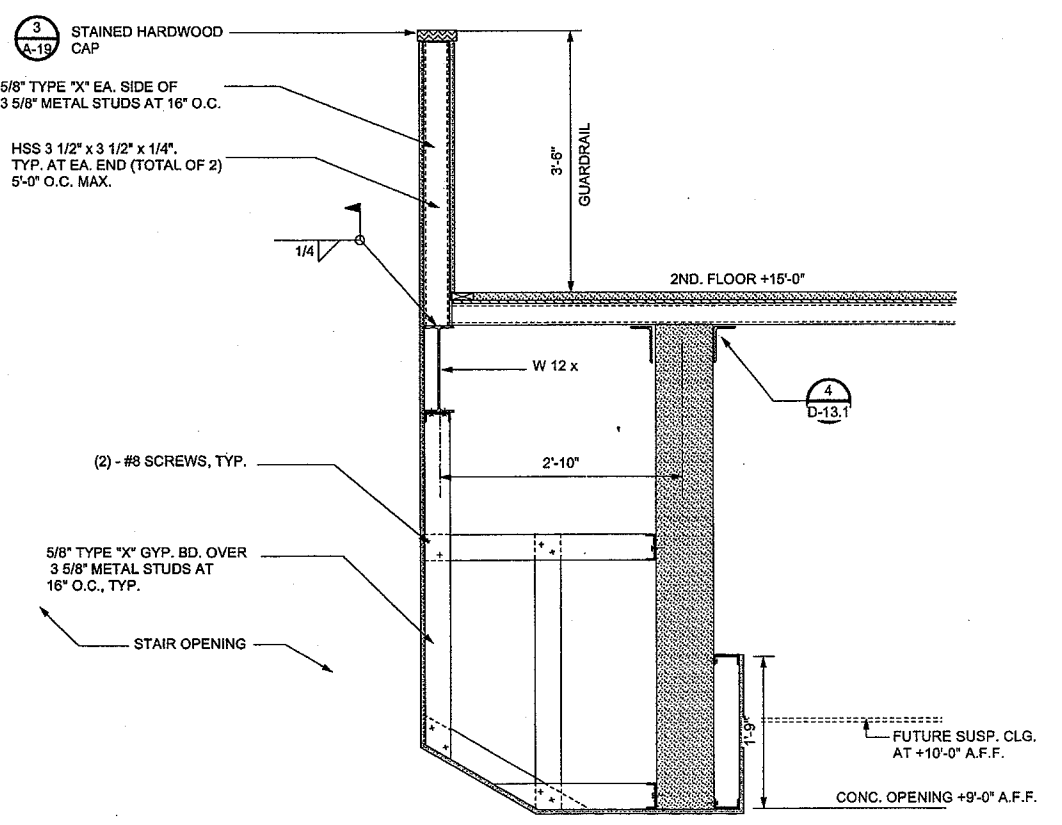

GUARDRAIL 4

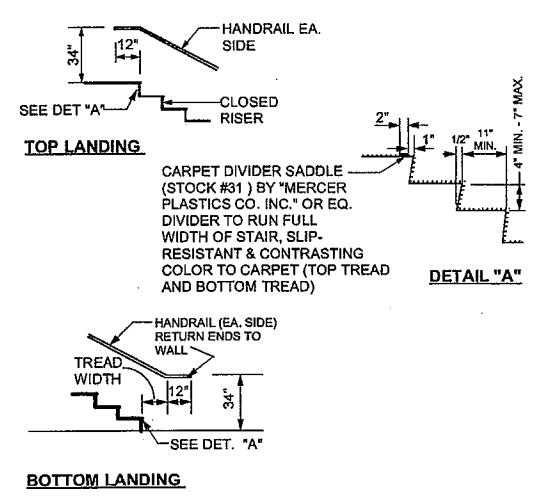

STAIR MARKINGS 3

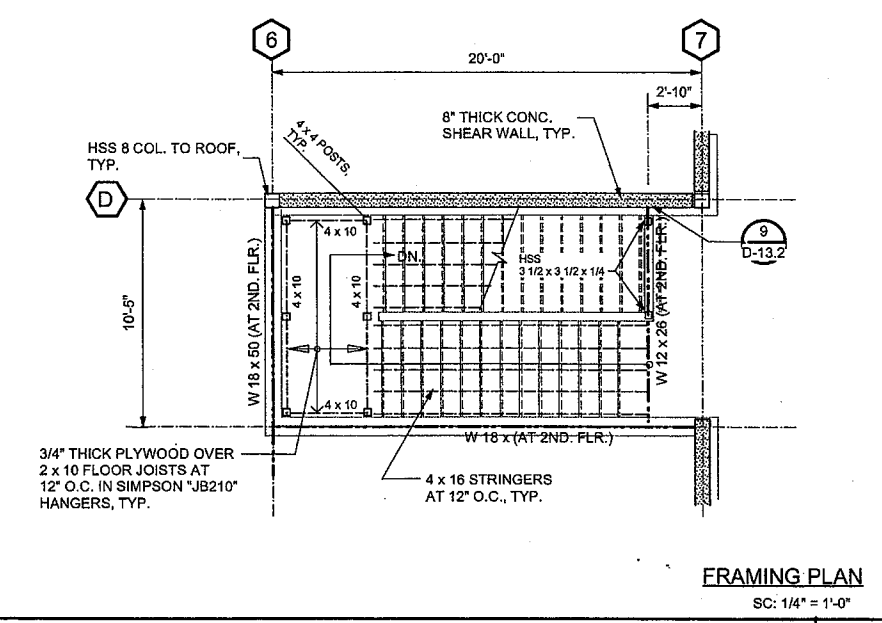

FRAMING PLAN

STAIR NO. 1 1

**JDO Dyer**  
 Architecture | Engineering  
 5376 N. Sterling Center Drive  
 Westlake Village, CA 91361  
 Phone 818. 706. 3997  
 Fax 818. 706. 2453

**VINCENT DYER**  
 LICENSED ARCHITECT  
 STATE OF CALIFORNIA  
 C-12762  
 EXP. 5-31-11

**VINCENT DYER**  
 LICENSED PROFESSIONAL ENGINEER  
 STATE OF CALIFORNIA  
 NO. 934  
 EXP. 12-31-10

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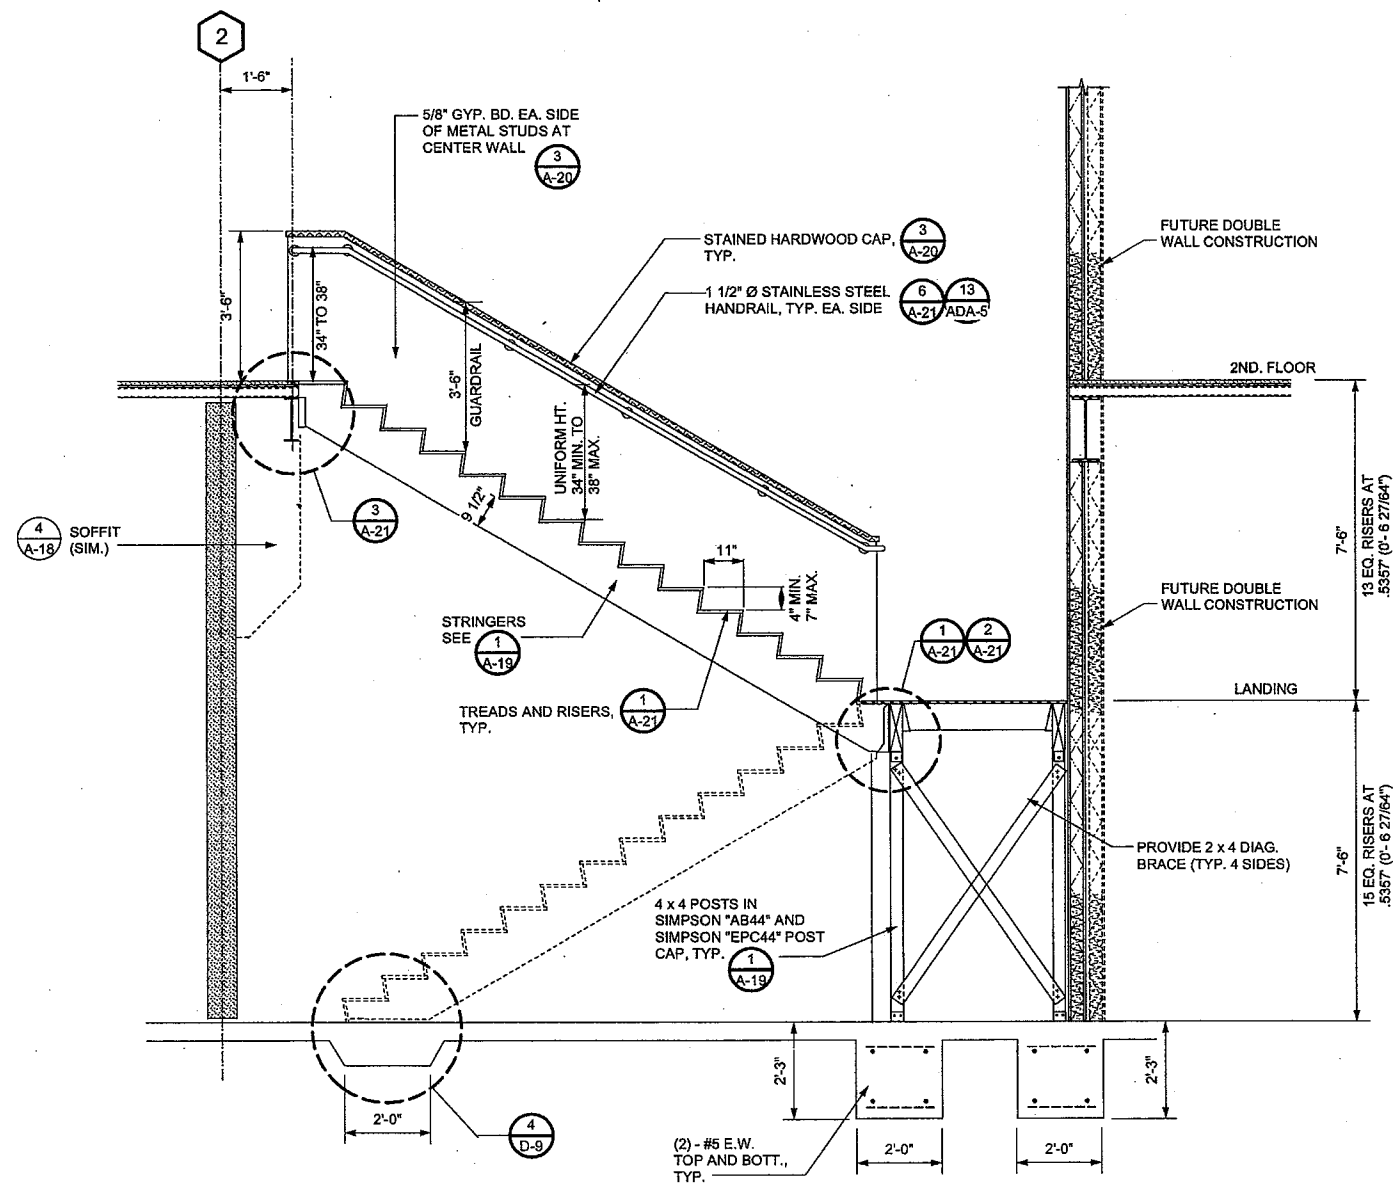
Revisions


**CABRILLO BUSINESS PARK BUILDING NO. 4**  
 HOLLISTER AVE  
 GOLETA, CA

**STAIR NO. 1**

Date: 11-18-09  
 Job: 0904  
 Drawn by:  
 Sheet:

**A-18**




STAIR NO. 3 - SECTION

2


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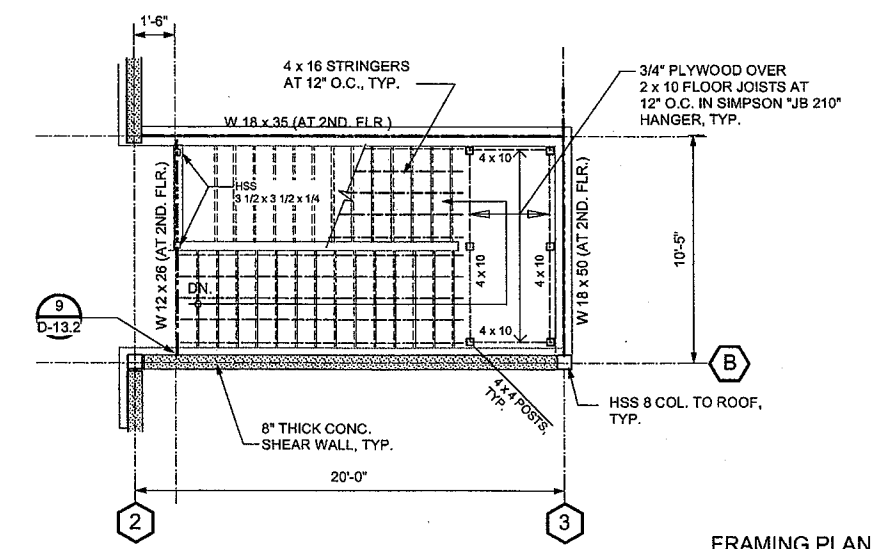


FIRST FLOOR PLAN

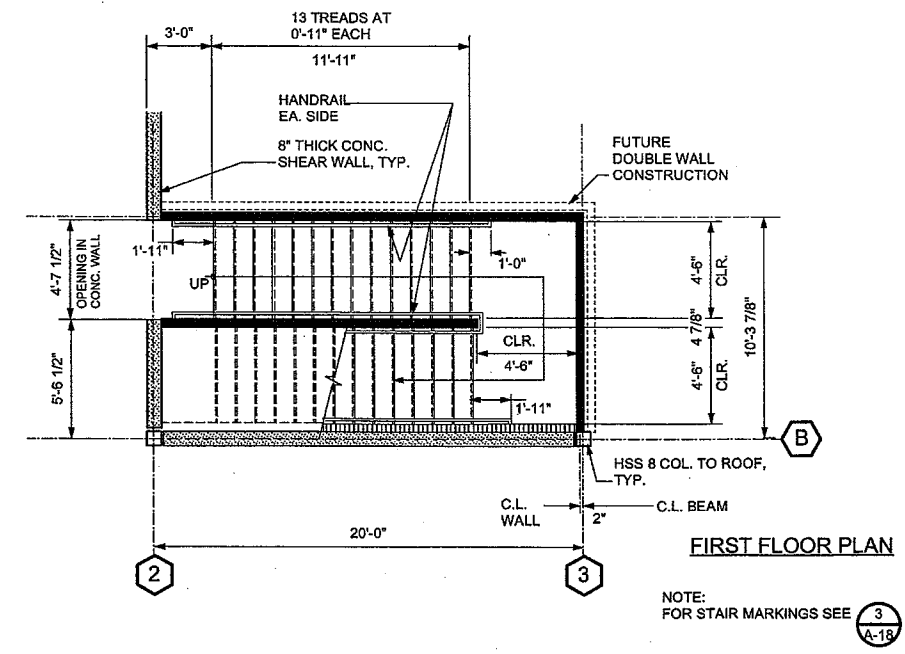NOTE:  
FOR STAIR MARKINGS SEE A-18



SECOND FLOOR PLAN

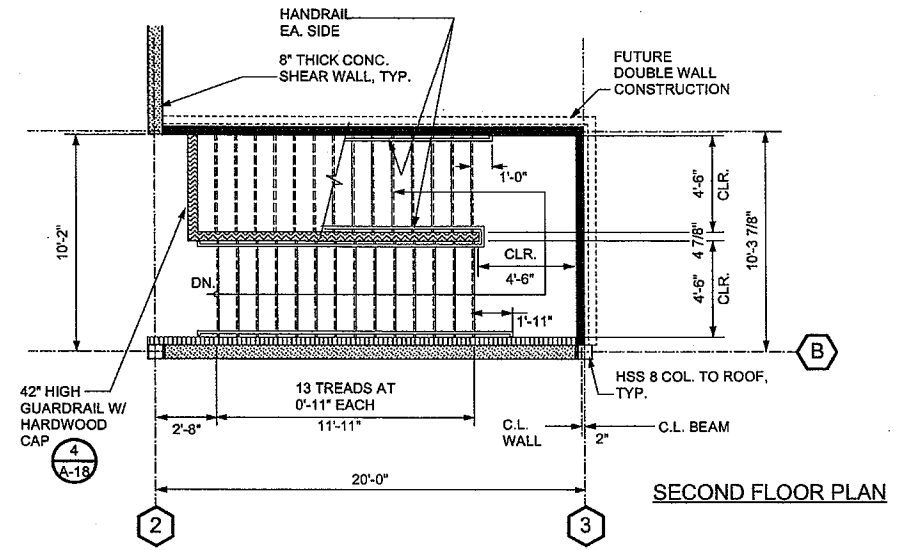

FRAMING PLAN

SC: 1/4" = 1'-0"

STAIR NO. 3

1



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Revisions

No.	Description

CABRILLO  
BUSINESS PARK  
BUILDING NO. 4  
HOLLISTER AVE  
GOLETA, CA

STAIR NO. 3


Date: 11-18-09

Job: 0904

Drawn by:

Sheet:


A-19

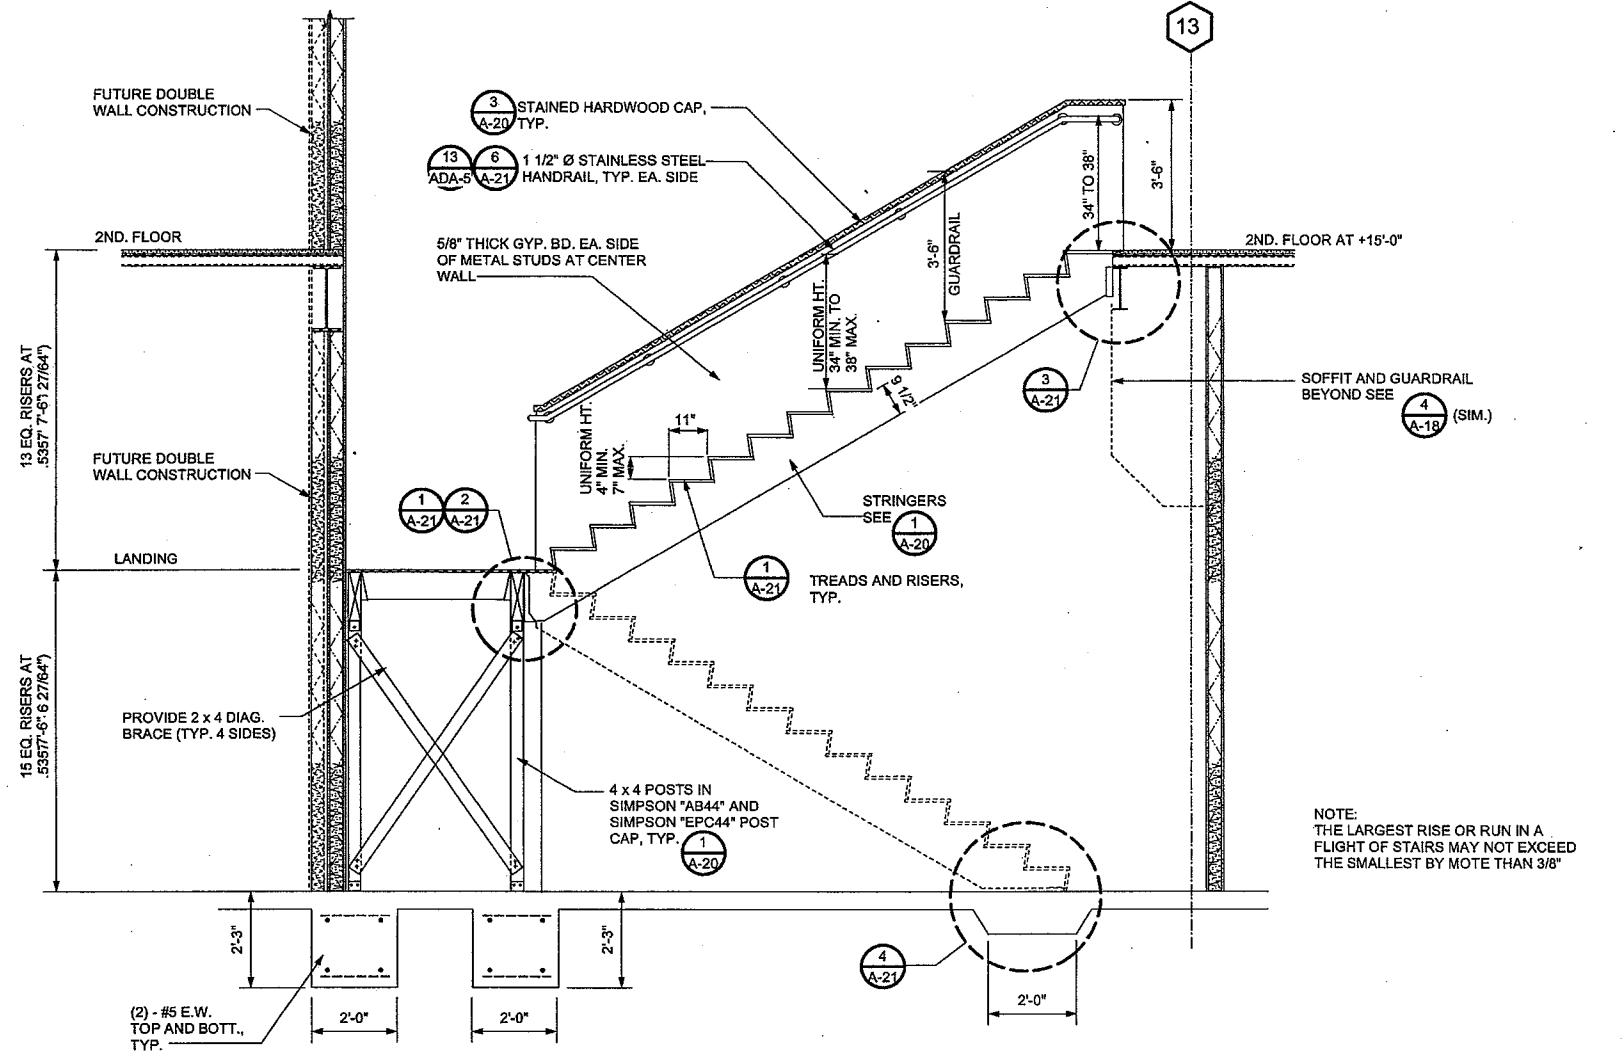

STAIR NO. 2 - SECTION 2


SC: 1/2" = 1'-0"

NOT USED

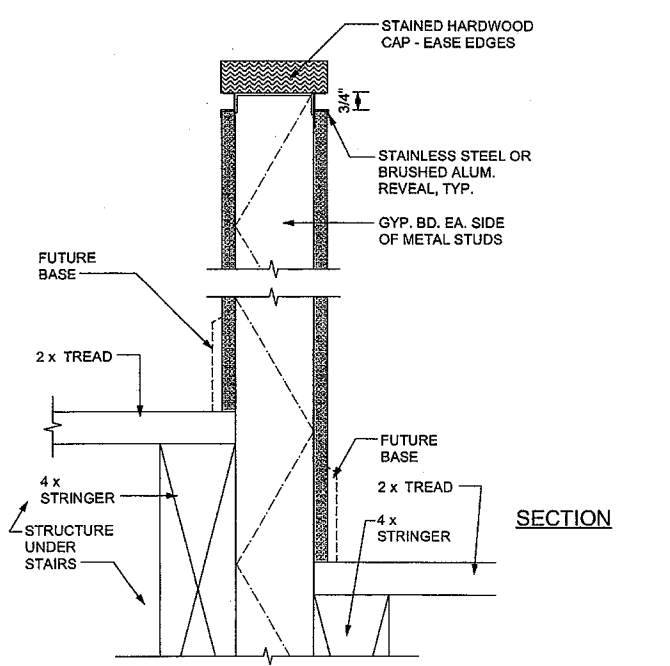


REVEAL AT GUARDRAIL 3

SC: 3" = 1'-0"

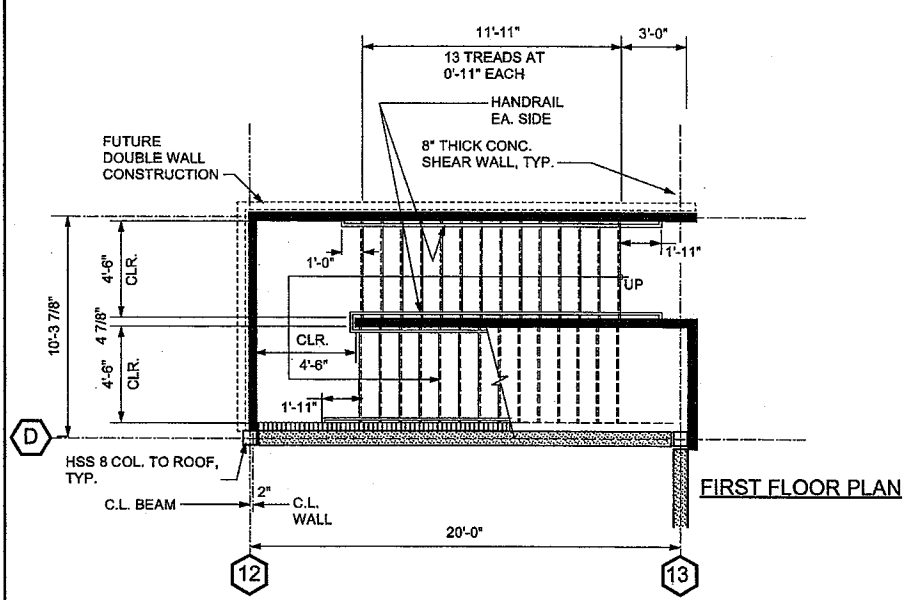


FIRST FLOOR PLAN

NOTE: FOR STAIR MARKINGS SEE (A-18)

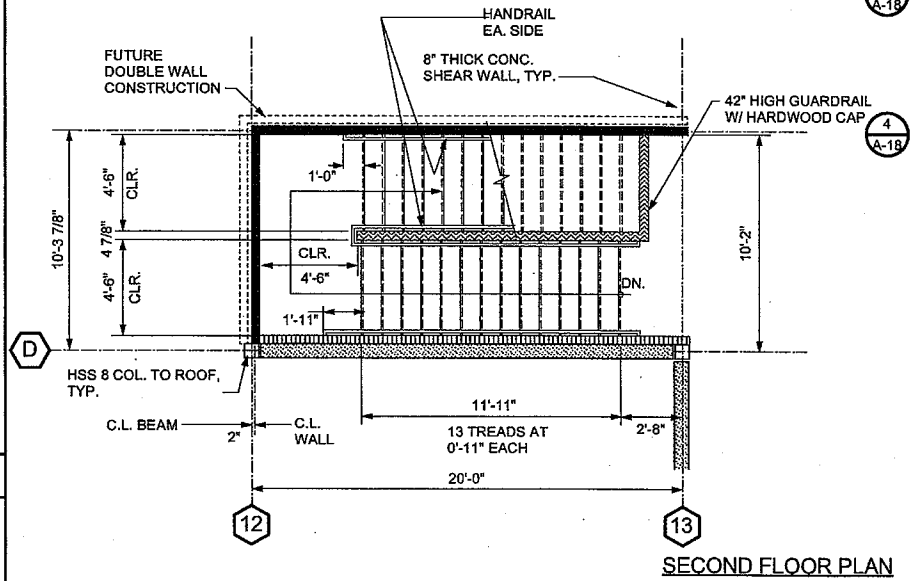

SECOND FLOOR PLAN

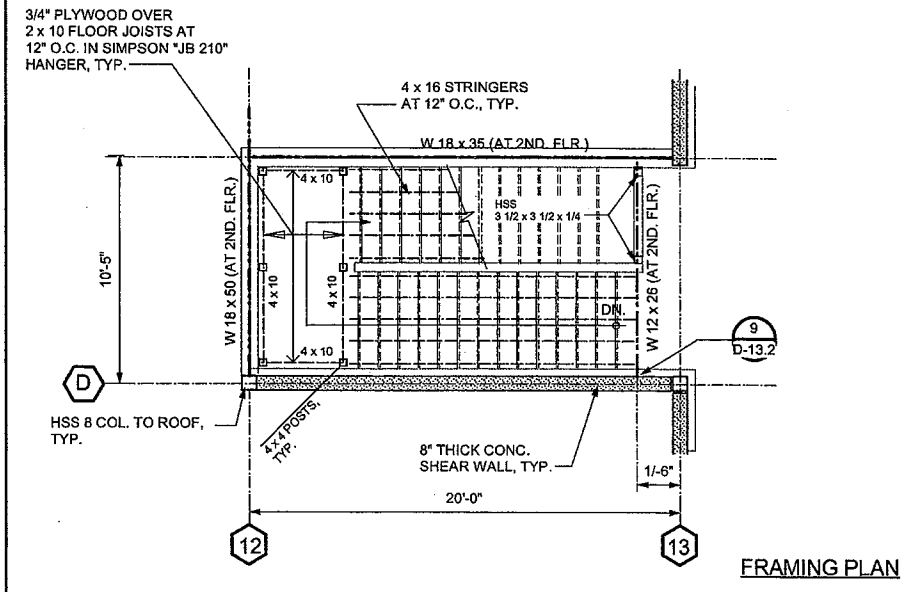

FRAMING PLAN

SC: 1/4" = 1'-0"

STAIR NO. 2 1





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C 12762



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NO. 934

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Revisions

**CABRILLO BUSINESS PARK BUILDING NO. 4**

HOLLISTER AVE  
GOLETA, CA

**DETAILS**

Date: 11-18-09

Job: 0904

Drawn by:

Sheet:

**A-21**

NOT USED	NOT USED	NOT USED				
13	10	7	STRINGER AT SLAB	4	<p><b>NOTE:</b> WHERE STAIRWAYS OCCUR OUTSIDE A BUILDING, THE UPPER APPROACH AND ALL TREADS SHALL BE MARKED BY A STRIP OF CLEARLY CONTRASTING COLOR AT LEAST 2" WIDE AND PLACED PARALLEL TO AND NOT MORE THAN 1" FROM THE NOSE OF THE STEP OR LANDING TO ALERT THE VISUALLY IMPAIRED. THE STRIP SHALL BE OF A MATERIAL THAT IS AT LEAST AS SLIP RESISTANT AS THE OTHER TREADS OF THE STAIRS. A PAINTED STRIP IS ACCEPTABLE.</p>	
14	11	8	STAIR MARKINGS	5		
12	9	6	HANDRAIL	3		