SHEET INDEX						
SHT. NO.	DWG NO.	DESCRIPTION				
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02	G-1	GENERAL NOTES				
03	DM-1	DEMOLITION AND UTILITY PLAN - CHAPEL STREET				
04	DM-2	DEMOLITION AND UTILITY PLAN - KINGSTON AVENUE				
05	SI-1	STREET IMPROVEMENT PLAN - CHAPEL STREET				
06	SI-2	STREET IMPROVEMENT PLAN - KINGSTON AVENUE				
07 E-1		ELECTRICAL PLAN - RRFB - CHAPEL STREET AT HOLLISTER AVE				
08	E-2	ELECTRICAL PLAN - PHB - KINGSTON AVENUE AT CALLE REAL				
09	SS-1	SIGNING AND STRIPING - CHAPEL STREET				
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16	W-1	WIRING DIAGRAM				

CITY OF GOLETA PUBLIC WORKS DEPARTMENT

PROJECT PLANS FOR CONSTRUCTION


RECTANGULAR RAPID FLASHING BEACONS (RRFB) AT CHAPEL, PEDESTRIAN HYBRID **BEACON (PHB) AT KINGSTON**

IN SANTA BARBARA COUNTY

CALTRANS 2015 STANDARD PLANS CALTRANS 2015 STANDARD SPECIFICATIONS

TO BE SUPPLEMENTED BY STANDARD SPECIFICATIONS FOR PUBLIC WORKS CONSTRUCTION "GREENBOOK" DATED 2015 STANDARD PLANS FOR PUBLIC WORKS CONSTRUCTION "GREENBOOK" DATED 2012 AND SANTA BARBARA COUNTY STANDARD DETAILS DATED SEPTEMBER 2011

PROJECT NO. 9058

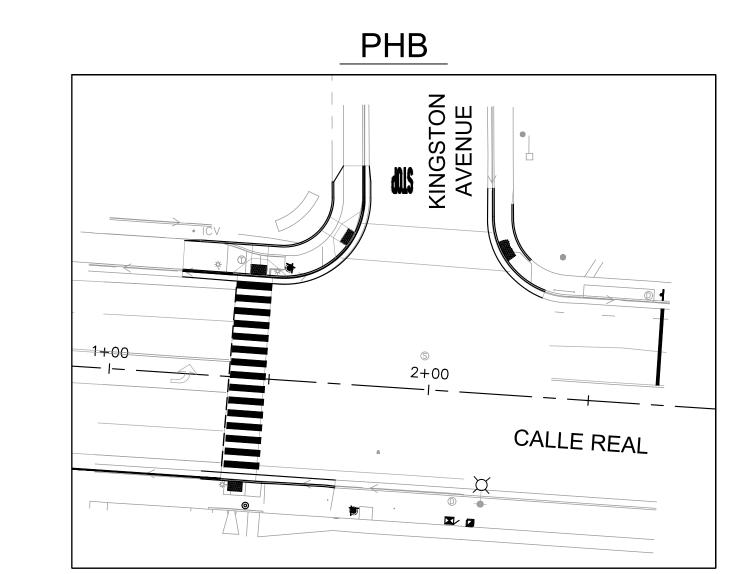

HOLLISTER AVENUE AT CHAPEL STREET SCALE: 1"=40'

RRFB

CALLE REAL AT KINGSTON AVENUE SCALE: 1"=40'

UTILITY COORDINATION

SOUTHERN CALIFORNIA EDISON 103 DAVID LOVE PLACE GOLETA, CA 93117 SHAWN LEE (805) 535-5901

HOLLISTER AVENUE

GOLETA WATER DISTRICT 4699 HOLLISTER AVE GOLETA, CA 93110 DAN BROOKS (805) 879-4625

ATT TRANSMISSION 22311 BROOKHURST ST, SUITE 203 HUNTINGTON BEACH, CA 92646 JOSEPH FORKERT (714) 963-7964

> →

LEVEL 3 COMMUNICATIONS 1025 ELDORADO BLVD BROOMFIELD, CO 80021 (877) 366-8344

COX COMMUNICATIONS PO BOX 787 GOLETA, CA 93117 JAMES DRANAM (805) 681 - 3844

201 FLYNN ROAD

C/O LAD KUZELA

OSP ENGINEERING

GOLETA, CA 93117

(805)964-8303

CAMARILLO, CA 93012

FRONTIER COMMUNICATIONS SOUTHERN CALIFORNIA GAS 9400 OAKDALE AVE CHATSWORTH, CA 91311 CARL MONTELEONE (805) 681-7945 225 S. FAIRVIEW AVENUE

GOLETA SANITARY DISTRICT

1 WILLIAM MOFFETT PLACE


GOLETA, CA 93117

LUIS ASTORGA

(805) 967-4519

NEXTGLAVEN CROWN CASTLE 2000 CORPORATE DR CANONSBURG, PA 15317 BRYANT LOWE (724) 416-2193

SPRINT 2592 DUPONT DR IRVINE, CA 92612 TIBOR LAKY (800) 659-9698

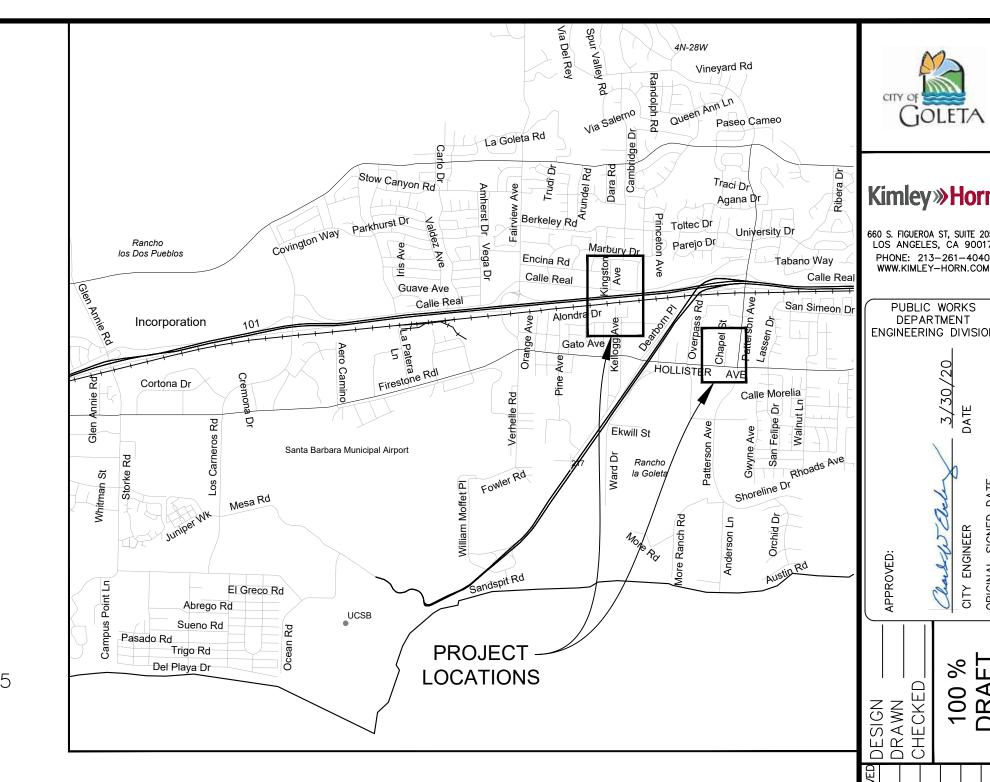

VICINITY MAP

NO SCALE

9058 PBW. NO.

BID NO. SHT. [

SHT. 01 OF 16

03-19





- 1. ALL WORK SHALL BE DONE IN ACCORDANCE WITH THE CONTRACT DOCUMENTS, CALTRANS 2015 STD PLANS AND SPECIFICATIONS (2015), THE COUNTY OF SANTA BARBARA DEPARTMENT OF PUBLIC WORKS ENGINEERING DESIGN STANDARDS, AND GREENBOOK STANDARD PLANS AND SPECIFICATIONS..
- 2. WORK HOURS SHALL BE FROM 7:30 A.M. TO 4:30 P.M., MONDAY THROUGH FRIDAY. UNLESS OTHERWISE SPECIFIED BY THE PUBLIC WORKS DEPARTMENT. THE HOURS SHALL BE STRICTLY ADHERED TO. ANY DEVIATION FROM THE SCHEDULE REQUIRES PRIOR APPROVAL FROM THE CITY ENGINEER.
- 3. CONTRACTOR SHALL MAINTAIN A CLEAN AND ORDERLY WORK ZONE AND IS RESPONSIBLE FOR RESOLVING COMPLAINTS GENERATED BY THE WORK.
- 4. NO DEBRIS OR SPOILS SHALL BE LEFT IN THE PUBLIC RIGHT-OF-WAY OVERNIGHT.
- 5. LIMITS OF CONCRETE REMOVAL SHALL BE APPROVED BY THE CITY ENGINEER PRIOR TO START OF WORK.
- 6. ALL CONCRETE THAT IS REMOVED SHALL BE SAW CUT AND REMOVED TO THE NEXT NEAREST EXPANSION JOINT. ALL CUTS ARE TO BE PERPENDICULAR TO THE CURB AND GUTTER WITH NO LONGITUDINAL CUTS OR DIAGONAL CUTS.
- 7. ANY CURB, GUTTER, OR SIDEWALK SECTIONS WHICH ARE TO BE REMOVED AND/OR CONSTRUCTED SHALL BE REPLACED IN MINIMUM 5 FOOT SECTIONS IN ACCORDANCE WITH THE COUNTY OF SANTA BARBARA DEPARTMENT OF PUBLIC WORKS ROAD STANDARDS AND AS DIRECTED BY THE CITY ENGINEER.
- 8. ALL CONCRETE CONSTRUCTION TO INCLUDE RAMPS SHALL BE IN ACCORDANCE WITH THE MOST CURRENT AMERICANS WITH DISABILITIES ACT (A.D.A.) REQUIREMENTS AND REGULATIONS.
- 9. FORM INSPECTIONS WILL BE REQUIRED PRIOR TO PLACEMENT OF CONCRETE AND AT THE COMPLETION OF WORK.
- 10. WHEN THE SIDEWALK WIDTH EXCEEDS 6', LONGITUDINAL SCORE AT THE CENTER OF THE SIDEWALK SHALL BE PROVIDED. ADDITIONAL WIDTH TO MAINTAIN A MINIMUM OF 4' OF CLEAR SIDEWALK SHALL BE PROVIDED WHEN OBSTRUCTIONS SUCH AS UTILITIES EXIST.
- 11. REMOVAL OF THE SIDEWALK MAY BE REQUIRED IF THE EXISTING SIDEWALK IS BROKEN OR NOT CONSTRUCTED TO THE FINISHED ELEVATION.
- 12. NOTIFY THE CITY ENGINEER AND ALL OTHER INTERESTED PARTIES AT LEAST FORTY-EIGHT (48) HOURS PRIOR TO THE START OF WORK.
- 13. AT LEAST FORTY-EIGHT (48) HOURS PRIOR TO COMMENCING CONSTRUCTION, CONTACT THE REGIONAL NOTIFICATION CENTER (UNDERGROUND SERVICE ALERT OF SOUTHERN CALIFORNIA - U.S.A. AT 811) AND REQUEST THAT UTILITY OWNERS MARK OR OTHERWISE INDICATE THE LOCATION OF THEIR FACILITIES. BEFORE COMMENCING ANY EXCAVATION, POTHOLE AND EXPOSE THE EXISTING UTILITIES AT ALL CROSSINGS AND AT THE POINT OF TIE-IN; THEN CONTACT THE [CITY'S REPRESENTATIVE] SO THE ELEVATION OF THE EXISTING FACILITIES CAN BE VERIFIED. TAKE ALL NECESSARY MEASURES TO PROTECT ALL UTILITIES AND ALL STRUCTURES FOUND AT THE SITE.
- 14. DURING ALL PHASES OF CONSTRUCTION, INCLUDING SUSPENSION OF WORK, UNTIL FINAL ACCEPTANCE OF THE PROJECT, OBSERVE, FOLLOW AND IMPLEMENT ALL THE REQUIREMENTS OF THE NPDES AND STORMWATER POLLUTION PREVENTION PROGRAM AND KEEP THE WORK SITE CLEAN AND FREE FROM RUBBISH AND DEBRIS. ALSO ABATE DUST NUISANCE BY CLEANING, SWEEPING AND SPRINKLING WITH WATER AND USING DUST FENCES OR THEIR METHODS AS DIRECTED BY THE [CITY'S REPRESENTATIVE] THROUGHOUT THE CONSTRUCTION OPERATION.
- 15. KEEP A STRICT RECORD OF ALL CHANGES AND SUBMIT THIS RECORD TO THE CITY PUBLIC WORKS DEPARTMENT. ALSO COORDINATE TRANSFERRING "AS-BUILT" INFORMATION ON THE CONTRACT DRAWINGS AND DELIVER THE CERTIFIED "AS-BUILT" PLANS TO THE CITY BEFORE FINAL ACCEPTANCE OF THE PROJECT.
- 16. EXERCISE DUE CARE TO AVOID INJURY TO EXISTING IMPROVEMENTS OR FACILITIES, UTILITY FACILITIES, ADJACENT PROPERTY, AND TREES AND SHRUBBERY THAT ARE NOT TO BE REMOVED. ALL DAMAGE CAUSED TO PUBLIC STREETS, INCLUDING HAUL ROUTES, ALLEYS, SIDEWALKS, CURBS OR STREET FURNISHINGS, OR TO PRIVATE PROPERTY SHALL BE REPAIRED AT THE SOLE EXPENSE OF THE CONTRACTOR TO THE SATISFACTION OF THE [CITY'S REPRESENTATIVE].
- 17. DESIGNATE AND KEEP ON THE PROJECT AT ALL TIMES WHILE WORK IS BEING PERFORMED A COMPETENT SUPERINTENDENT WHO SHALL NOT BE REPLACED WITHOUT A WRITTEN NOTICE TO THE [CITY'S REPRESENTATIVE]. THE SUPERINTENDENT WILL BE THE CONTRACTOR'S REPRESENTATIVE AT THE SITE AND SHALL HAVE AUTHORITY TO ACT ON BEHALF OF THE CONTRACTOR. ALL COMMUNICATIONS GIVEN TO THE SUPERINTENDENT SHALL BE AS BINDING AS IF GIVEN TO THE CONTRACTOR. DURING PERIODS WHEN THE WORK IS SUSPENDED, MAKE APPROPRIATE ARRANGEMENTS FOR ANY EMERGENCY WORK WHICH MAY BE REQUIRED.
- 18. WHEN THE WORK ON ANY PORTION IS SUFFICIENTLY COMPLETE TO BE USED OR PLACED INTO SERVICE, THE CITY SHALL HAVE THE RIGHT UPON WRITTEN NOTIFICATION TO THE CONTRACTOR TO UTILIZE SUCH PORTIONS OF THE WORK AND TO PLACE THE OPERABLE PORTIONS INTO SERVICE AND TO OPERATE SAME, UPON SAID NOTICE AND COMMENCEMENT OF UTILIZATION OR OPERATION BY THE CITY, THE CONTRACTOR SHALL BE RELIEVED OF THE DUTY OF MAINTAINING THE PORTIONS SO UTILIZED OR PLACED INTO OPERATION; PROVIDED, HOWEVER, THAT NOTHING IN THIS NOTE SHALL BE CONSTRUED AS RELIEVING THE CONTRACTOR OF THE FULL RESPONSIBILITY FOR COMPLETING THE WORK IN ITS ENTIRETY, FOR MAKING GOOD DEFECTIVE WORK AND MATERIALS, FOR PROTECTING THE WORK FROM DAMAGE, AND FOR BEING RESPONSIBLE FOR DAMAGE.
- 19. CONDUCT OPERATIONS AS TO OFFER THE LEAST POSSIBLE OBSTRUCTION AND INCONVENIENCE TO THE PUBLIC, AND HAVE UNDER CONSTRUCTION NO GREATER LENGTH OR AMOUNT OF WORK THAN HE CAN PROSECUTE PROPERLY WITH DUE REGARD TO THE RIGHTS OF THE PUBLIC. CONVENIENT ACCESS TO DRIVEWAYS, HOUSES, AND BUILDINGS ALONG THE LINE OF WORK SHALL BE MAINTAINED AND TEMPORARY CROSSINGS SHALL BE PROVIDED AND MAINTAINED IN GOOD CONDITION. NO MORE THAN ONE CROSSING OR INTERSECTION STREET OR ROAD SHALL BE CLOSED AT ANY ONE TIME.
- 20. UNTIL THE ACCEPTANCE OF THE WORK, THE CONTRACTOR IN RESPONSIBLE CHARGE AND CARE OF THE WORK AND OF THE MATERIALS TO BE USED THEREIN (INCLUDING

- MATERIALS FOR WHICH THE CONTRACTOR HAS RECEIVED PARTIAL PAYMENT OR MATERIALS WHICH HAVE BEEN FURNISHED BY THE CITY) AND SHALL BEAR THE RISK OF INJURY, LOSS, OR DAMAGE TO ANY PART THEREOF BY THE ACTION OF ELEMENTS OR FROM ANY OTHER CAUSE, WHETHER ARISING FROM THE EXECUTION OR FROM THE NON-EXECUTION OF THE WORK.
- 21. IN ACCORDANCE WITH GENERALLY ACCEPTED CONSTRUCTION PRACTICES, THE CONTRACTOR SHALL BE SOLELY AND COMPLETELY RESPONSIBLE FOR CONDITIONS OF THE JOB SITE, INCLUDING SAFETY OF ALL PERSONS AND PROPERTY DURING PERFORMANCE OF THE WORK; AND FULLY COMPLY WITH ALL STATE, FEDERAL AND OTHER LAWS, RULES, REGULATIONS, AND ORDER RELATING TO SAFETY OF WORKERS AND ALL OTHERS. THIS MAY INCLUDE THE ISSUANCE OF PERSONAL PROTECTIVE EQUIPMENT.
- 22. ALL UNDERGROUND UTILITIES OR STRUCTURES REPORTED BY THE OWNER OR THOSE SHOWN ON RECORDS EXAMINED ARE INDICATED WITH THEIR APPROXIMATE LOCATION AND EXTENT. THE CONTRACTOR, BY ACCEPTING THESE PLANS OR PROCEEDING WITH IMPROVEMENTS PURSUANT THERETO, UNDERSTANDS THAT HE AGREES TO ASSUME THE LIABILITY, AND AGREES TO HOLD THE CITY HARMLESS FOR ANY LIABILITY FOR DAMAGE RESULTING FROM THE EXISTENCE OF UNDERGROUND UTILITIES OR STRUCTURES NOT REPORTED TO THE CITY, NOT INDICATED ON THE PUBLIC RECORDS EXAMINED, OR LOCATED AT VARIANCE WITH THAT REPORTED OR SHOWN ON RECORDS EXAMINED. THE CONTRACTOR IS REQUIRED TO TAKE DUE PRECAUTIONARY MEASURES TO PROTECT THE UTILITIES OR STRUCTURES FOUND AT THE SITE. IT SHALL BE THE CONTRACTOR'S RESPONSIBILITY TO NOTIFY THE OWNERS OF THE UTILITIES CONCERNED BEFORE STARTING WORK.
- 23. TYPICAL DETAILS APPLY WHETHER OR NOT THEY ARE SPECIFICALLY REFERENCED ON INDIVIDUAL PLANS, DETAILS OR SECTIONS.
- 24. VERIFY DIMENSIONS AND CONDITIONS AT THE SITE BEFORE STARTING WORK. ANY CONFLICT BETWEEN DETAILS OR DIMENSIONS ON THE DRAWINGS SHALL BE REPORTED PROMPTLY TO THE CITY'S REPRESENTATIVE WHO WILL DETERMINE THE INTENT OF THE DRAWINGS.

TRAFFIC CONTROL

- 1. TRAFFIC CONTROL SHALL INCLUDE ALL MATERIAL, LABOR, AND EQUIPMENT TO PROVIDE SAFE AND EFFECTIVE WORK AREAS AND TO WARN, CONTROL, PROTECT, AND EXPEDITE VEHICULAR, BICYCLE, AND PEDESTRIAN TRAFFIC. ALL WORK AND MATERIAL PROVIDED UNDER THIS SECTION SHALL BE PERFORMED OR FURNISHED IN ACCORDANCE
 - WITH THE FOLLOWING PUBLICATIONS AS APPLICABLE: • STATE OF CALIFORNIA DEPARTMENT OF TRANSPORTATION STANDARD SPECIFICATIONS, LATEST EDITION
 - STATE OF CALIFORNIA DEPARTMENT OF TRANSPORTATION STANDARD PLANS, LATEST EDITION
 - STATE OF CALIFORNIA DEPARTMENT OF TRANSPORTATION "MANUAL ON UNIFORM TRAFFIC CONTROL DEVICES FOR STREETS AND HIGHWAYS (CAMUTCD), LATEST EDITION.
- 2. NO WORK SHALL BE PERFORMED IN PUBLIC RIGHTS-OF-WAY WITHOUT PERMISSION AND PERMITS FROM THE CITY
- 3. CONSTRUCTION AREA, DETOUR, AND SPECIAL SIGNS SHALL BE FURNISHED, INSTALLED, MAINTAINED, AND REMOVED WHEN NO LONGER REQUIRED IN ACCORDANCE WITH THE PROVISIONS IN PART 12, "TEMPORARY TRAFFIC CONTROL" OF THE CALTRANS STD SPECS.

BENCHMARK DATA

KINGSTON AVENUE AT CALLE REAL:

SURVEY DATE 03/07/2018

ASSUMED COORDINATES WERE USED TO PERFORM THIS SURVEY.

BASIS OF BEARINGS - N86°11'08"W AS SHOWN ON SUBDIVISION MAP OF TRACT 12,251 IN BOOK 92, PAGE 69. BETWEEN FOUND MONUMENTS.

TBM - POINT #213 1/2" IRON PIPE & PLASTIC PLUG

MARKED "LS 3804" EL=300.00'

CHAPEL STREET AT HOLLISTER AVENUE:

SURVEY DATE 03/07/2018

ASSUMED COORDINATES WERE USED TO PERFORM THIS SURVEY.

BASIS OF BEARINGS - N86°55'00"W AS SHOWN ON PARCEL MAP NO. 12,958 IN BOOK 23, PAGES 98-99. BETWEEN FOUND MONUMENTS.

TBM - POINT #226 FOUND NAIL & TAG EL=200.00'

ABBREVIATIONS

PROJECT ABBREVIATIONS REFER TO CALTRANS STANDARD PLANS A3A TO A3C AND THE FOLLOWING BELOW:

AB AC ALIGN C&G CB CF Q OR CL CL 2 AB CLF CONST D DI DIA DWY OR D/W E EB EG EL OR ELEV EP EPB OR ELPB EX OR EXIST FG FH FL FS FT GB GL GV H HA HORIZ ICP ICV INV IRR KA LT MAX MH MIN MOD NB NE NW	ASGREGATE BASE ASPHALT CONCRETE ALIGNMENT CURB AND GUTTER CATCH BASIN CURB FACE CENTER LINE CLASS 2 AGGREGATE BASE CHAIN LINK FENCE CONSTRUCT DROP INLET MANHOLE DROP INLET DIAMETER DRIVEWAY EAST EASTBOUND EXISTING GROUND/GRADE ELEVATION EDGE OF PAVEMENT ELECTRIC PULLBOX EXISTING FINISHED GRADE FIRE HYDRANT FLOW LINE FINISHED SURFACE FEET GRADE BREAK GUTTER LIP GAS VALVE CURB HEIGHT HOLLISTER AVENUE HORIZONTAL IRRIGATION CONTROL PAD IRRIGATION CONTROL BOX KINGSTON AVENUE LEFT MAXIMUM MANHOLE MINIMUM MODIFIED NORTHBOUND NORTHEAST NORTHWEST	O/H OR OH OD OG PCC PED PEU PHB POC PPB PROP RCP ROW OR R/W RRFB RT S SB SD SDMH SE SIG SOCAL SNS SS SSMH STA STD STLT SW/SWK TC TCB TCE TEL TSPB TYP UVLT V VC VCP VEH VERT W WB WM WV	OVERHEAD OUTER DIAMETER ORIGINAL GROUND PORTLAND CEMENT CONCRETE PEDESTRIAN PHOTOELECTRIC UNIT PEDESTRIAN HYBRID BEACON POINT OF CONNECTION PEDESTRIAN PUSH BUTTON PROPOSED REINFORCED CONCRETE PIPE RIGHT OF WAY RECTANGULAR RAPID FLASHING BEACON RIGHT SOUTH SOUTHBOUND STORM DRAIN STREET NAME SIGN SEWER SANITARY SEWER MANHOLE STATION STRADARD STREET LIGHT SIDEWALK TOP OF CURB TRAFFIC CONTROL BOX TEMPORARY CONSTRUCTION EASEMENT TELEPHONE TRAFFIC SIGNAL PULL BOX TYPICAL UTILITY VAULT VERIZON VERTICAL CURVE VITRIFIED CLAY PIPE VEHICLE VERTICAL WATER WESTBOUND WATER METER WATER VALVE
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Kimley » Horn

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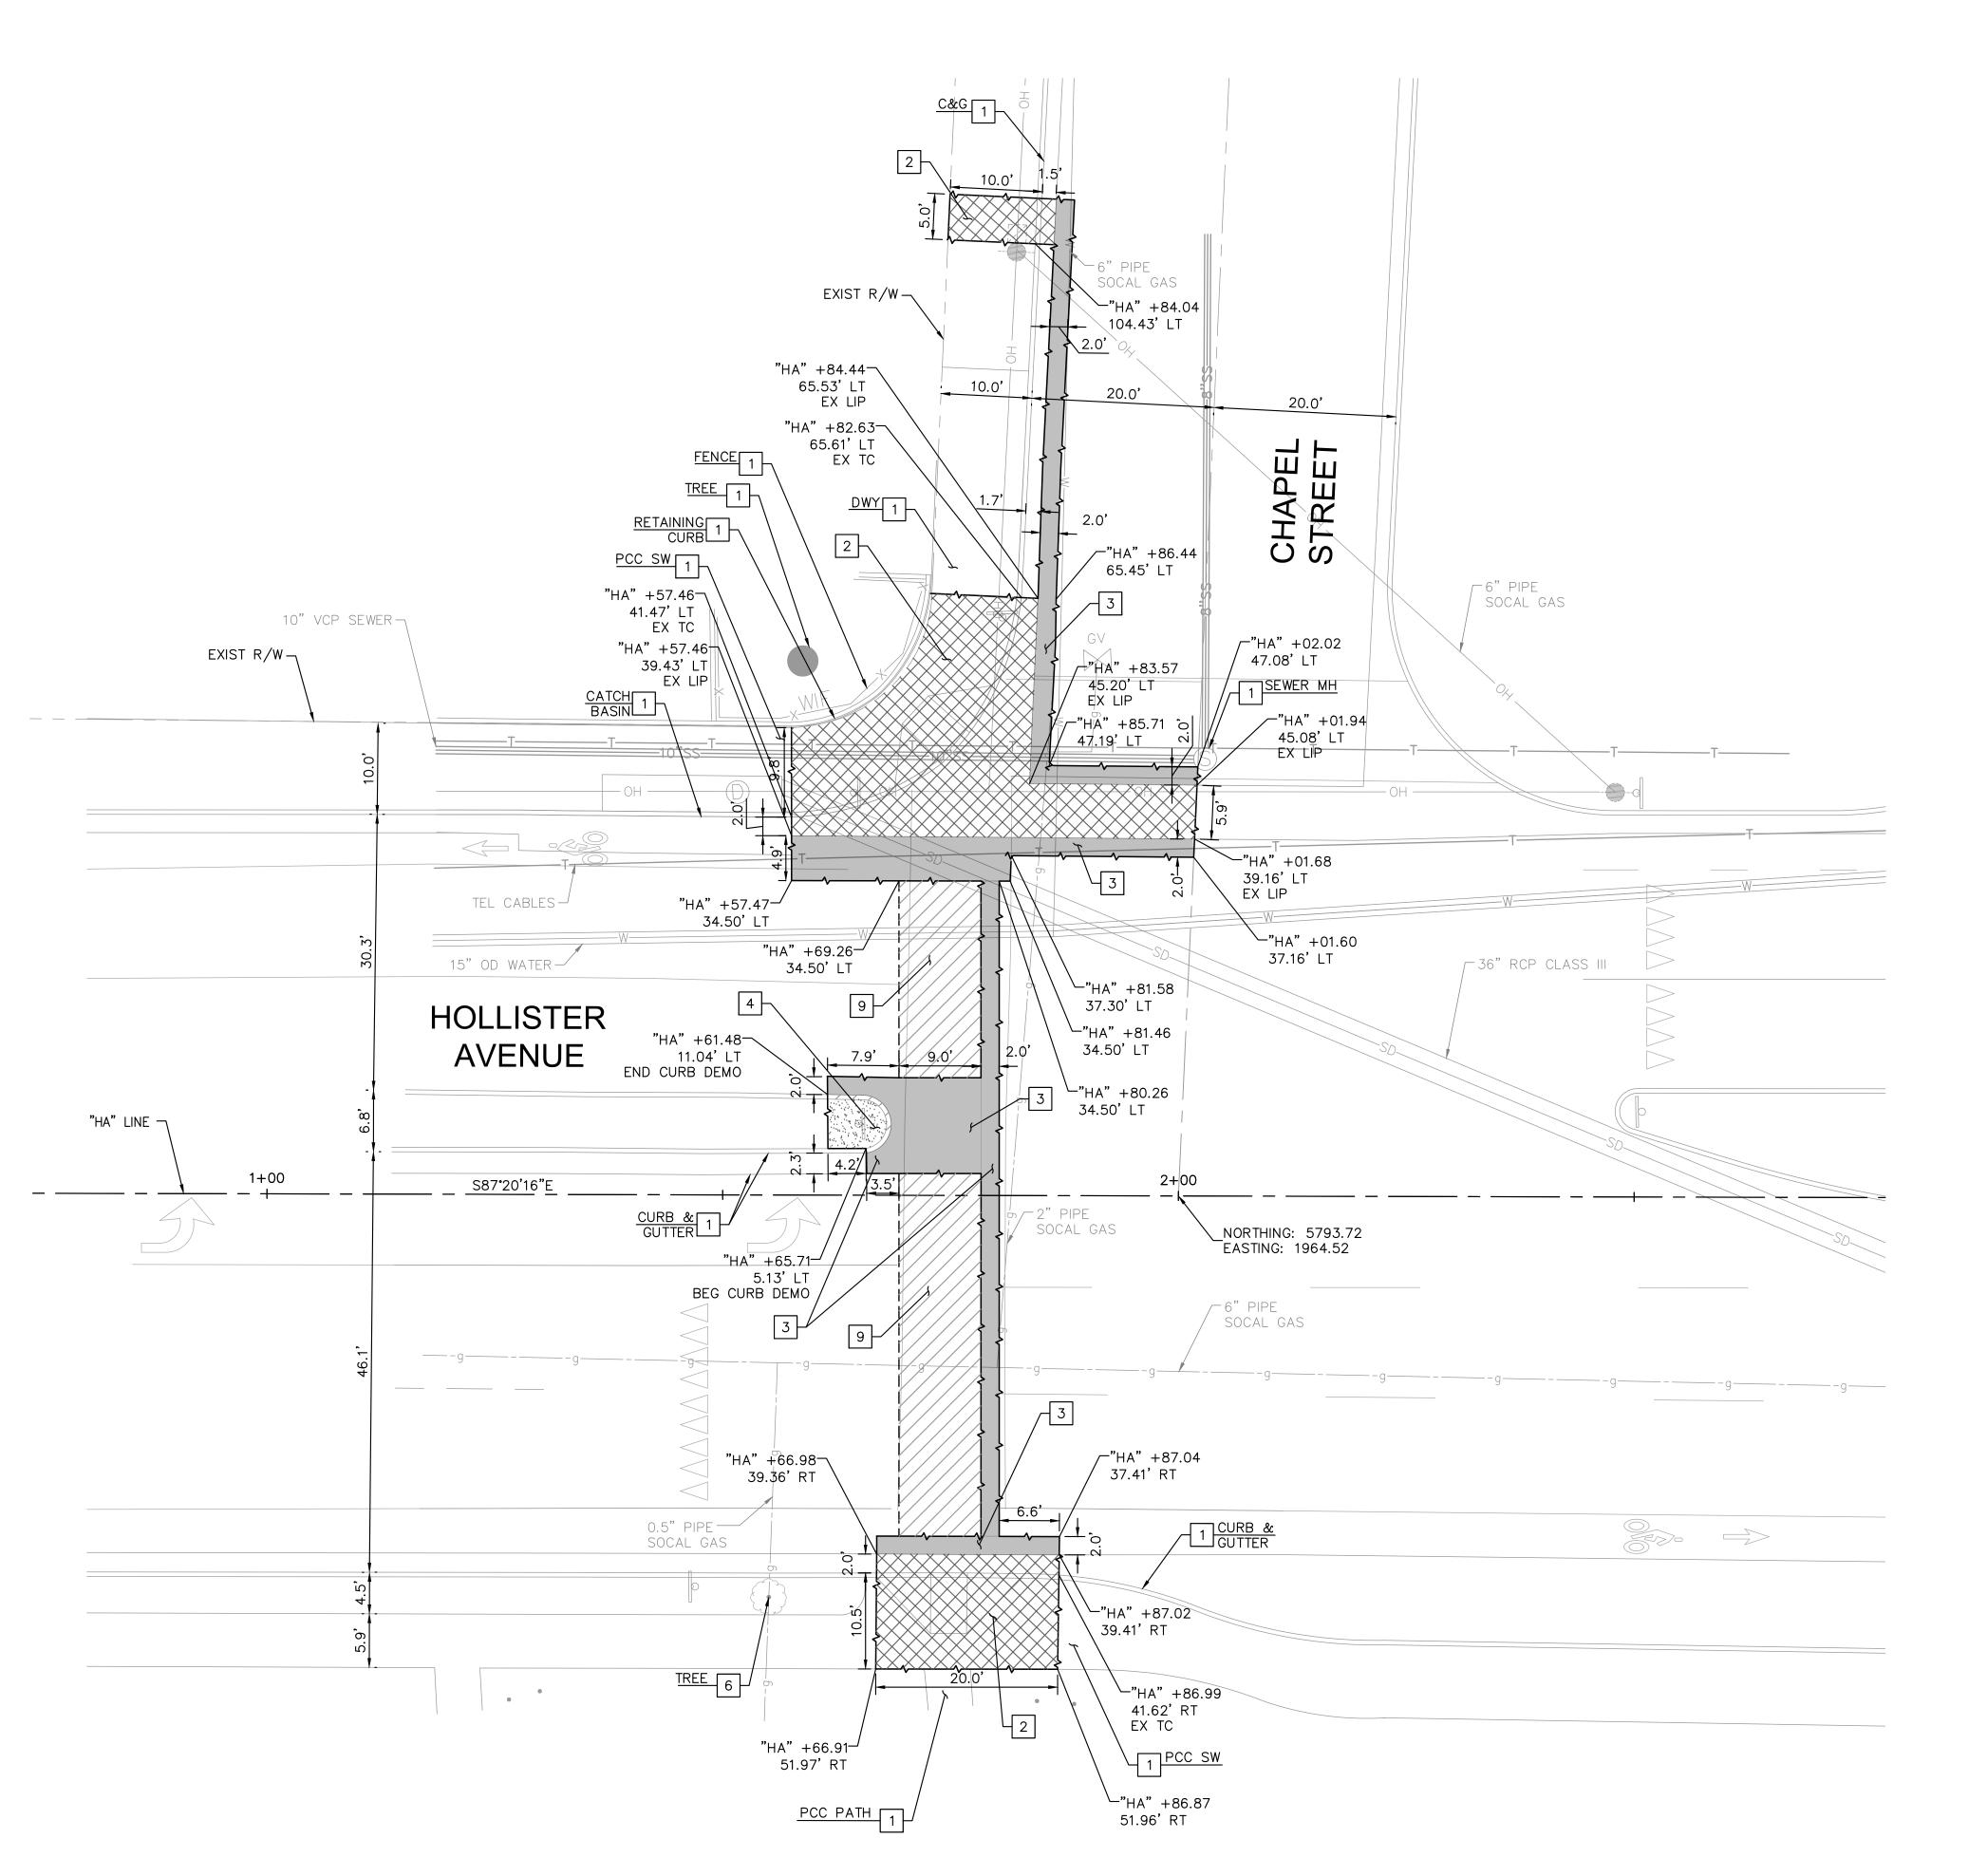
PHONE: 213-261-4040 WWW.KIMLEY-HORN.COM DEPARTMENT

ENGINEERING DIVISION

9058 PRW NO

03-19 DWG. NO.

SHT. 02 OF 16



PROPERTY LINES
ARE APPROXIMATE

Know what's below.

Call before you dig.

GENERAL NOTES

- 1. VERIFY THE EXISTENCE AND HORIZONTAL/VERTICAL LOCATION OF ALL UTILITIES WITHIN THE PROJECT AREA THAT MAY CONFLICT WITH THE PROPOSED CONSTRUCTION. VERIFY THAT ANY UTILITIES SHOWN TO BE RELOCATED BY OTHERS HAVE BEEN RELOCATED AND ARE NO LONGER IN CONFLICT. IMMEDIATELY NOTIFY THE ENGINEER OF ANY REMAINING UTILITY CONFLICTS PRIOR TO THE START OF ANY DEMOLITION WORK.
- 2. CONTRACTOR SHALL MAINTAIN EXISTING ELECTRICAL CIRCUITS FOR EQUIPMENT NOT REMOVED DURING DEMOLITION.
- 3. FOR SIGN REMOVALS OR RELOCATIONS REFER TO SIGNING AND STRIPING PLANS.
- 4. SEE ELECTRICAL PLANS FOR ELECTRICAL AND STREET LIGHTING EQUIPMENT REMOVALS, ADJUSTMENTS, RELOCATIONS, AND NEW INSTALLATIONS.
- 5. UNLESS OTHERWISE SHOWN ON PLANS, CONTRACTOR SHALL CLEAR AND GRUB ALL AREAS WITHIN THE PROJECT GRADING LIMITS AND REMOVE ALL IMPEDANCES FOR THE PROPOSED FACILITIES.

LEGEND

CONCRETE AND BASE REMOVAL (INCLUDES CURB, SIDEWALK, AND OTHER CONCRETE SURFACING IN CONFLICT WITH THE PROPOSED IMPROVEMENTS)

FULL DEPTH ASPHALT CONCRETE REMOVAL AND BASE REMOVAL

CLEAR AND GRUB (3" MIN)

GRIND ASPHALT CONCRETE

SAWCUT ---- LIMIT OF IMPROVEMENTS

DEMOLITION NOTES

- 1 PROTECT IN PLACE.
- 2 SAWCUT, REMOVE, AND DISPOSE OF EXISTING PCC CONCRETE AND BASE TO NEAREST JOINT (SIDEWALK, ADA RAMP, CURB, GUTTER, AND MISCELLANEOUS
- 3 SAWCUT, REMOVE, AND DISPOSE OF EXISTING ASPHALT PAVEMENT, CRUSHED AGGREGATE BASE, AND SUBGRADE TO ESTABLISH FINISHED SURFACE.
- 4 REMOVE VEGETATION, DEBRIS, AND OTHER MATERIAL IN CONFLICT WITH THE
- PROPOSED IMPROVEMENTS (CLEAR AND GRUB 3" MIN). 6 REMOVE TREE TO IMPROVE SIGHT LINES. RELOCATE OR INSTALL NEW PLACEMENT TREE IN LOCATION IDENTIFIED BY THE CITY ENGINEER.
- 9 GRIND 2" DEPTH OF EXISTING ASPHALT PAVEMENT.



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PUBLIC WORKS DEPARTMENT ENGINEERING DIVISION

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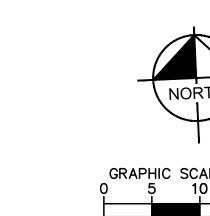
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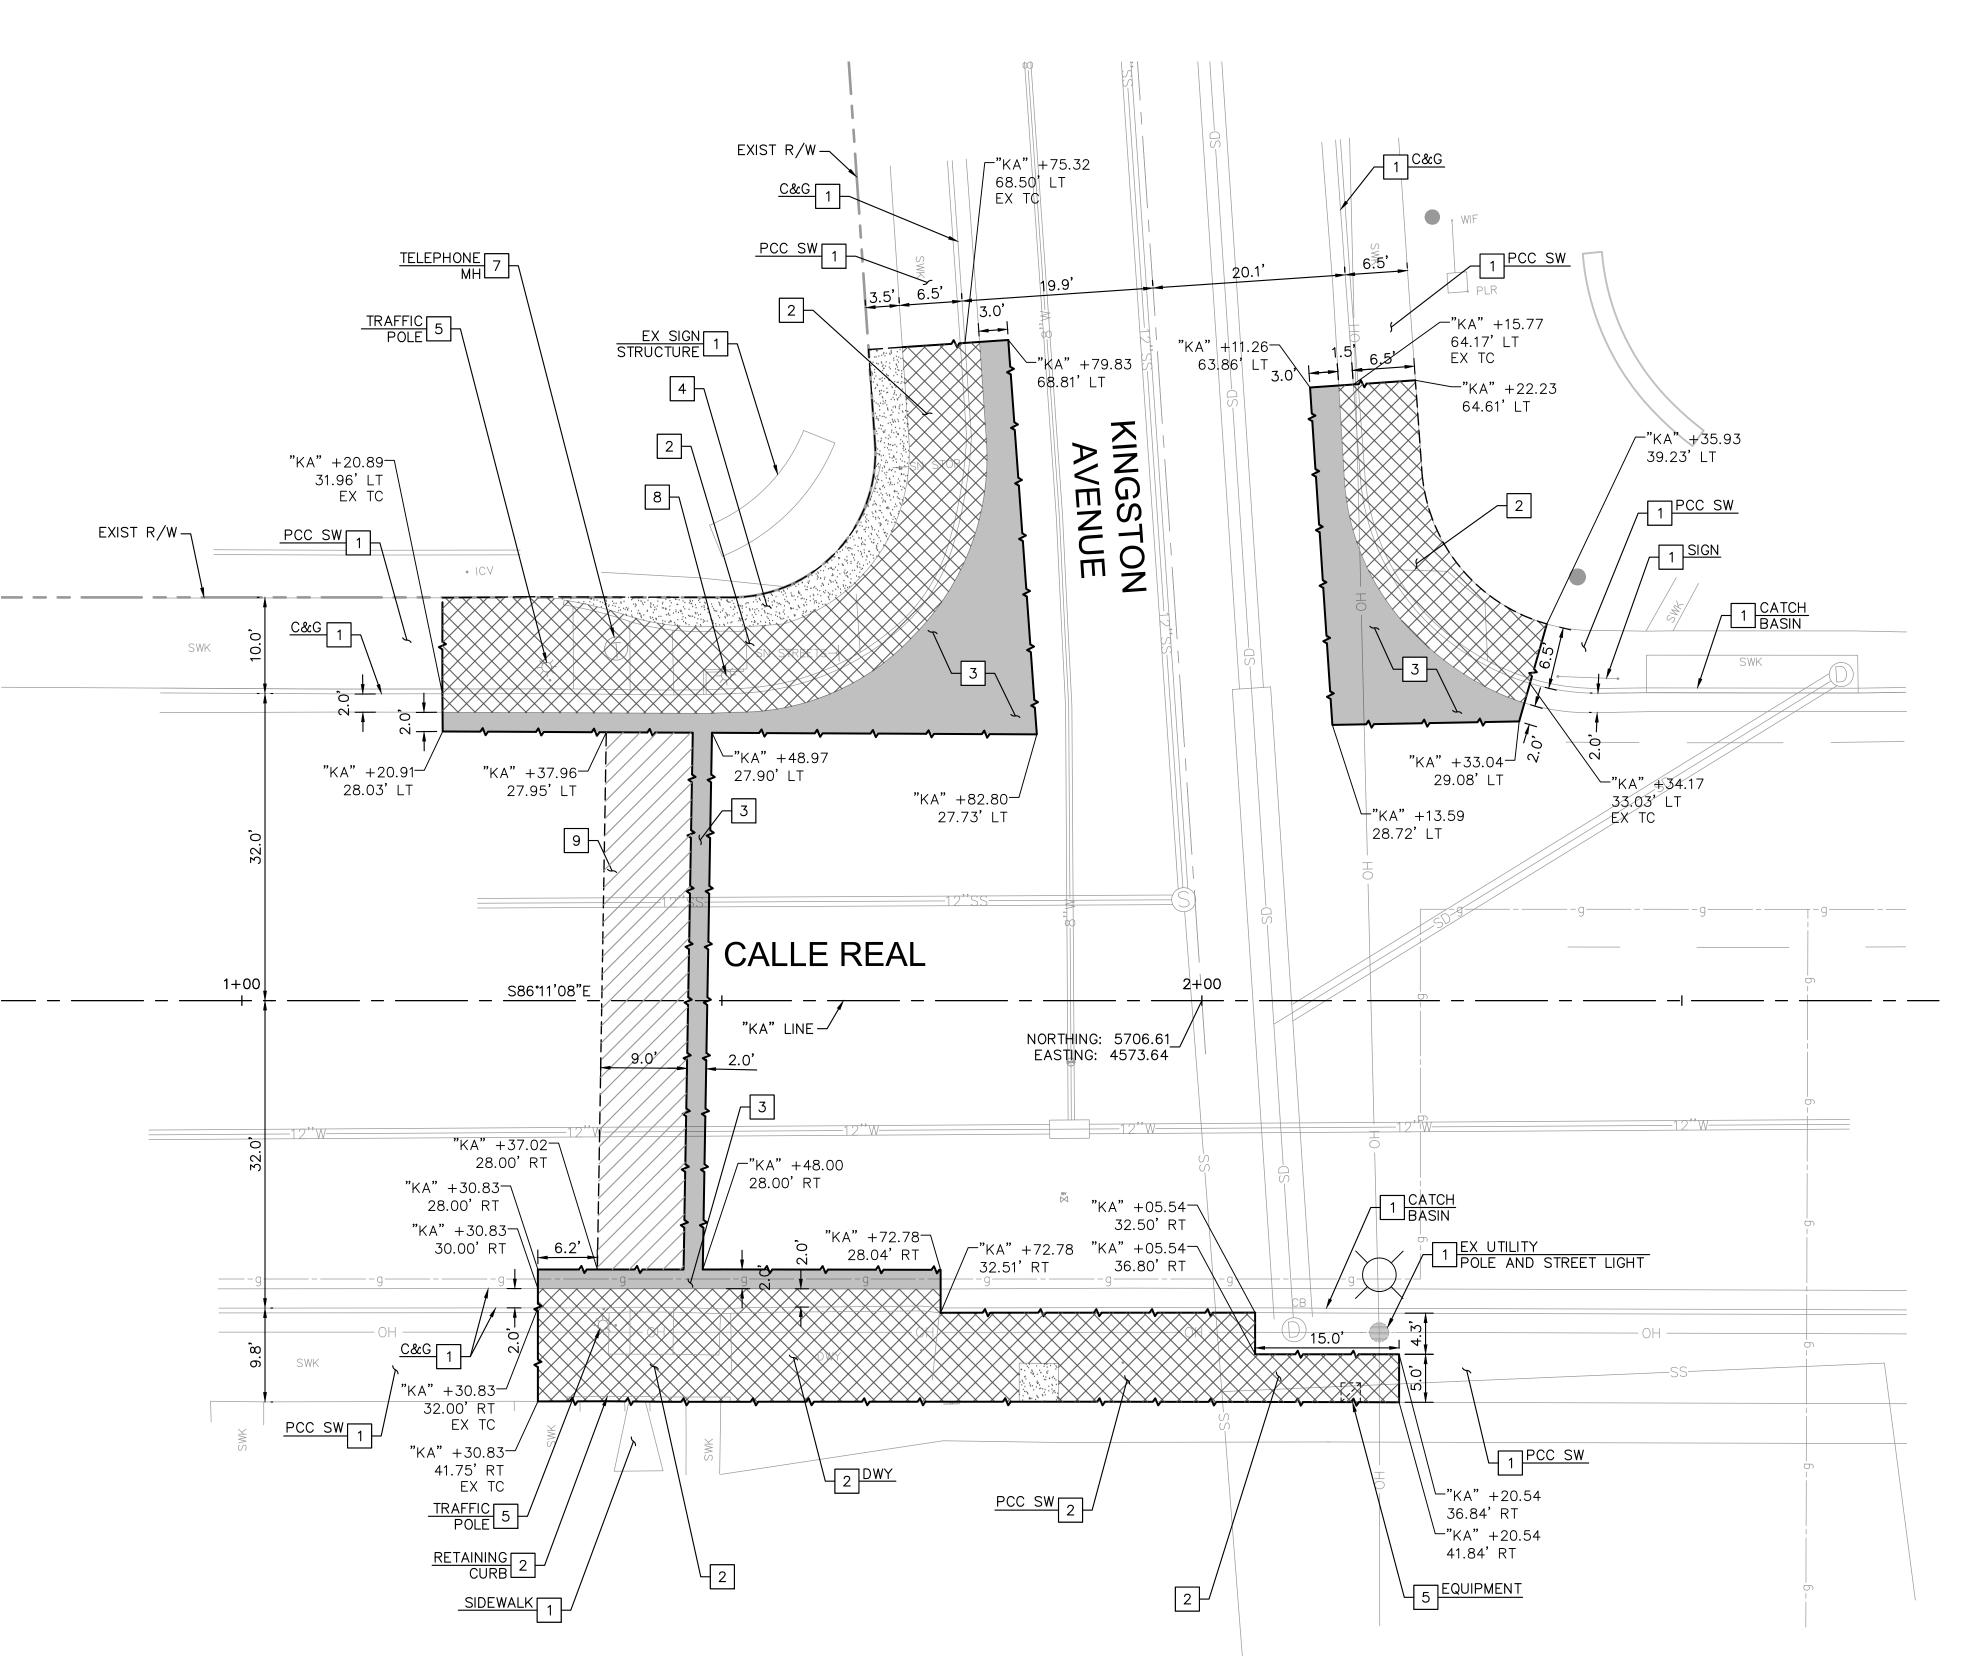
DM-1 DWG. NO.

SHT. 03 OF 16

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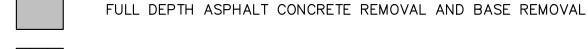




- 1. VERIFY THE EXISTENCE AND HORIZONTAL/VERTICAL LOCATION OF ALL UTILITIES WITHIN THE PROJECT AREA THAT MAY CONFLICT WITH THE PROPOSED CONSTRUCTION. VERIFY THAT ANY UTILITIES SHOWN TO BE RELOCATED BY OTHERS HAVE BEEN RELOCATED AND ARE NO LONGER IN CONFLICT. IMMEDIATELY NOTIFY THE ENGINEER OF ANY REMAINING UTILITY CONFLICTS PRIOR TO THE START OF ANY DEMOLITION WORK.
- 2. CONTRACTOR SHALL MAINTAIN EXISTING ELECTRICAL CIRCUITS FOR EQUIPMENT NOT REMOVED DURING DEMOLITION.
- 3. FOR SIGN REMOVALS OR RELOCATIONS REFER TO SIGNING AND STRIPING PLANS.
- 4. SEE ELECTRICAL PLANS FOR ELECTRICAL AND STREET LIGHTING EQUIPMENT REMOVALS, ADJUSTMENTS, RELOCATIONS, AND NEW INSTALLATIONS.
- 5. UNLESS OTHERWISE SHOWN ON PLANS, CONTRACTOR SHALL CLEAR AND GRUB ALL AREAS WITHIN THE PROJECT GRADING LIMITS AND REMOVE ALL IMPEDANCES FOR THE PROPOSED FACILITIES.

LEGEND

CONCRETE AND BASE REMOVAL (INCLUDES CURB, SIDEWALK, AND OTHER CONCRETE SURFACING IN CONFLICT WITH THE PROPOSED IMPROVEMENTS)




GRIND ASPHALT CONCRETE

CLEAR AND GRUB (3" MIN)

——**√** SAWCUT ---- LIMIT OF IMPROVEMENTS

DEMOLITION NOTES

- 1 PROTECT IN PLACE.
- 2 SAWCUT, REMOVE, AND DISPOSE OF EXISTING PCC CONCRETE AND BASE TO NEAREST JOINT (SIDEWALK, ADA RAMP, CURB, GUTTER, AND MISCELLANEOUS AREAS).
- 3 SAWCUT, REMOVE, AND DISPOSE OF EXISTING ASPHALT PAVEMENT, CRUSHED AGGREGATE BASE, AND SUBGRADE TO ESTABLISH FINISHED SURFACE.
- 4 REMOVE VEGETATION, DEBRIS, AND OTHER MATERIAL IN CONFLICT WITH THE
- PROPOSED IMPROVEMENTS (CLEAR AND GRUB 3" MIN). FREMOVE SERVICE EQUIPMENT ENCLOSURES AND/OR TRAFFIC POLE. SEE ELECTRICAL PLANS.
- 7 ADJUST UTILITIES TO GRADE (TYPE PER PLAN).
- 8 REMOVE EXISTING STREET LIGHT AND FOUNDATION, COMPLETE. RELOCATE EXISTING CITY BANNER TO NEW POLE, SEE SHEET SI-2 FOR DETAILS.
- 9 GRIND 2" DEPTH OF EXISTING ASPHALT PAVEMENT.

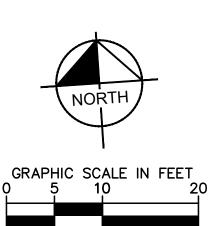



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PUBLIC WORKS DEPARTMENT **ENGINEERING DIVISION**

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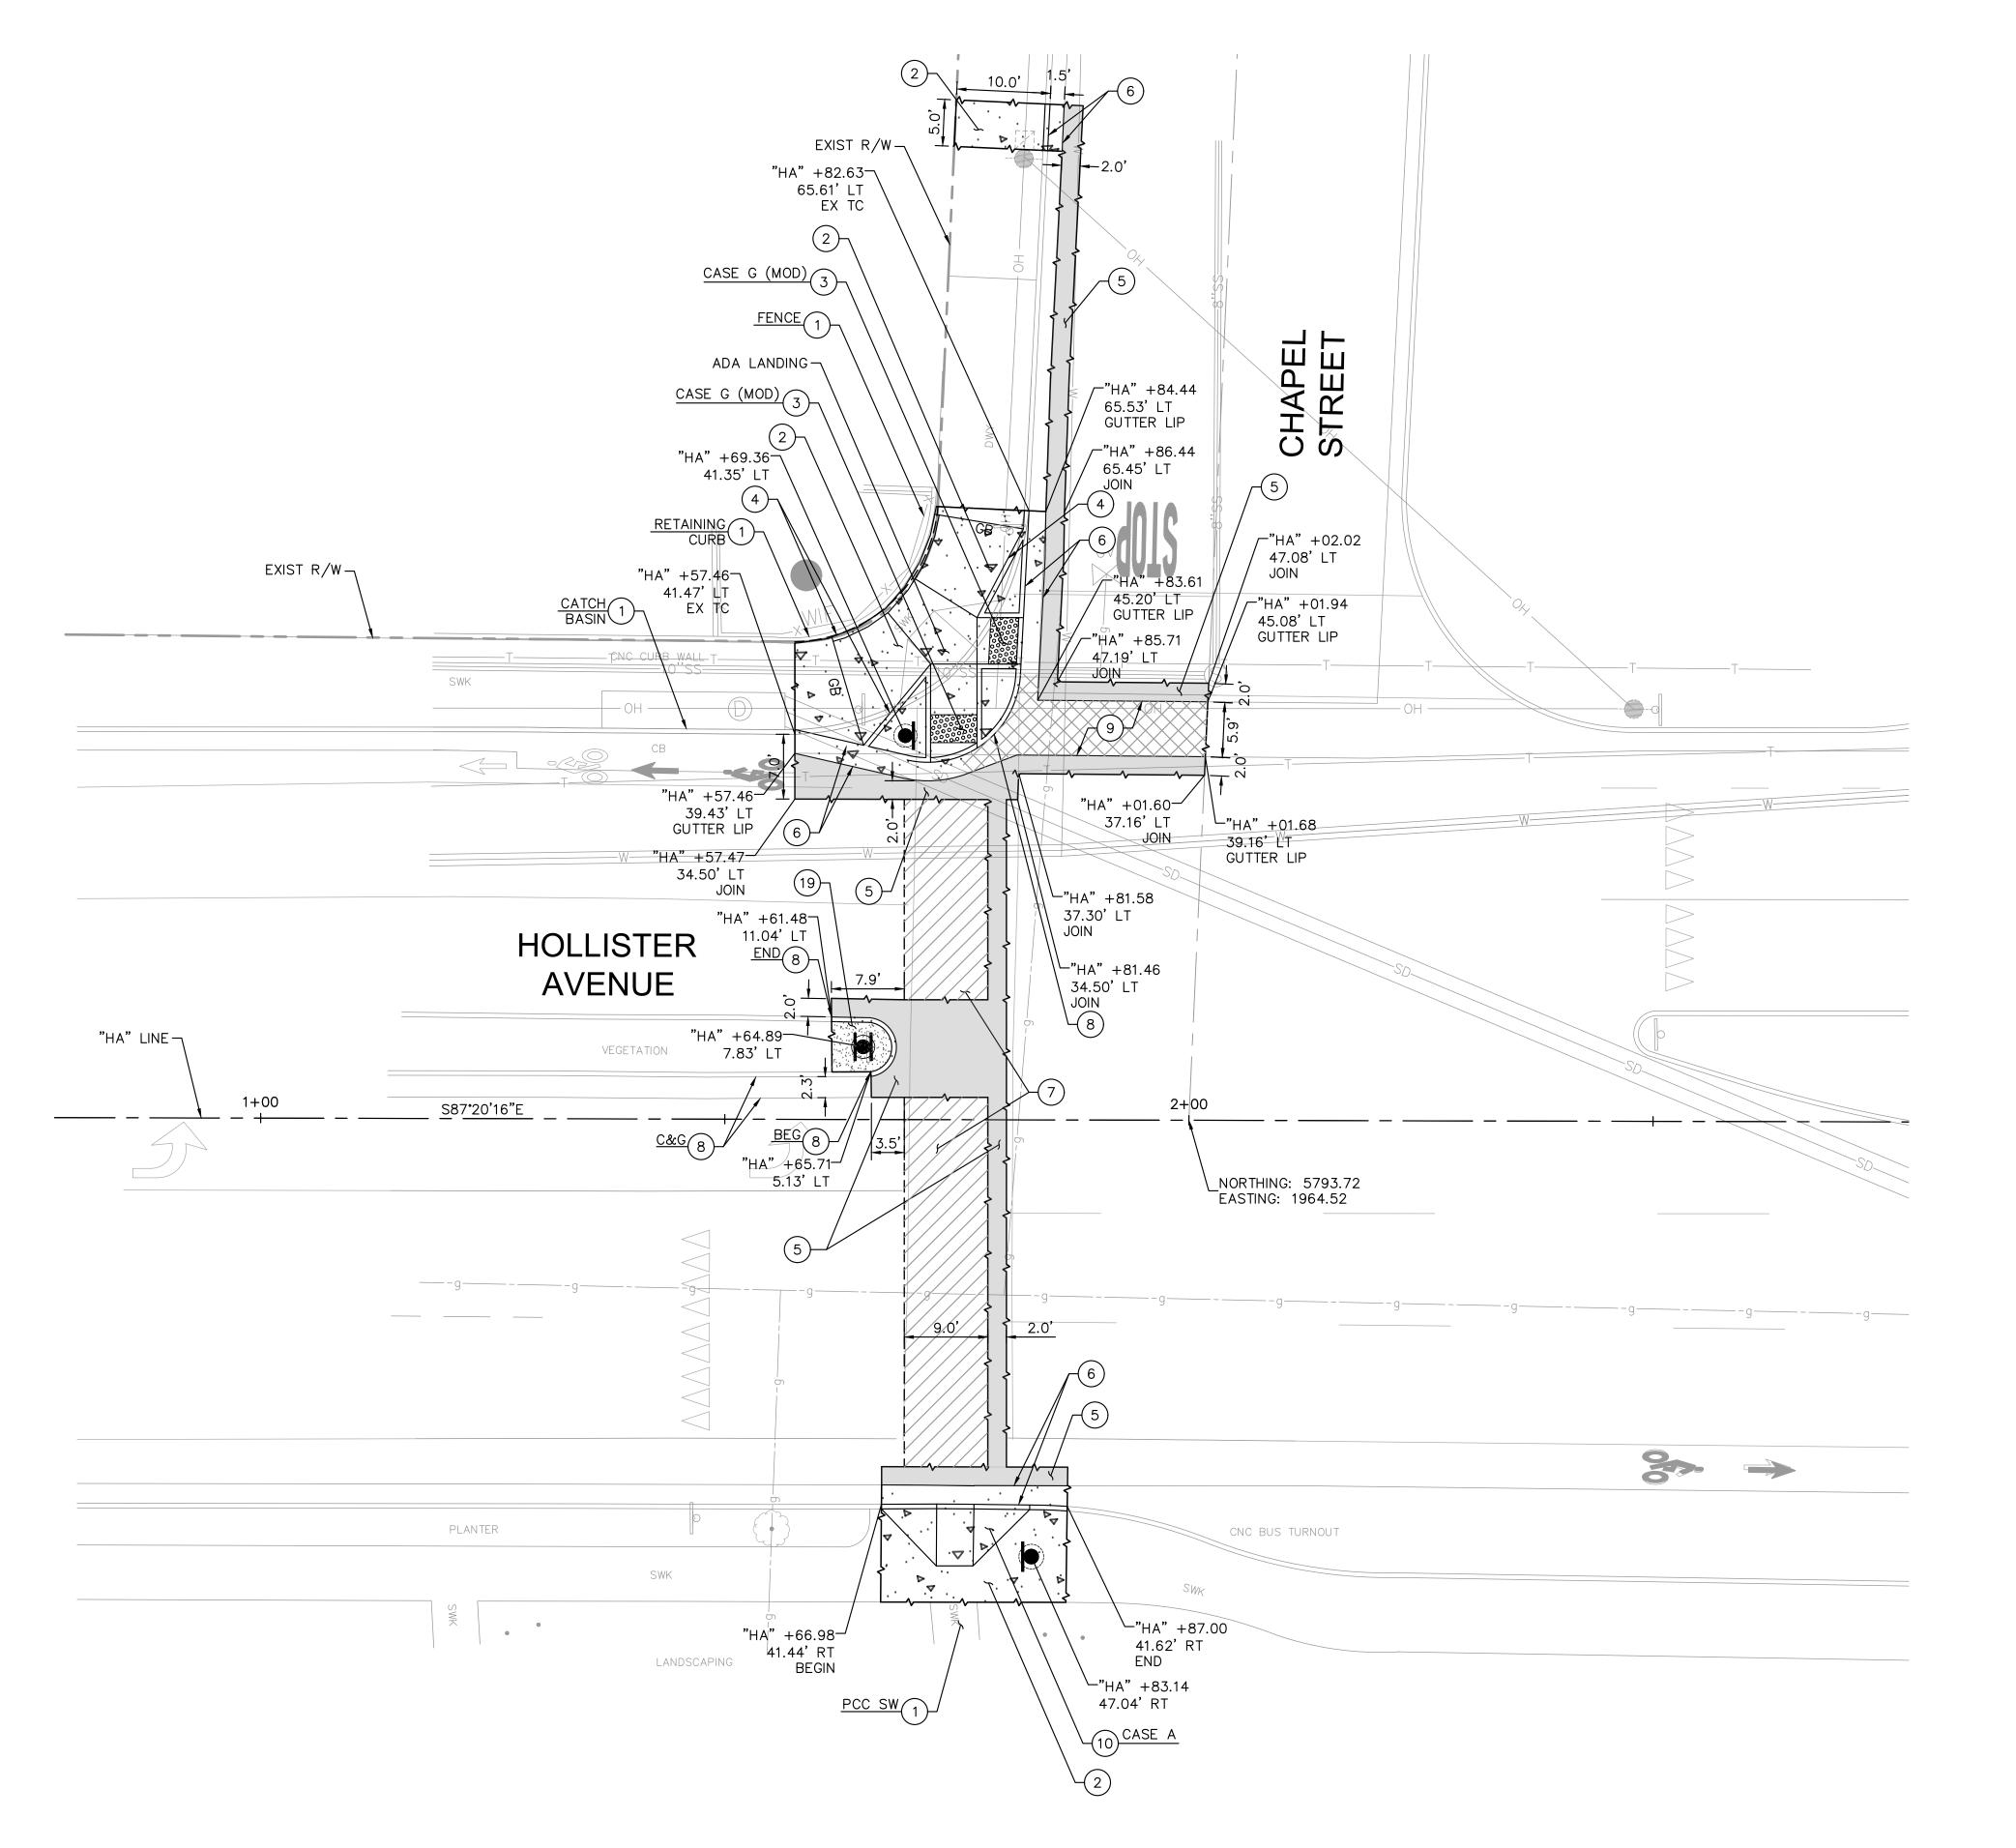
OF

9058

03-19 DM-2

SHT. **04** OF **1**6





- 1. VERIFY THE EXISTENCE AND HORIZONTAL/VERTICAL LOCATION OF ALL UTILITIES WITHIN THE PROJECT AREA THAT MAY CONFLICT WITH THE PROPOSED CONSTRUCTION. VERIFY THAT ANY UTILITIES SHOWN TO BE RELOCATED BY OTHERS HAVE BEEN RELOCATED AND ARE NO LONGER IN CONFLICT. IMMEDIATELY NOTIFY THE ENGINEER OF ANY REMAINING UTILITY CONFLICTS PRIOR TO THE START OF ANY CONSTRUCTION WORK.
- 2. ALL GUTTER SLOPES AT PEDESTRIAN RAMPS SHALL NOT EXCEED 4.5%, SEE CONSTRUCTION DETAIL PLANS FOR MORE INFORMATION.
- 3. ALL SIDEWALK SHALL MATCH EXISTING SIDEWALK PATTERN, COLOR, AND FINISH.
- 4. FOR SIGN REMOVALS OR RELOCATIONS REFER TO SIGNING AND STRIPING PLAN, SHEET SS-1.
- 5. SEE ELECTRICAL PLANS FOR REMOVALS, RELOCATIONS, AND/OR ADJUSTMENTS OF RRFB POLES AND RELATED IMPROVEMENTS, SHEETS E-1.
- 6. CONTRACTOR SHALL MAINTAIN EXISTING ELECTRICAL CIRCUITS FOR EQUIPMENT NOT REMOVED DURING DEMOLITION.
- 7. EXISTING WATER METERS AND FIRE HYDRANTS SHALL REMAIN IN OPERATION UNTIL NEW SYSTEMS ARE OPERATIONAL. SEE UTILITY PLANS FOR IMPROVEMENTS.
- 8. SEE CONSTRUCTION DETAIL SHEET, CD-3, FOR LINE AND CURVE TABLE, OFFSETS, AND ELEVATIONS.

LEGEND

PCC SIDEWALK AND BASE



PCC LONGITUDINAL GUTTER



ASPHALT CONCRETE OVERLAY (2")

ASPHALT CONCRETE FULL DEPTH AND BASE



DETECTABLE WARNING SURFACE

SAWCUT WITH FULL DEPTH REMOVALS


GRADE BREAK

RRFB/SEE ELECTRICAL PLAN E-1

LIMIT OF IMPROVEMENTS


CONSTRUCTION NOTES

- 1) PROTECT IN PLACE.
- 2 CONSTRUCT 4" PCC SIDEWALK OVER 6" CL 2 AGGREGATE BASE PER SPPWC STD PLAN 112-2.
- 3 CONSTRUCT CURB RAMP (CASE PER PLAN) PER CALTRANS STD PLAN RSP A88A WITH 3' DEEP DETECTABLE WARNING SURFACE (COLOR YELLOW). DIMENSIONS AND ELEVATIONS PER SHEETS CD-3 CD-5.
- (4) CONSTRUCT 6" RETAINING CURB PER SPPWC STD PLAN 120-2, TYPE A1-6.
- 5 CONSTRUCT FULL DEPTH AC PAVEMENT, 6" AC PAVEMENT OVER 15" CL 2 AGGREGATE BASE, OVER COMPACTED SUBGRADE.
- 6 CONSTRUCT 6" CURB WITH GUTTER PER MODIFIED SPPWC STD PLAN 120-2, TYPE
- (7) CONSTRUCT 2" AC OVERLAY.
- 8 CONSTRUCT 6" CURB PER SPPWC STD PLAN 120-2, TYPE A1-6 (WITHIN LONGITUDINAL GUTTER).
- (9) CONSTRUCT CONCRETE LONGITUDINAL GUTTER PER SPPWC STD PLAN 122-2.
- (10) ADJUST CURB RAMP FLARE.
- (19) CONSTRUCT MIN 6" NATIVE SOIL TO FINISHED GRADE.

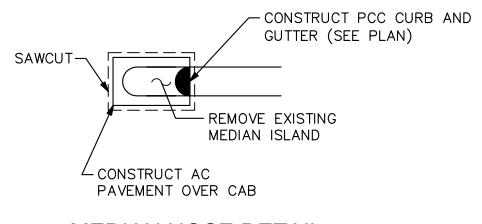

MEDIAN NOSE DETAIL (NO SCALE)



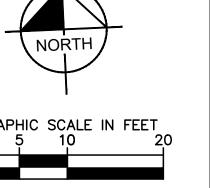



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PUBLIC WORKS DEPARTMENT ENGINEERING DIVISION

OF


9058 PBW. NO.

DWG. NO.

SHT. 05 OF 16

03-19



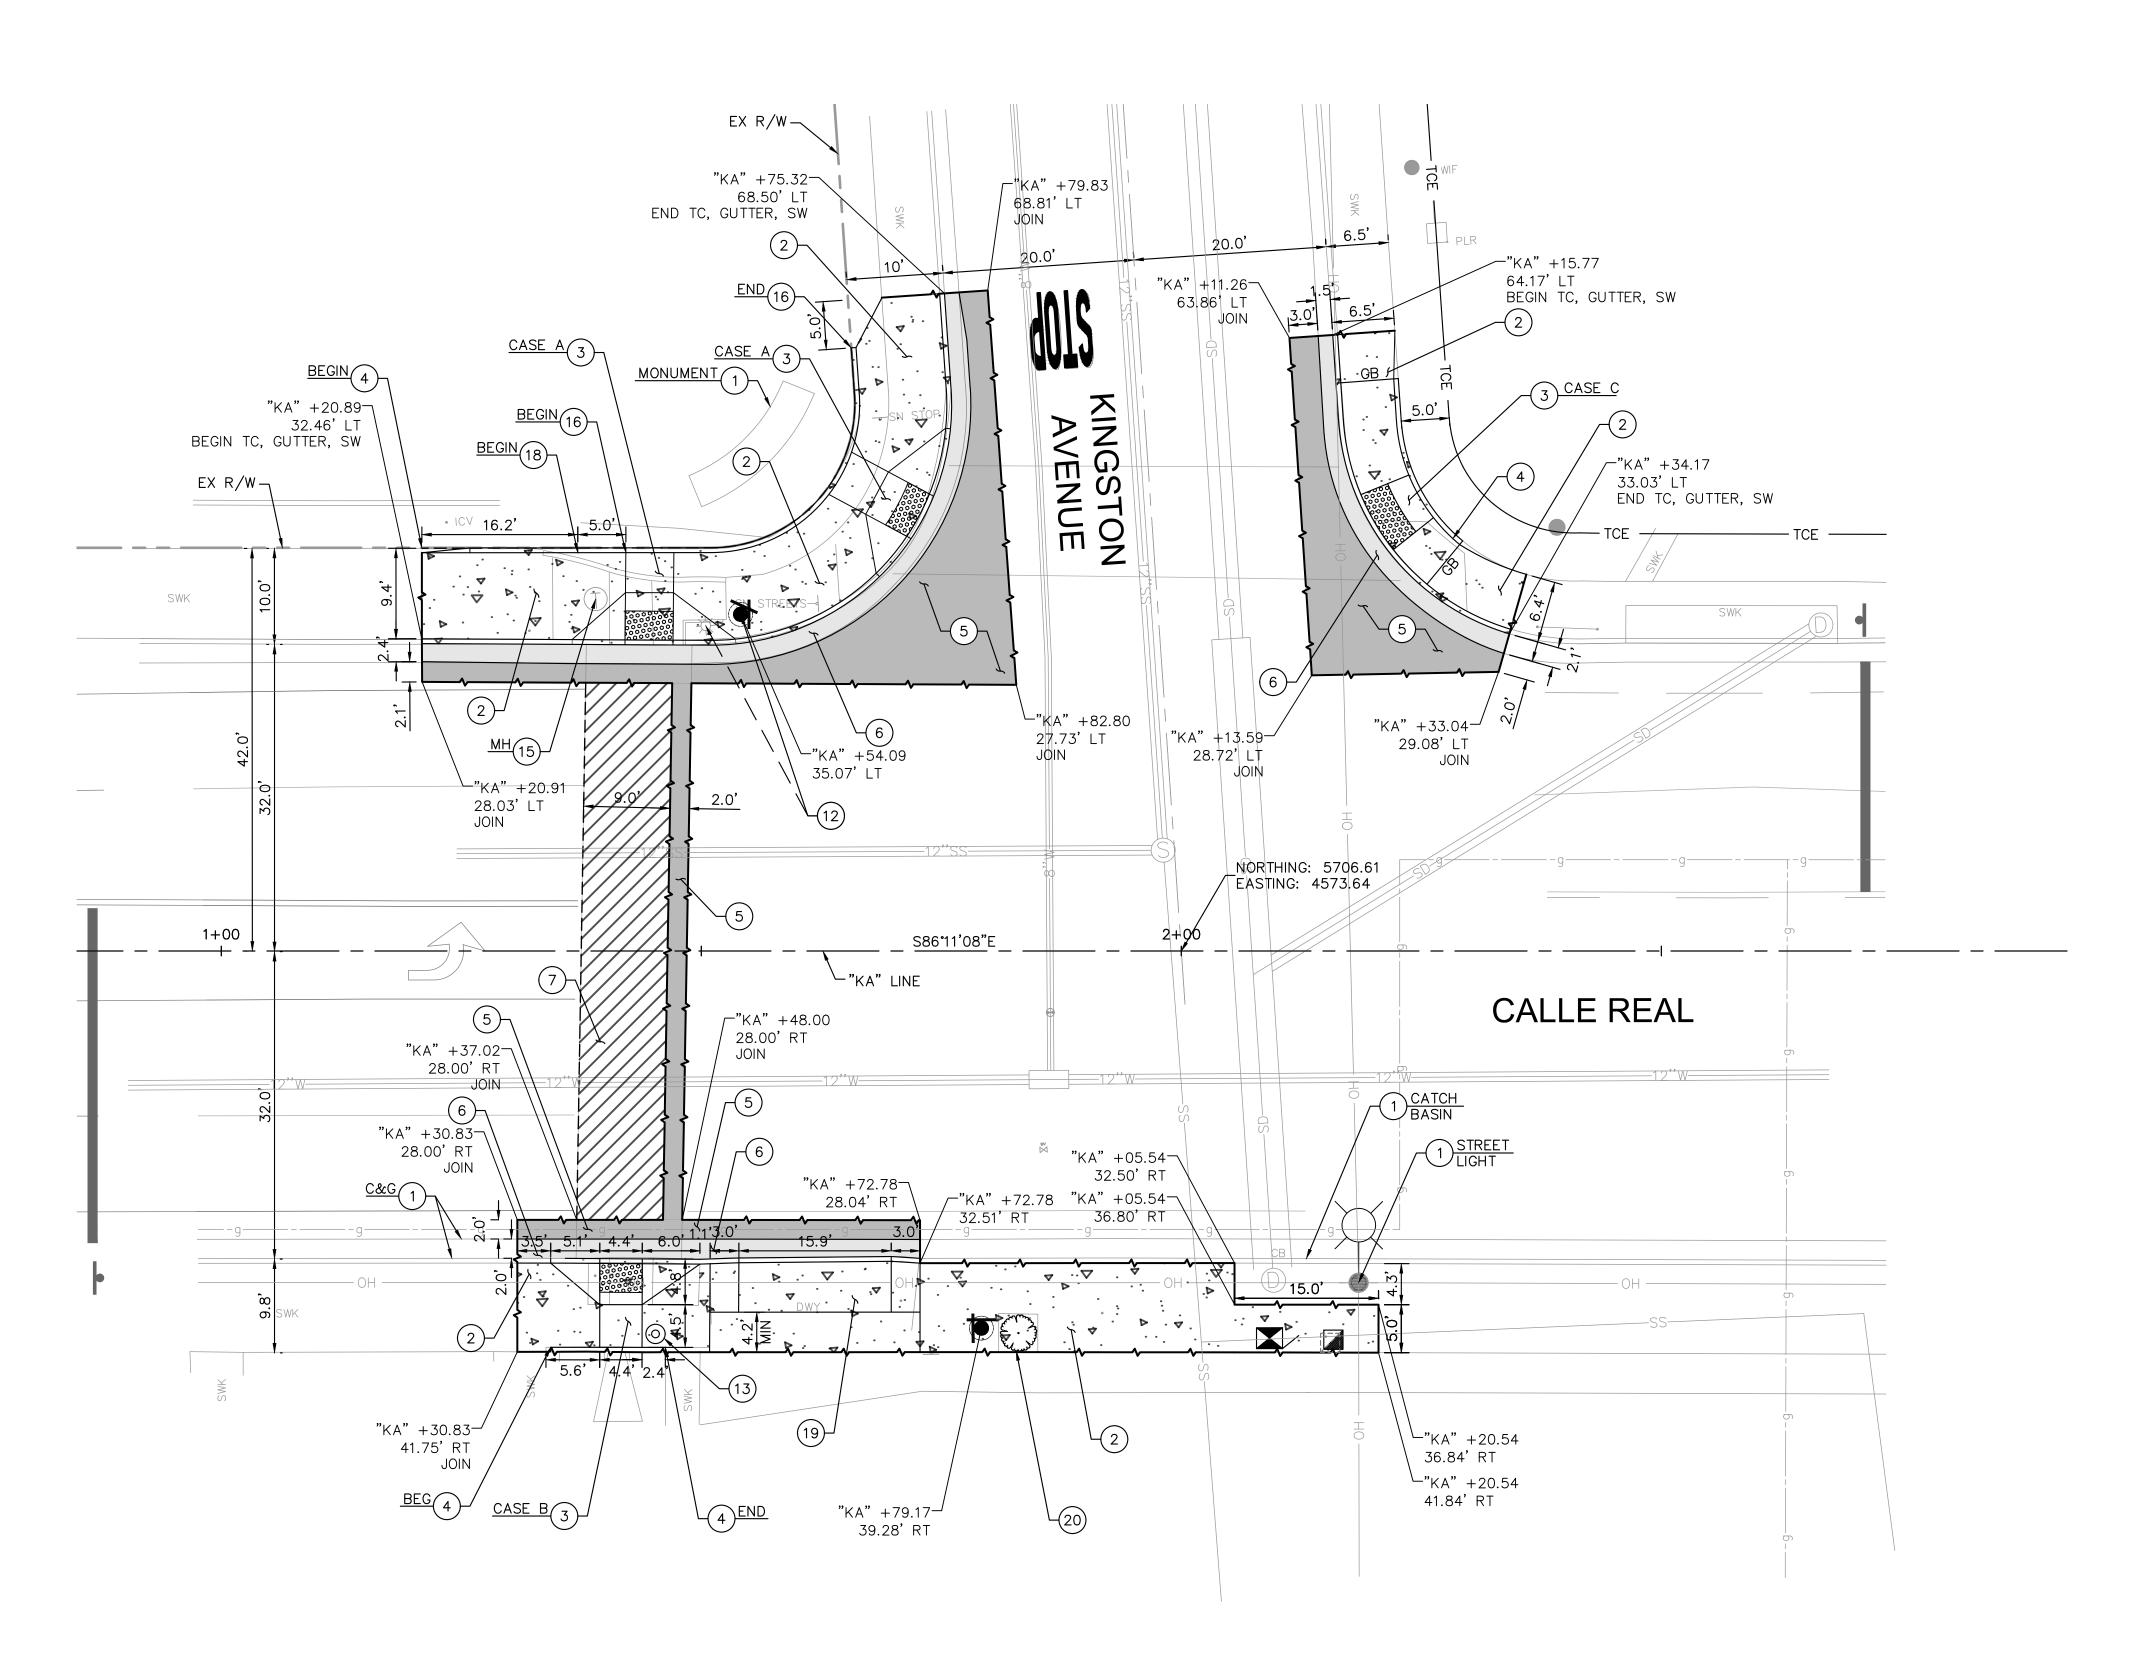





- 1. VERIFY THE EXISTENCE AND HORIZONTAL/VERTICAL LOCATION OF ALL UTILITIES WITHIN THE PROJECT AREA THAT MAY CONFLICT WITH THE PROPOSED CONSTRUCTION. VERIFY THAT ANY UTILITIES SHOWN TO BE RELOCATED BY OTHERS HAVE BEEN RELOCATED AND ARE NO LONGER IN CONFLICT. IMMEDIATELY NOTIFY THE ENGINEER OF ANY REMAINING UTILITY CONFLICTS PRIOR TO THE START OF ANY CONSTRUCTION WORK.
- 2. ALL GUTTER SLOPES AT PEDESTRIAN RAMPS SHALL NOT EXCEED 4.5%, SEE CONSTRUCTION DETAIL PLANS FOR MORE INFORMATION.
- 3. ALL SIDEWALK SHALL MATCH EXISTING SIDEWALK PATTERN, COLOR, AND FINISH.
- 4. FOR SIGN REMOVALS OR RELOCATIONS REFER TO SIGNING AND STRIPING PLAN, SHEET SS-2.
- 5. SEE ELECTRICAL PLANS FOR REMOVALS, RELOCATIONS, AND/OR ADJUSTMENTS OF PHB POLES AND RELATED IMPROVEMENTS, SHEETS E-2.
- REMOVED DURING DEMOLITION.

 7. EXISTING WATER METERS AND FIRE HYDRANTS SHALL REMAIN IN OPERATION UNTIL

6. CONTRACTOR SHALL MAINTAIN EXISTING ELECTRICAL CIRCUITS FOR EQUIPMENT NOT

8. SEE CONSTRUCTION DETAIL SHEET, CD-4 AND CD-5, FOR LINE AND CURVE TABLE, OFFSETS, AND ELEVATIONS.

NEW SYSTEMS ARE OPERATIONAL. SEE UTILITY PLANS FOR IMPROVEMENTS.

LEGEND

PCC SIDEWALK AND BASE

PCC GUTTER

FULL DEPTH AND BASE ASPHALT CONCRETE



ASPHALT CONCRETE OVERLAY (2")



DETECTABLE WARNING SURFACE

MINOR GRADING CONFORM

SAWCUT WITH FULL DEPTH REMOVALS

---- LIMIT OF IMPROVEMENTS

GB GRADE BREAK


PHB/SEE ELECTRICAL PLAN E-2


PHB/SEE ELECTRICAL PLAN E-2

CONSTRUCTION NOTES

- 1) PROTECT IN PLACE.
- 2 CONSTRUCT 4" PCC SIDEWALK OVER 6" CL 2 AGGREGATE BASE PER SPPWC STD PLAN 112-2.
- 3 CONSTRUCT CURB RAMP (CASE PER PLAN) PER CALTRANS STD PLAN RSP A88A WITH 3' DEEP DETECTABLE WARNING SURFACE (COLOR YELLOW). DIMENSIONS AND ELEVATIONS PER SHEETS CD-3 CD-5.
- 4 CONSTRUCT 6" RETAINING CURB PER SPPWC STD PLAN 120-2, TYPE A1-6.
- 5 CONSTRUCT FULL DEPTH AC PAVEMENT, 6" AC PAVEMENT OVER 15" CL 2 AGGREGATE BASE, OVER COMPACTED SUBGRADE.
- 6 CONSTRUCT 6" CURB WITH GUTTER PER MODIFIED SPPWC STD PLAN 120-2, TYPE
- (7) CONSTRUCT 2" AC OVERLAY.
- (12) RELOCATE CITY BANNER TO NEW POLE.
- (13) CONSTRUCT PEDESTRIAN PUSH BUTTON ASSEMBLY COMPLETE (SEE ELECTRICAL PLANS AND CONSTRUCTION DETAILS).
- (15) ADJUST UTILITY TO FINAL GRADE (BY OTHERS).
- (16) CONSTRUCT 12" RETAINING CURB.
- 18) TRANSITION FROM 6" CURB TO 12" CURB OVER 5 LF PER SPPWC STD PLAN 120-2.
- (19) CONSTRUCT MIN 6" NATIVE SOIL TO FINISHED GRADE.
- (20) INSTALL NEW TREE, TYPE PER CITY ENGINEER.



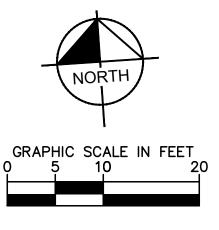

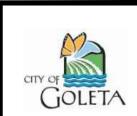

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DEPARTMENT
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PROVED:

2/30/20
TY ENGINEER

DATE

CHECKED APPROVED:

CHECKED CITY ENGINEER

REVISIONS

AMA: 3/30/2020 7:24 DM

HB KINGSTON AVENUE


S CHAPEL, PHB KIN IMPROVEMENT PLAN - KINGS

9058 PBW. NO.

9058 PBW. NO. 03-19 BID NO. SHT. DES. SI-2

DWG. NO.

SHT. 06 OF 16

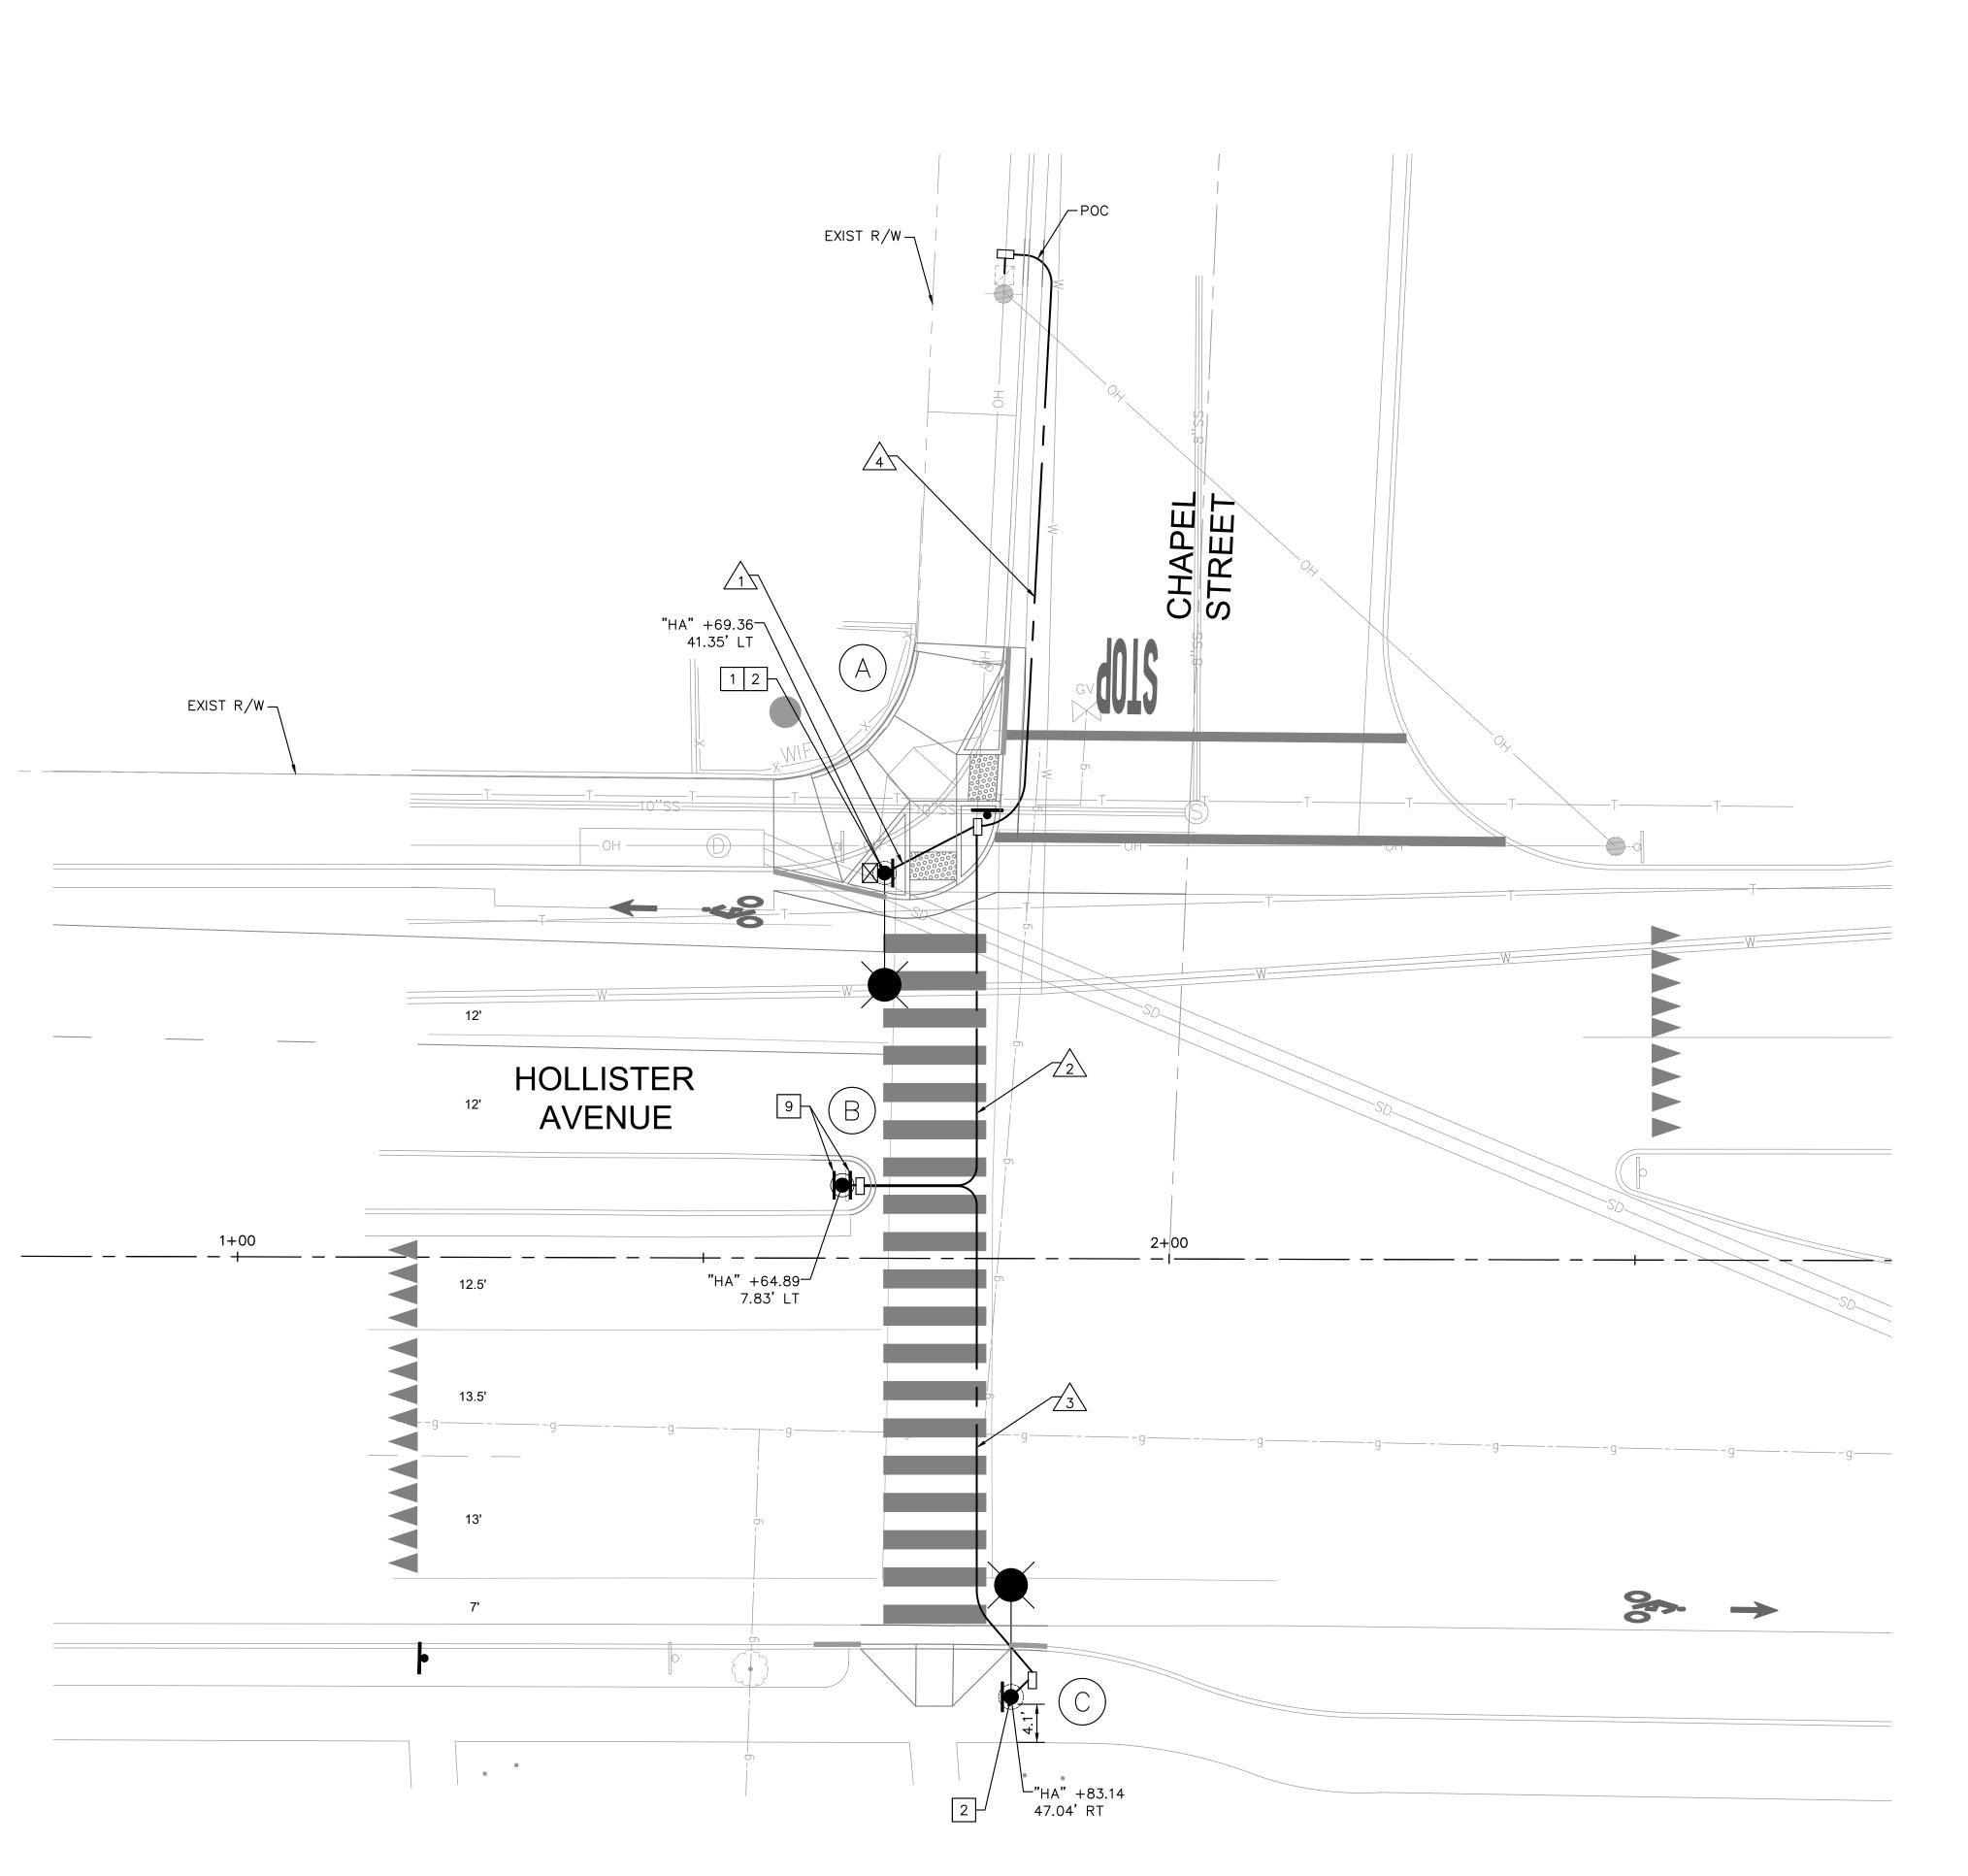

PROPERTY LINES
ARE APPROXIMATE

Know what's **below. Call** before you dig.

GENERAL NOTES

- 1. EQUIPMENT IN THE FIELD SHALL OPERATE ACCORDING TO THE DESIGN SPECIFIED IN THE PLAN AND SPECIFICATIONS AND TO THE SATISFACTION OF THE ENGINEER-IN-THE-FIELD. 2. OBTAIN APPROVAL FOR EXACT EQUIPMENT LOCATION PRIOR TO FINAL PLACEMENT.
- 3. ALL MATERIALS AND EQUIPMENT SHALL BE NEW, FURNISHED AND INSTALLED BY THE CONTRACTOR UNLESS OTHERWISE NOTED ON THE PLANS.
- 4. ALL TRAFFIC SIGNAL POLES AND FERROUS MATERIALS SHALL BE GALVANIZED.
- 5. SEE SIGNING AND STRIPING PLANS FOR FOR TRAFFIC STRIPING, PAVEMENT MARKERS, PAVEMENT MARKINGS, AND TRAFFIC SIGNS.
- 6. SEE DEMOLITION AND UTILITY PLANS FOR REMOVALS AND UTILITY IMPROVEMENTS.
- 7. ALL PULLBOXES SHALL BE NO. 5, UNLESS OTHERWISE NOTED ON PLAN.

LEGEND

RRFB (SEE CONSTRUCTION DETAILS, CD-1 FOR RRFB AND APPLICABLE SIGN MOUNTING)

PEDESTRIAN PUSH BUTTON

CONDUIT

CONSTRUCTION NOTES

LUMINAIRE

- 1 FURNISH AND INSTALL POLE-MOUNTED CONTROL CABINET. SEE SHEET CD-1 FOR DETAILS.
- FURNISH AND INSTALL RECTANGULAR RAPID FLASHING BEACONS PER TAPCO OR APPROVED EQUAL ON NEW POLE AND FOUNDATION. SEE SHEET CD-1 FOR DETAILS AND APPLICABLE SIGNS. FURNISH AND INSTALL NEW POLE AND EQUIPMENT PER POLE SCHEDULE.
- 9 FURNISH AND INSTALL RECTANGULAR RAPID FLASHING BEACONS PER TAPCO OR APPROVED EQUAL ON NEW 12 GAGE SQUARE PERFORATED UNISTRUT—TELESPAR POST, OR APPROVED EQUAL. SEE SHEET CD—1 FOR DETAILS AND APPLICABLE SIGNS.

POLE AND EQUIPMENT SCHEDULE •


		STANDARI)		VEH SIG	MTG	PED SIGNAL	PPB	LED
No.	Туре	Height	SMA	LMA	MAST ARM	POLE	MTG	Ø	LUMINAIRE
A	15TS	30'	1	12'	-	-	1	Е	165W
B	15-FBS	18'	-	-	-	-	-	-	-
(C)	15TS	30'	-	12'	-	-	-	W	165W


ALL EQUIPMENT IS NEW UNLESS OTHERWISE NOTED

CONDUCTOR SCHEDULE ●							
AWG OR	AWG OR RUN NUMBER						
CABLE	CONDUCTOR RUN	1	2	3	4		
C1	5 CSC	2	2	1	1		
#10	LUMINAIRE	2	2	2	2		
#6	SERVICE	3	-	-	3		
#8	1	1	1	1			
CONDUIT SIZE		3"	3"	3"	3"		

ALL EQUIPMENT IS NEW UNLESS OTHERWISE NOTED



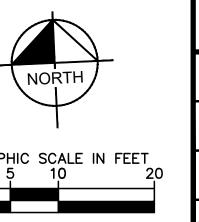

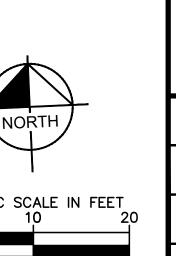

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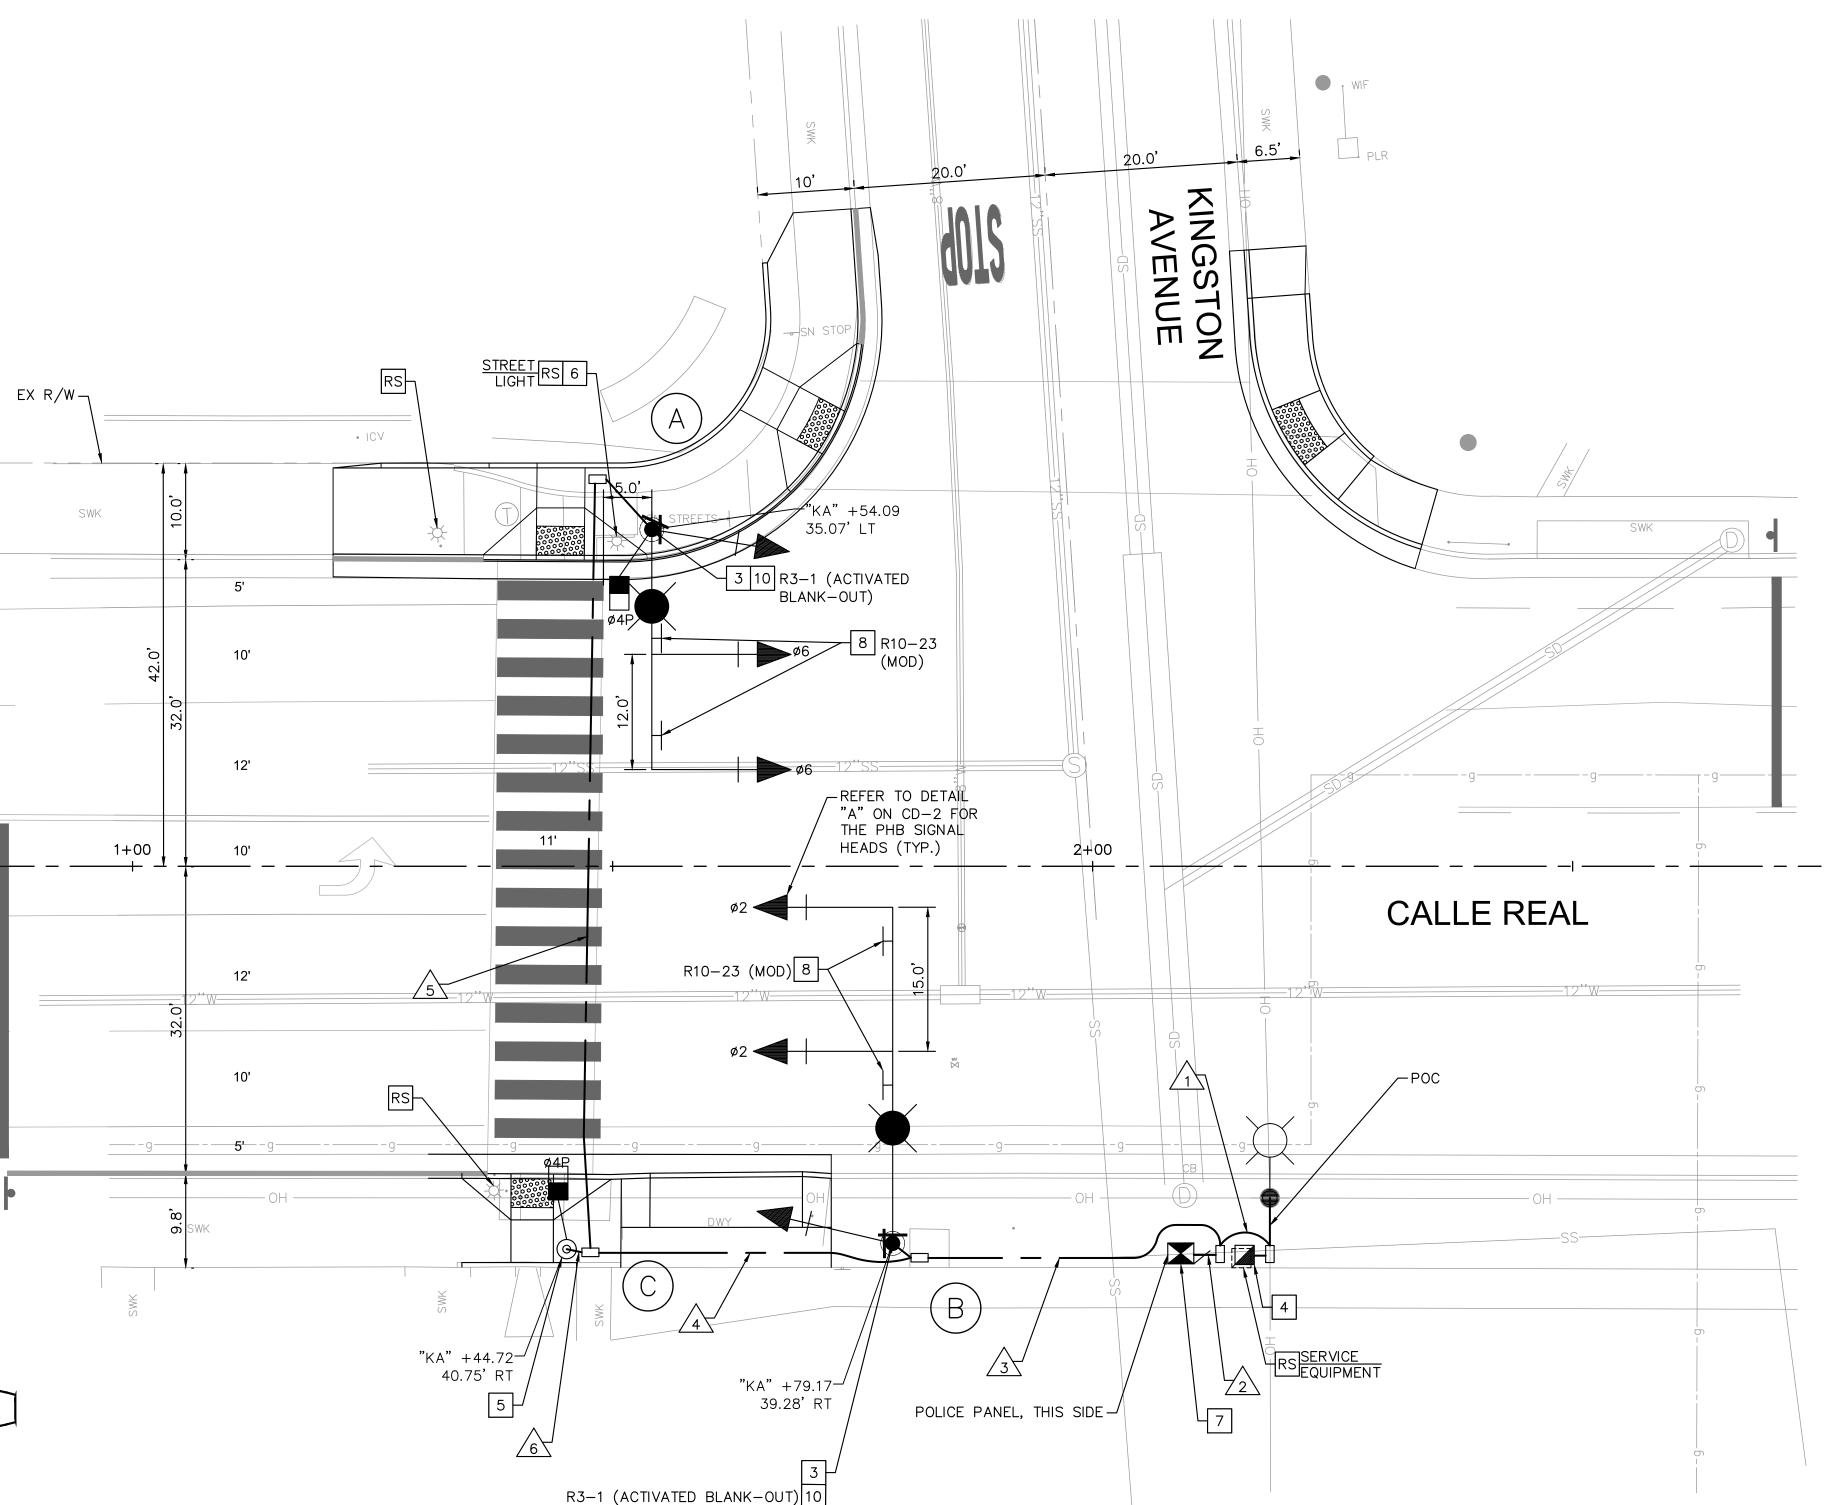
ENGINEERING DIVISION

9058 PBW. NO.

03-19 BID NO. SHT. DE

SHT. **07** OF **16**

OPERATION SEQUENCE FOR PEDESTRIAN HYBRID BEACON



GENERAL NOTES

- 1. EQUIPMENT IN THE FIELD SHALL OPERATE ACCORDING TO THE DESIGN SPECIFIED IN THE PLAN AND SPECIFICATIONS AND TO THE SATISFACTION OF THE ENGINEER-IN-THE-FIELD.
- 2. OBTAIN APPROVAL FOR EXACT EQUIPMENT LOCATION PRIOR TO FINAL PLACEMENT.
- 3. ALL MATERIALS AND EQUIPMENT SHALL BE NEW, FURNISHED AND INSTALLED BY THE CONTRACTOR UNLESS OTHERWISE NOTED ON THE PLANS.
- 4. ALL TRAFFIC SIGNAL POLES AND FERROUS MATERIALS SHALL BE GALVANIZED.
- 5. SEE SIGNING AND STRIPING PLANS FOR FOR TRAFFIC STRIPING, PAVEMENT MARKERS, PAVEMENT MARKINGS, AND TRAFFIC SIGNS, SHEET SS-2.
- 6. SEE DEMOLITION AND UTILITY PLANS FOR REMOVALS AND UTILITY IMPROVEMENTS.
- 7. ALL PULLBOXES SHALL BE NO. 5, UNLESS OTHERWISE NOTED ON PLAN.

LEGEND

SIGNAL HEAD (SEE DETAIL "A") LUMINAIRE PEDESTRIAN PUSH BUTTON --- CONDUIT

CONSTRUCTION NOTES

- 3 FURNISH AND INSTALL PEDESTRIAN HYBRID BEACON SYSTEM AND APPLICABLE SIGNS ON SIGNAL MAST ARM POLE. SEE SHEET CD-2 FOR DETAILS. INSTALL NEW POLE AND EQUIPMENT PER POLE SCHEDULE.
- 4 FURNISH AND INSTALL TYPE III BF SERVICE EQUIPMENT ENCLOSURE COMPLETE ON NEW FOUNDATION WITH POLICE PANEL ON NORTH SIDE, COMPLETE WITH 1-120V/240V METER SOCKET, 1-100A, 240V. 3P CIRCUIT BREAKER, 1-50A, 120V. 1P CIRCUIT BREAKER FOR TRAFFIC SIGNALS, AND 1-30A, 120V. 2P CIRCUIT BREAKER (UNMETERED) FOR HIGHWAY SAFETY LIGHTS.
- 5 FURNISH AND INSTALL PEDESTRIAN PUSH BUTTON ASSEMBLY POST PER CALTRANS STD PLAN ES-6A. INSTALL NEW POLE AND EQUIPMENT PER POLE SCHEDULE.
- 6 REMOVE AND RELOCATE BANNER TO POLE "A."
- 7 FURNISH AND INSTALL TYPE 332L CONTROLLER CABINET ON NEW FOUNDATION WITH FRONT AND REAR LIGHTS, DOUBLE FANS, DOCUMENT DRAWER, MODEL 2070 CONTROLLER, 750 PROGRAM, 2010ECL CONFLICT MONITOR, AND PERIPHERAL COMPONENTS PER MANUFACTURER'S RECOMMENDATION TO PROVIDE THE
- 8 FURNISH AND INSTALL MAST ARM SIGN AS SHOWN ON PLAN. SEE SHEET CD-1 AND CD-2 FOR DETAILS.
- 10 FURNISH AND INSTALL NEW SIGN(S) AS INDICATED ON SIGNAL POLE. SEE SHEET CD-1 AND CD-2 FOR DETAILS.
- RS REMOVE AND SALVAGE EQUIPMENT.

POLE AND EQUIPMENT SCHEDULE •

		STANDARI	D		VEH SIG	MTG	PED SIGNAL	PPB	LED	REMARKS	
No.	Туре	Height	SMA	LMA	MAST ARM	POLE	MTG	Ø	LUMINAIRE	REWARKS	
A	19-4-100	30'	25', F=12'	12' (c)	2-MAS	SV-1-T	SP-1-T	W	165W	6 8	
B	24-4-100	30'	35', F=15'	12' (c)	2-MAS	SV-1-T	-	-	165W	8	
C	1-A-7	7'	-	-	-	-	TP-1	E	-		


- ALL EQUIPMENT IS NEW UNLESS OTHERWISE NOTED
- (a) ALL NEW PEDESTRIAN HEADS SHALL INCLUDE LEDs WITH COUNTDOWN TYPE INDICATIONS.
- (b) ALL NEW PEDESTRIAN PUSH BUTTONS SHALL BE APS TYPE PUSH BUTTONS.
- (c) INSTALL STRAIGHT LUMINAIRE MAST ARM.

CONDUCTOR SCHEDULE ●							
AWG OR	CONDUCTOR RUN		RL	JN NI	JMBI	ER	
CABLE	CONDUCTOR RUN	Λ	2	<u>3</u>	4	<u>/</u> 5	6
C1	5 CSC	-	2	2	2	1	1
C2	9 CSC	-	4	4	3	2	1
#10	LUMINAIRE	2	2	2	2	2	-
#10	ACTIVATED BLANKOUT SIGN	2	2	2	2	2	-
#6	SERVICE	2	2	-	-	-	-
#8	GROUNDING	1	1	1	1	1	-
CONDUIT SIZE		3"	2-3"	3"	3"	3"	2"


ALL EQUIPMENT IS NEW UNLESS OTHERWISE NOTED

SIGN LEGEND



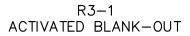



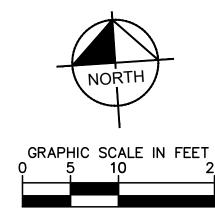

GOLETA

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DEPARTMENT

ENGINEERING DIVISION

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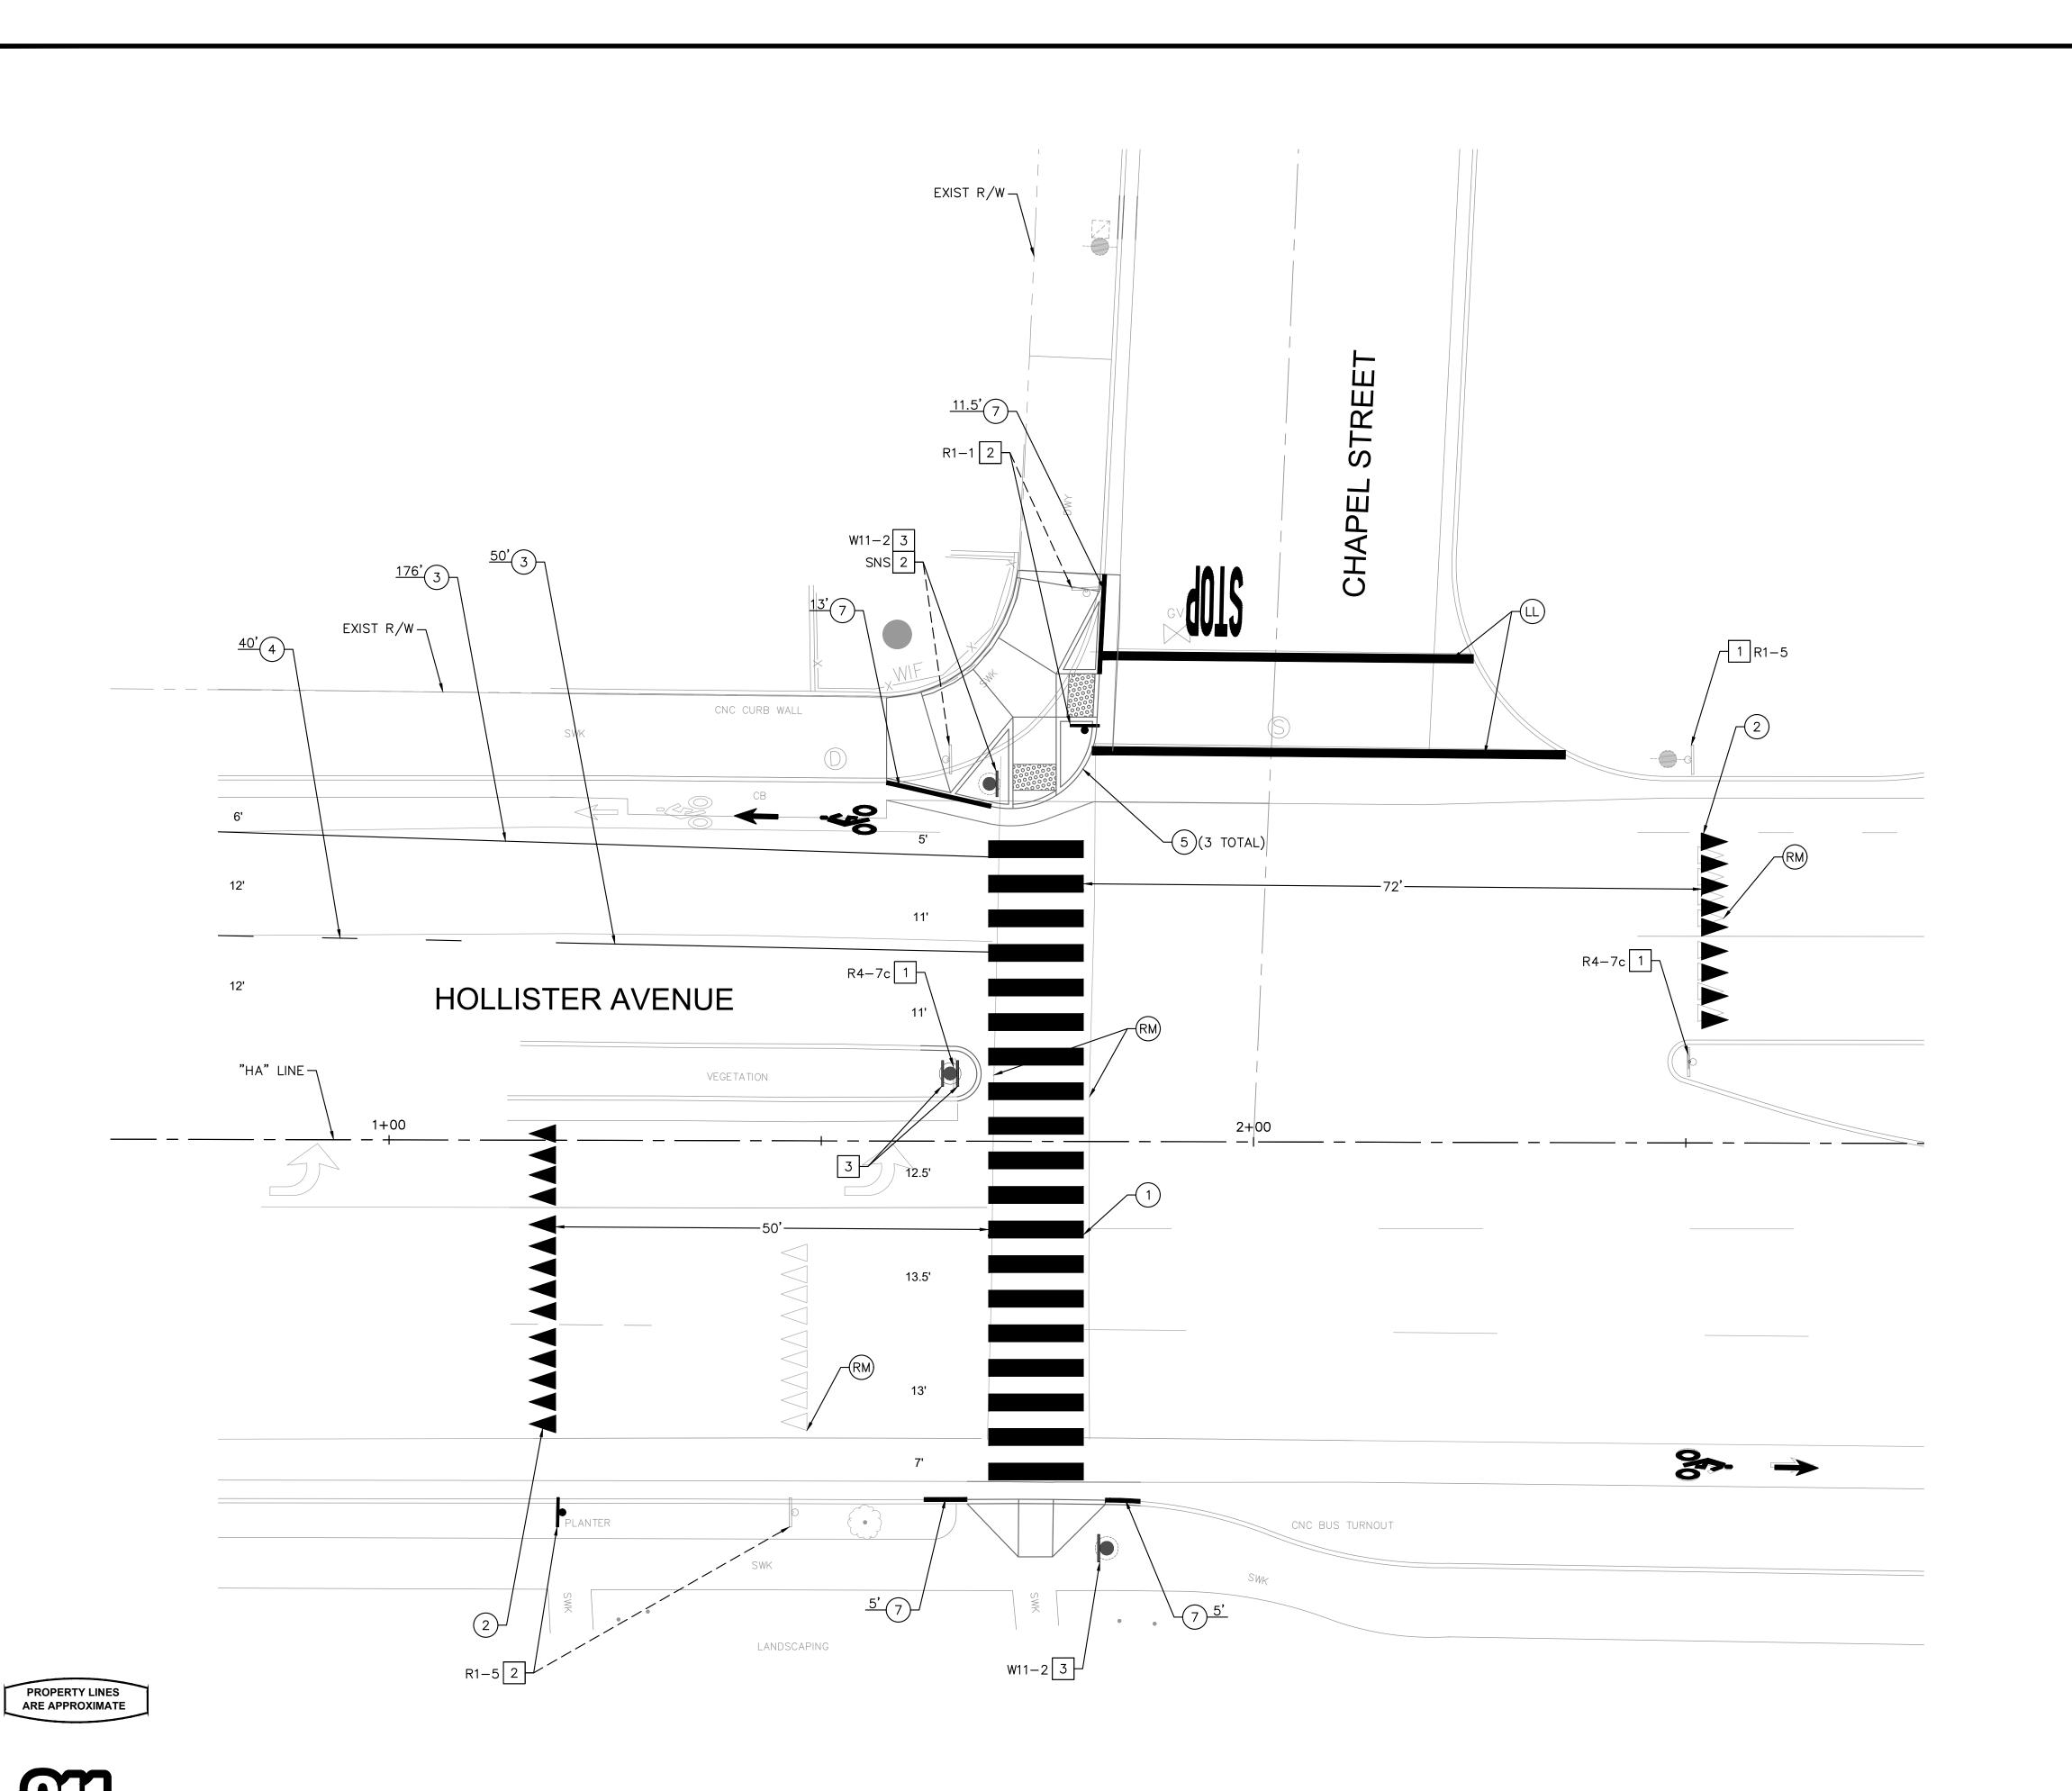
9058

E-2

03-19



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GENERAL NOTES

- 1. ALL ROADSIDE SIGNING, PAVEMENT DELINEATION, MARKINGS, AND MARKERS SHALL BE IN CONFORMANCE WITH THE LATEST EDITION OF CALTRANS STANDARDS PLANS (CSP) AND SPECIFICATIONS, AND THE LATEST EDITION OF THE CALIFORNIA MANUAL ON UNIFORM TRAFFIC CONTROL DEVICES (CA-MUTCD).
- 2. ALL EXISTING SIGN NOT SHOWN FOR REMOVAL, RELOCATION, OR RESETTING SHALL BE PROTECTED IN PLACE.
- 3. EXACT LOCATIONS OF ALL NEW SIGNS SHALL BE APPROVED BY THE ENGINEER PRIOR TO INSTALLATION.
- 4. CONTRACTOR SHALL REMOVE ALL CONFLICTING TRAFFIC STRIPES AND PAVEMENT
- 5. TRAFFIC STRIPES AND PAVEMENT MARKINGS SHALL BE THERMOPLASTIC, UNLESS OTHERWISE NOTED.
- 6. TRAFFIC STRIPES AND MARKINGS SHALL BE MARKED/CAT-TRACKED IN THE FIELD BY THE CONTRACTOR AND APPROVED BY THE ENGINEER PRIOR TO INSTALLATION.

SIGN LEGEND



R1-5

SIGN CONSTRUCTION NOTES

- 1 PROTECT EXISTING SIGN IN PLACE.
- 2 REMOVE AND RELOCATE EXISTING SIGN AND POST, COMPLETE.
- 3 FURNISH AND INSTALL SIGN ON TRAFFIC POLE. SEE SHEET CD-1 AND CD-2 FOR DETAILS.

STRIPING CONSTRUCTION NOTES

- 1 FURNISH AND INSTALL THERMOPLASTIC WHITE "CONTINENTAL" CROSSWALK MARKINGS PER CALTRANS STD PLANS A24F (12'L x 2'W x 3' SPACING).
- 2 FURNISH AND INSTALL YIELD LINE PER CALTRANS STD. PLAN A24E.
- 3 FURNISH AND INSTALL 6" WHITE LINE, DETAIL 39 PER CALTRANS STD. PLAN A20D.
- 4 FURNISH AND INSTALL WHITE LINE, DETAIL 12 PER CALTRANS STD. PLAN A20D.
- 5 FURNISH AND INSTALL WHITE REFLECTIVE PAVEMENT MARKERS 6" OFF FACE OF CURB ON ALL CURB EXTENSIONS.
- (7) FURNISH AND INSTALL RED CURB (LENGTH PER PLAN).
- (LL) FURNISH AND INSTALL PAVEMENT MARKING, WHITE LIMIT LINE, 1' WIDE, PER CALTRANS STD PLAN A24E.
- (RM) REMOVE PAVEMENT MARKINGS, PAVEMENT STRIPES, AND MARKERS.


PAVEMENT MARKING LEGEND

FURNISH AND INSTALL PROPOSED PAVEMENT MARKINGS:

WORD "STOP" PER CSP A24D

BIKE LANE MARKING PER CSP A24C AND CSP A24A



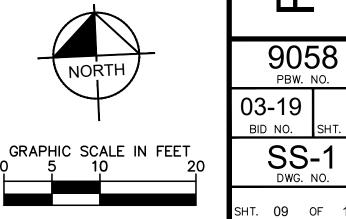



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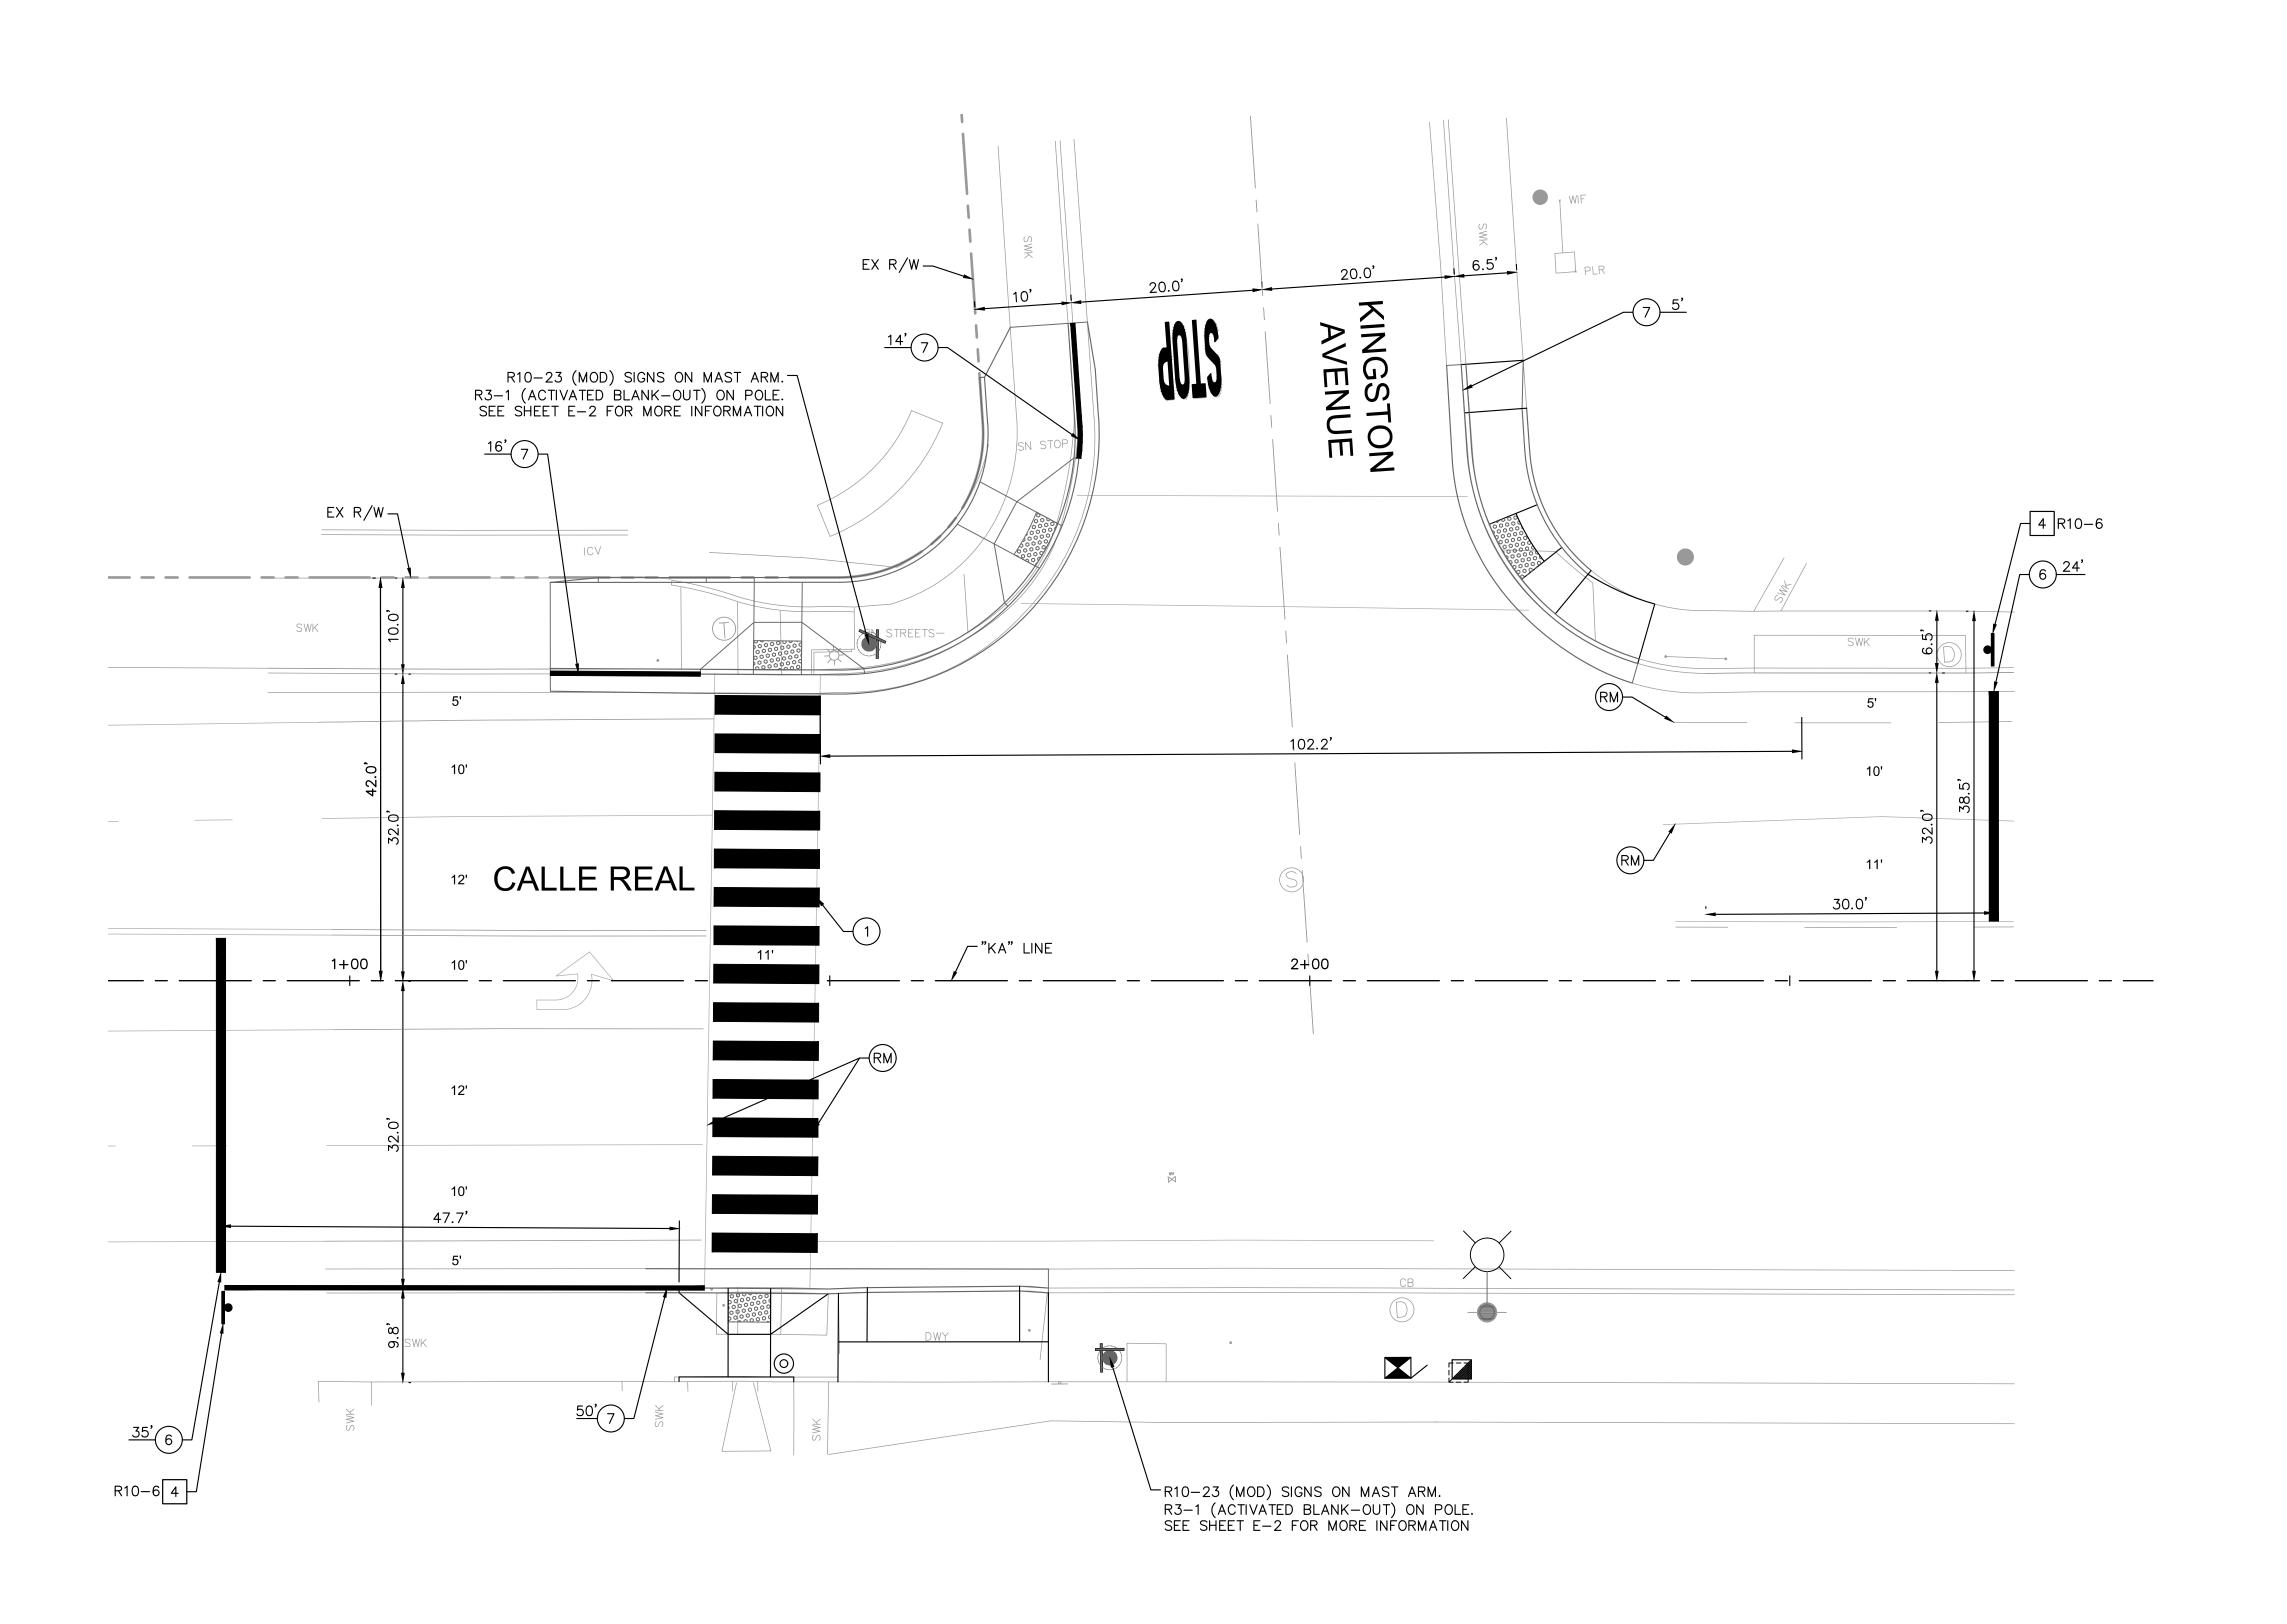
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9058 PBW. NO. 03-19

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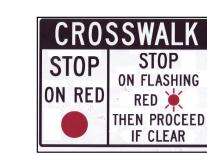




- 1. ALL ROADSIDE SIGNING, PAVEMENT DELINEATION, MARKINGS, AND MARKERS SHALL BE IN CONFORMANCE WITH THE LATEST EDITION OF CALTRANS STANDARDS PLANS (CSP) AND SPECIFICATIONS, AND THE LATEST EDITION OF THE CALIFORNIA MANUAL ON UNIFORM TRAFFIC CONTROL DEVICES (CA-MUTCD).
- 2. ALL EXISTING SIGN NOT SHOWN FOR REMOVAL, RELOCATION, OR RESETTING SHALL BE PROTECTED IN PLACE.
- 3. FEDERAL SIGN CODES ARE SHOWN UNLESS DESIGNATED BY (CA), WHICH INDICATES A CALIFORNIA SIGN CODE. ADD TWO (2) RED OR ORANGE FLAGS (CLOTH OR RETROREFLECTIVE SHEETING) 16 INCH SQUARE OR LARGER ABOVE NEW R10-23(MOD) SIGNS, WITH THE FLAGS ORIENTED AT 45 DEGREES TO THE VERTICAL. FLAGS SHALL BE MAINTAINED FOR 90 DAYS AFTER WHICH THEY CAN BE REMOVED.
- 4. EXACT LOCATIONS OF ALL NEW SIGNS SHALL BE APPROVED BY THE ENGINEER PRIOR TO INSTALLATION.
- 5. CONTRACTOR SHALL REMOVE ALL CONFLICTING TRAFFIC STRIPES AND PAVEMENT
- 6. TRAFFIC STRIPES AND PAVEMENT MARKINGS SHALL BE THERMOPLASTIC, UNLESS OTHERWISE NOTED.
- 7. TRAFFIC STRIPES AND MARKINGS SHALL BE MARKED/CAT-TRACKED IN THE FIELD BY THE CONTRACTOR AND APPROVED BY THE ENGINEER PRIOR TO INSTALLATION.

SIGN LEGEND





R10-6

R10-23 (MOD)

SIGN CONSTRUCTION NOTES

4 FURNISH AMD INSTALL SIGN AND POST ON TELESPAR SQUARE TUBE.


STRIPING CONSTRUCTION NOTES


- 1) FURNISH AND INSTALL THERMOPLASTIC WHITE "CONTINENTAL" CROSSWALK MARKINGS PER CALTRANS STD PLANS A24F (12'L x 2'W x 3' SPACING).
- 6 FURNISH AND INSTALL THERMOPLASTIC 12" WIDE LIMIT LINE PER CALTRANS STD. PLAN A24F.
- 7 FURNISH AND INSTALL RED CURB (LENGTH PER PLAN).
- (RM) REMOVE PAVEMENT MARKINGS, PAVEMENT STRIPES, AND MARKERS.

PAVEMENT MARKING LEGEND

FURNISH AND INSTALL PROPOSED PAVEMENT MARKINGS:

WORD "STOP" PER CSP A24D

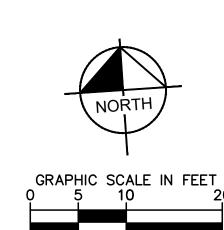

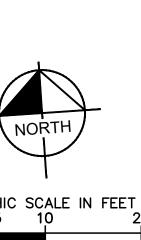







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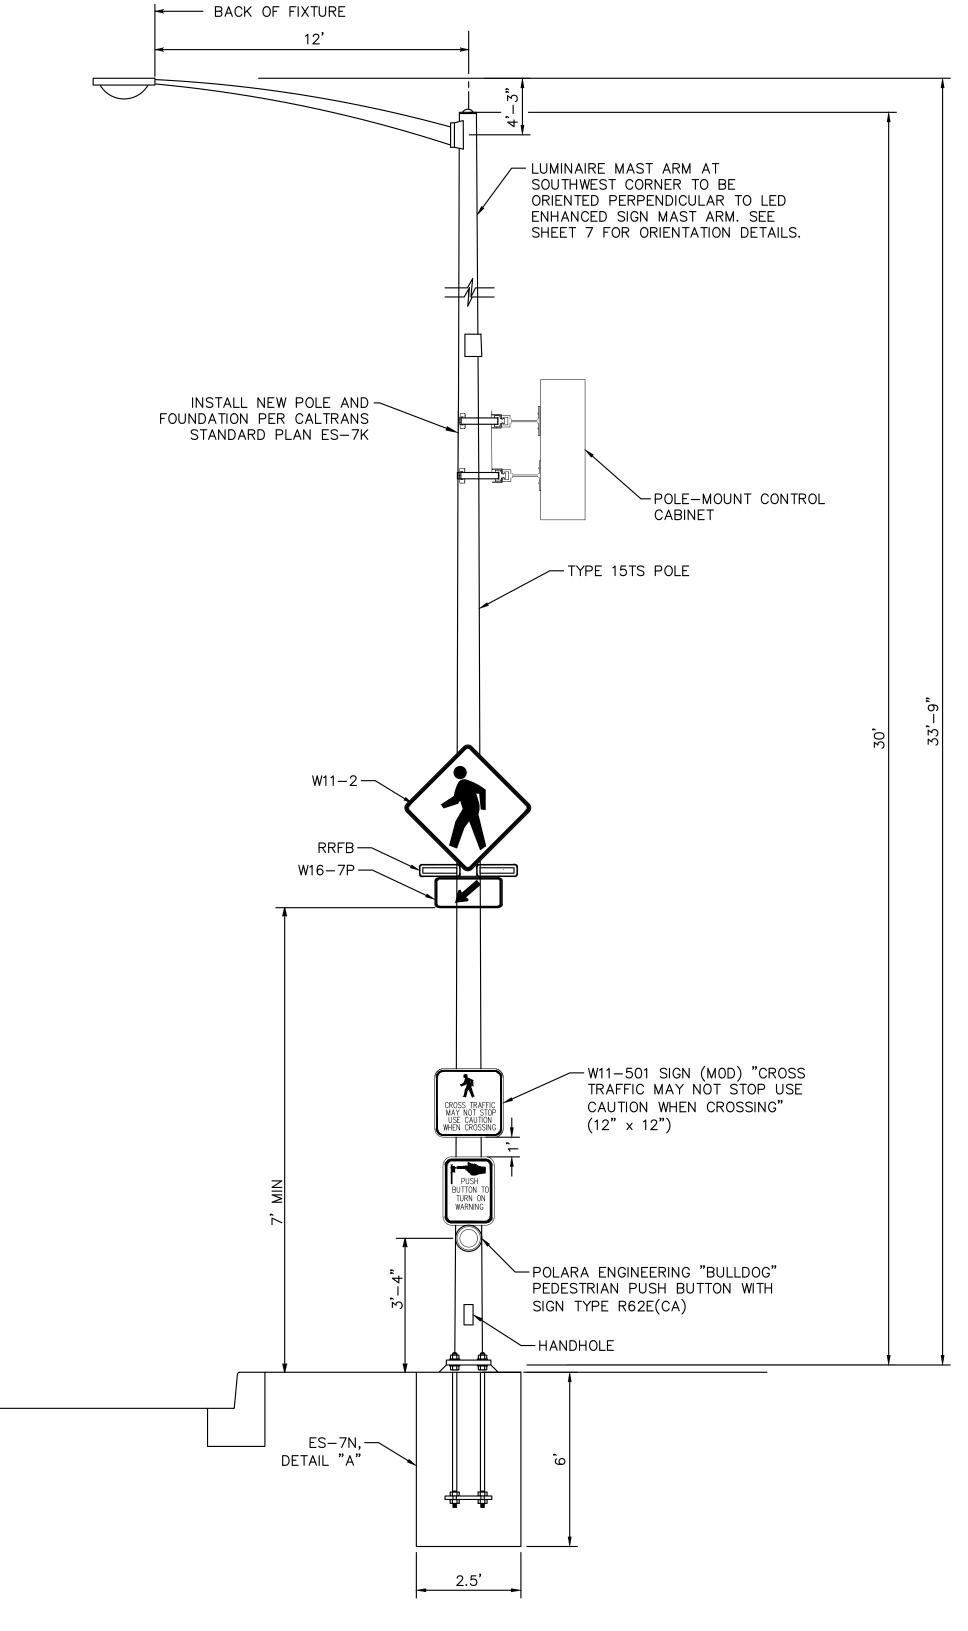
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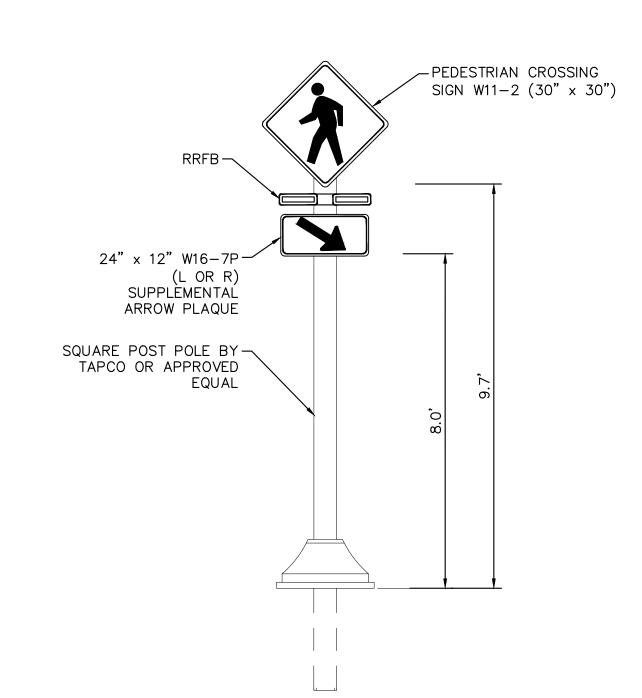
9058

03-19 BID NO. SS-2



RRFB ASSEMBLY ON TYPE 15 POLE

NOT TO SCALE




RECTANGULAR RAPID FLASHING BEACON (RRFB) ON SQUARE POST
NOT TO SCALE







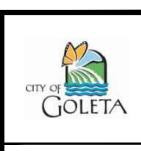

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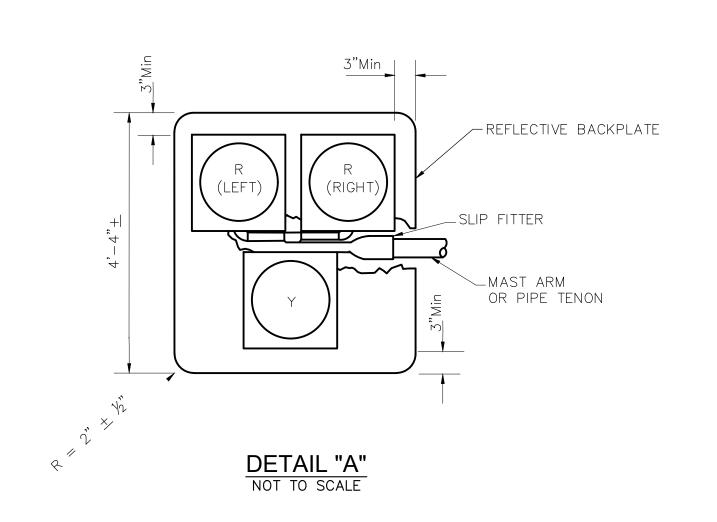
PUBLIC WORKS DEPARTMENT ENGINEERING DIVISION


CONSTRUCTION

9058 PBW. NO. 03-19
BID NO. SHT. DE

DWG. NO.

SHT. 11 OF 16



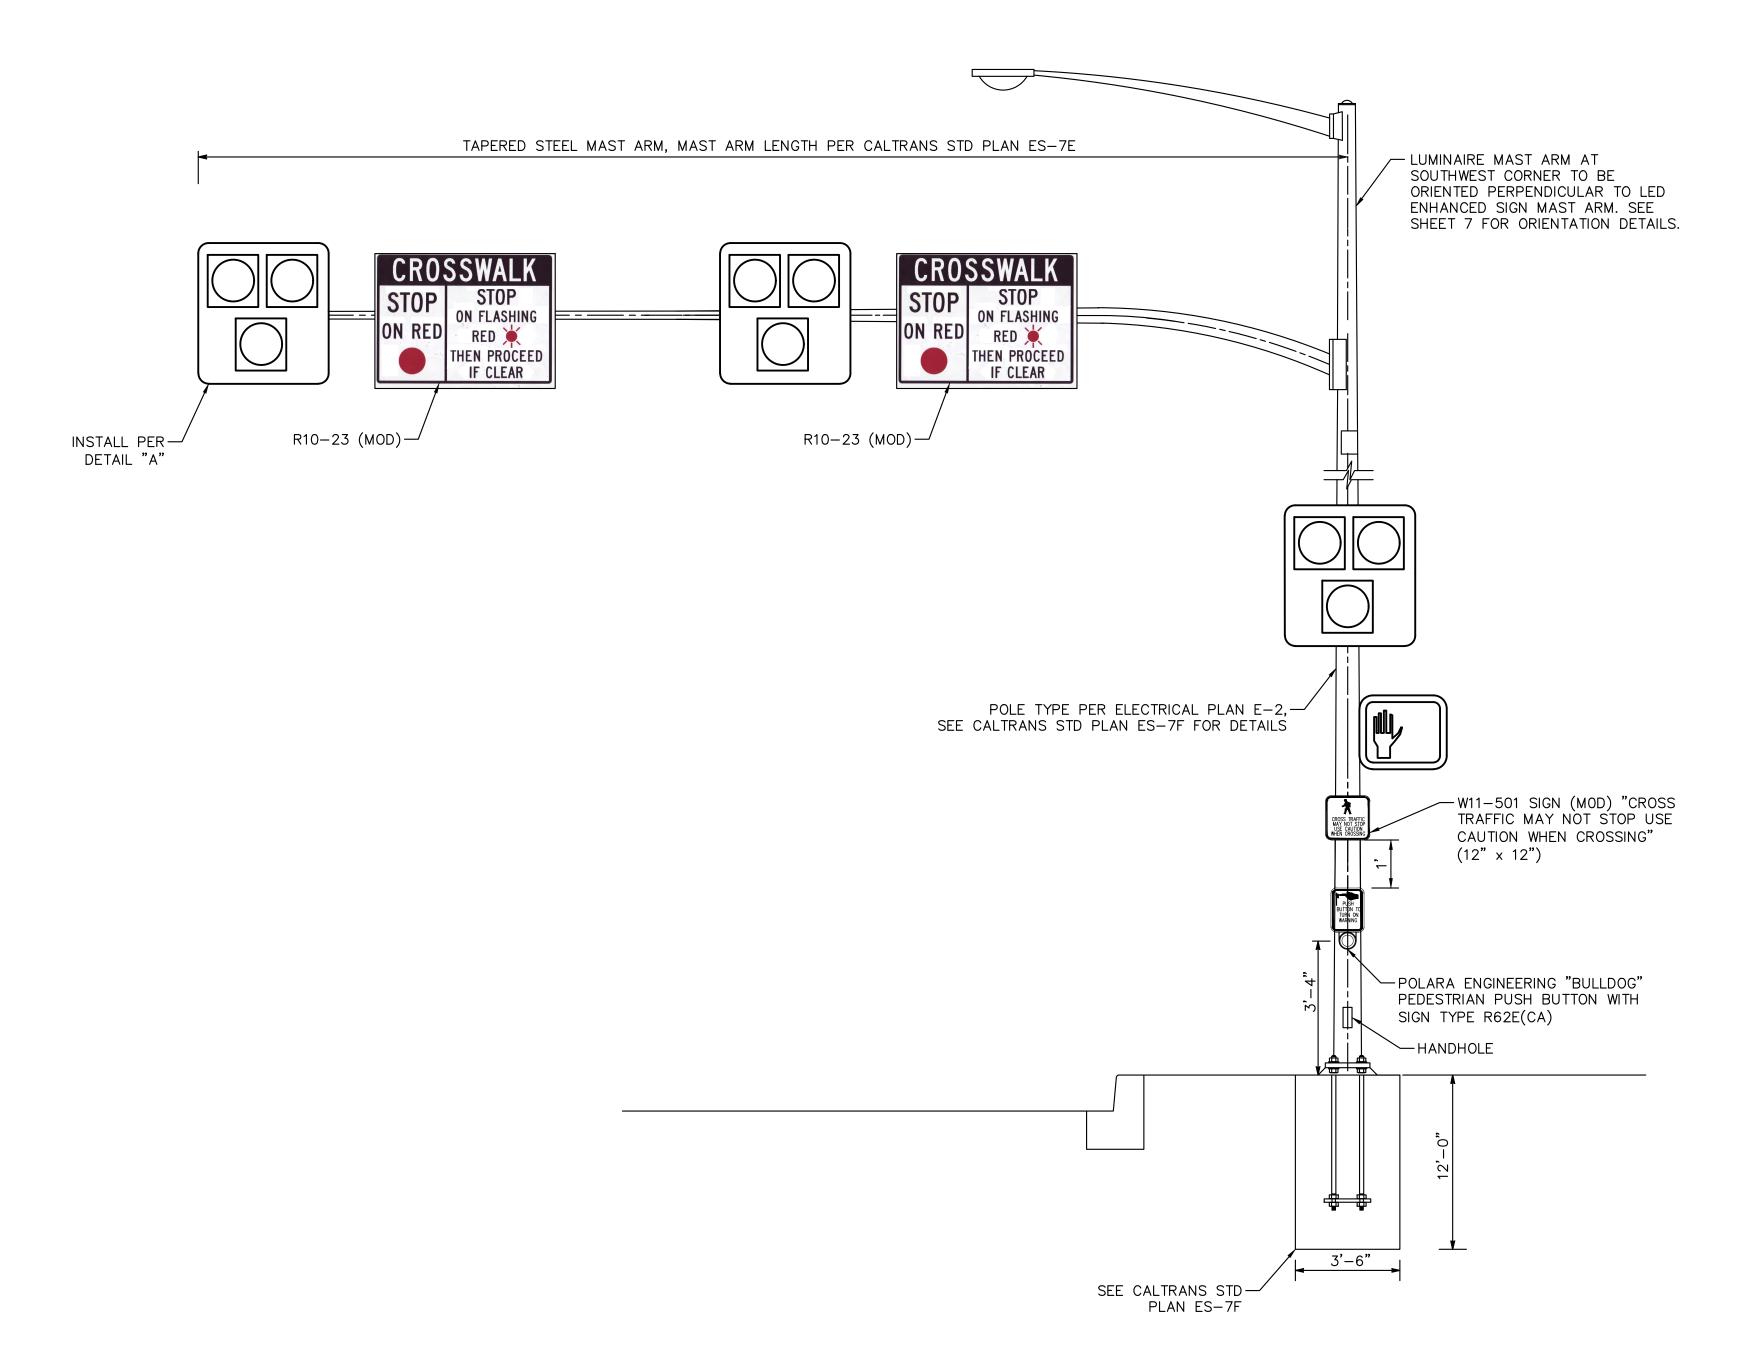

PHB ASSEMBLY ON MAST ARM POLE
NOT TO SCALE








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9058 PBW. NO. 03-19 BID NO. SHT. DE CD-2 DWG. NO.

SHT. 12 OF 16



NORTHWEST QUADRANT

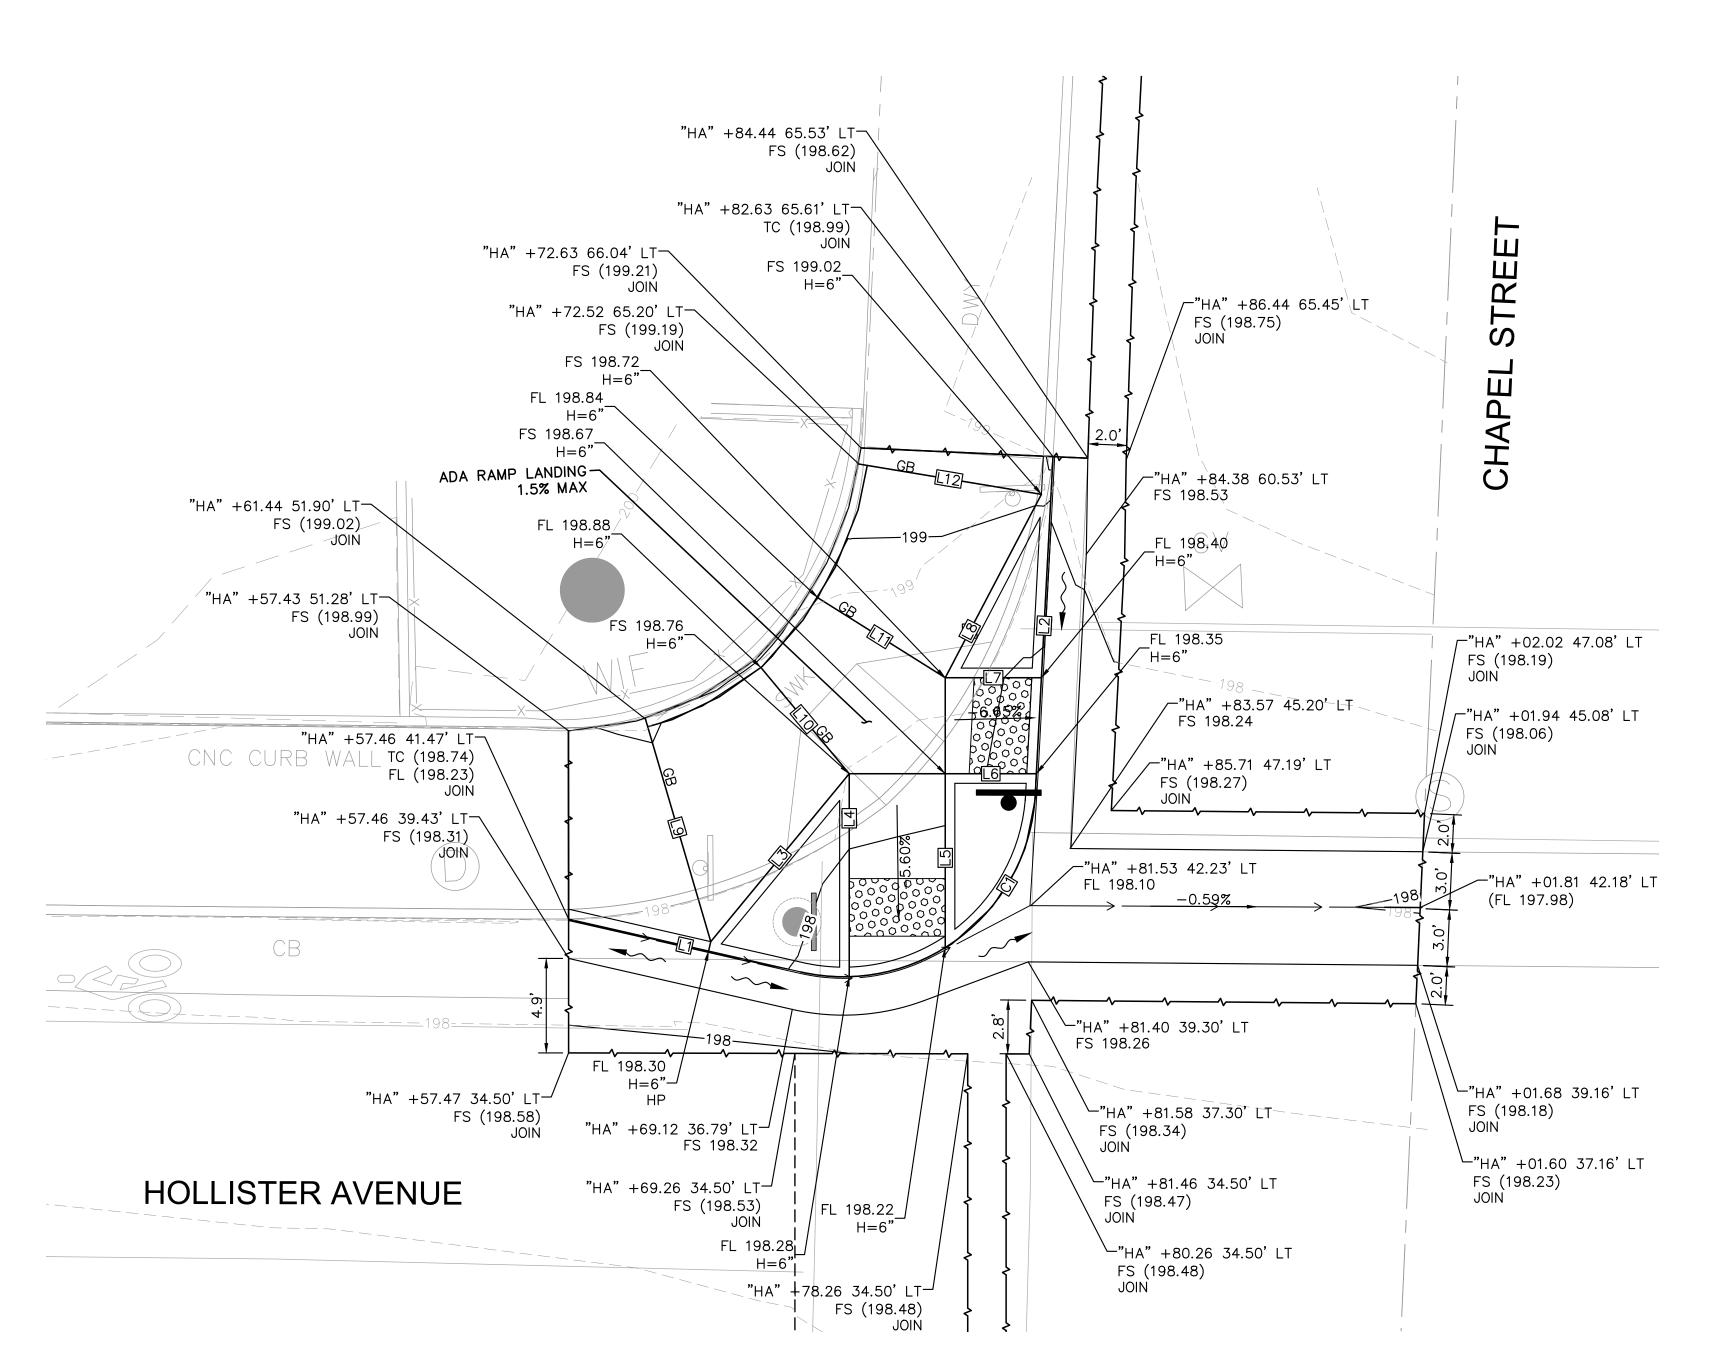LINE AND CURVE TABLE NO. | LENGTH | DELTA OR BRG | RADIUS 10.00' C1 | 17.43' | Δ =99° 51' 00" C2 2.51' Δ =2° 43' 14" 52.79' L1 | 12.40' | N 74°37'12" W L2 | 17.64' N 5°31'48" E L3 | 11.33' N 42°03'23" E L4 | 10.57' S 2°31'42" W L5 | 9.06' S 2°31'42" W L6 | 4.74' | N 87°28'18" W L7 5.01' N 87°28'18" W L8 | 10.78' S 30°11'36" W L9 | 12.11' N 13°48'59" W L10 7.19 N 37°13'05" W L11 7.82' N 55°21'41" W L12 | 9.64' | N 78°03'01" W L13 | 8.59' | N 47°43'05" E L14 7.54' S 86°45'07" E

GENERAL NOTES

- 1. VERIFY THE EXISTENCE AND HORIZONTAL/VERTICAL LOCATION OF ALL UTILITIES WITHIN THE PROJECT AREA THAT MAY CONFLICT WITH THE PROPOSED CONSTRUCTION. VERIFY THAT ANY UTILITIES SHOWN TO BE RELOCATED BY OTHERS HAVE BEEN RELOCATED AND ARE NO LONGER IN CONFLICT. IMMEDIATELY NOTIFY THE ENGINEER OF ANY REMAINING UTILITY CONFLICTS PRIOR TO THE START OF ANY CONSTRUCTION WORK.
- 2. ALL GUTTER SLOPES AT PEDESTRIAN RAMPS SHALL NOT EXCEED 4.5%, SEE CONSTRUCTION DETAIL PLANS FOR MORE INFORMATION.
- 3. ALL SIDEWALK SHALL MATCH EXISTING SIDEWALK PATTERN, COLOR, AND FINISH.
- 4. FOR SIGN REMOVALS OR RELOCATIONS REFER TO SIGNING AND STRIPING PLAN, SHEET SS-1.
- 5. SEE ELECTRICAL PLANS FOR REMOVALS, RELOCATIONS, AND/OR ADJUSTMENTS OF TRAFFIC SIGNAL POLES AND RELATED IMPROVEMENTS, SHEETS E-1.
- 6. CONTRACTOR SHALL MAINTAIN EXISTING ELECTRICAL CIRCUITS FOR EQUIPMENT NOT REMOVED DURING DEMOLITION.
- 7. EXISTING WATER METERS AND FIRE HYDRANTS SHALL REMAIN IN OPERATION UNTIL NEW SYSTEMS ARE OPERATIONAL. SEE UTILITY PLANS FOR IMPROVEMENTS.
- 8. ALL LINE AND CURVE DATA REFER TO TOP OF CURB.

LEGEND



DETECTABLE WARNING SURFACE


RRFB/SEE ELECTRICAL PLANS

SAWCUT WITH FULL DEPTH REMOVALS

LIMIT OF IMPROVEMENTS




→ — FLOWLINE

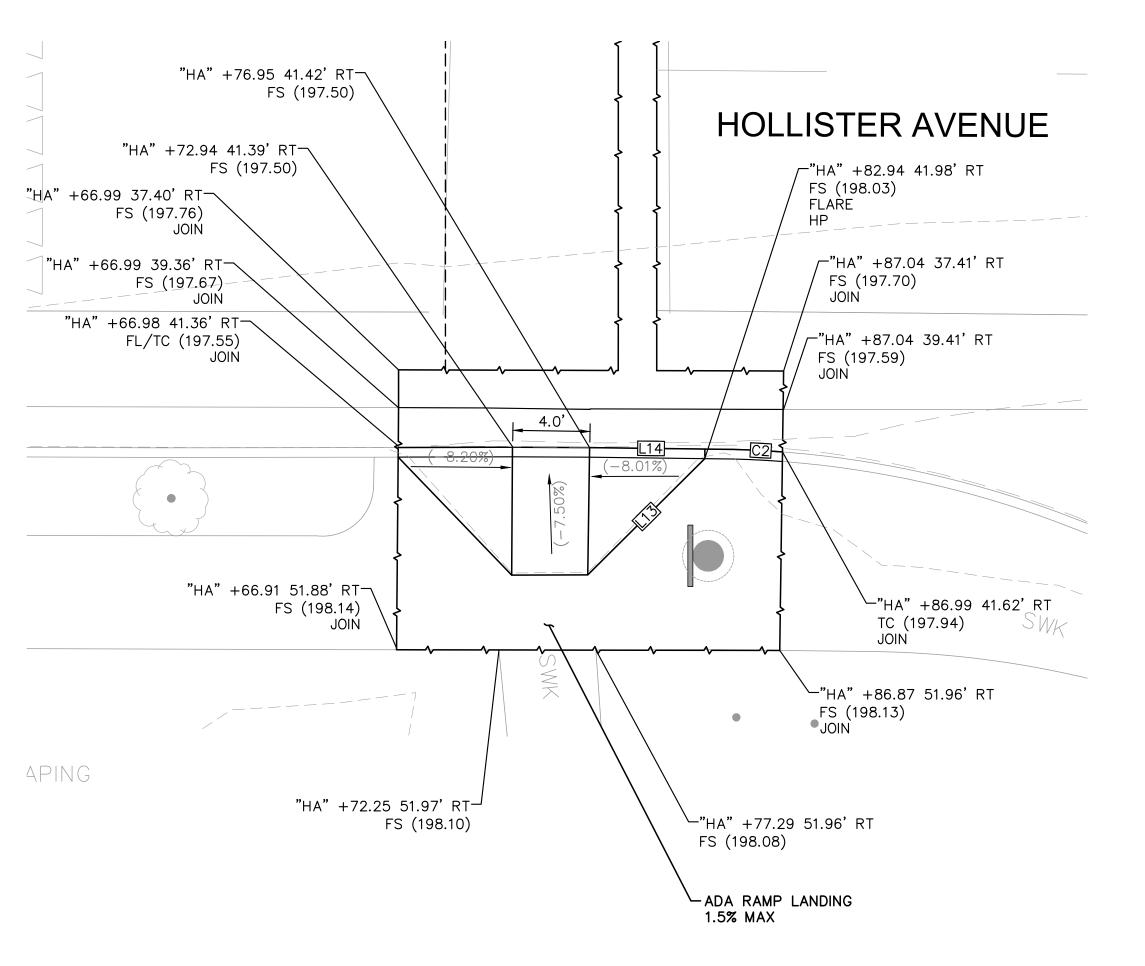





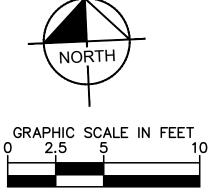

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<u>Z</u>0 CHAPEL GOLETA OF TION DE CONSTRUC


9058 PBW. NO. 03-19 BID NO. SHT. DE

CD-3

DWG. NO.

SHT. 13 OF 16



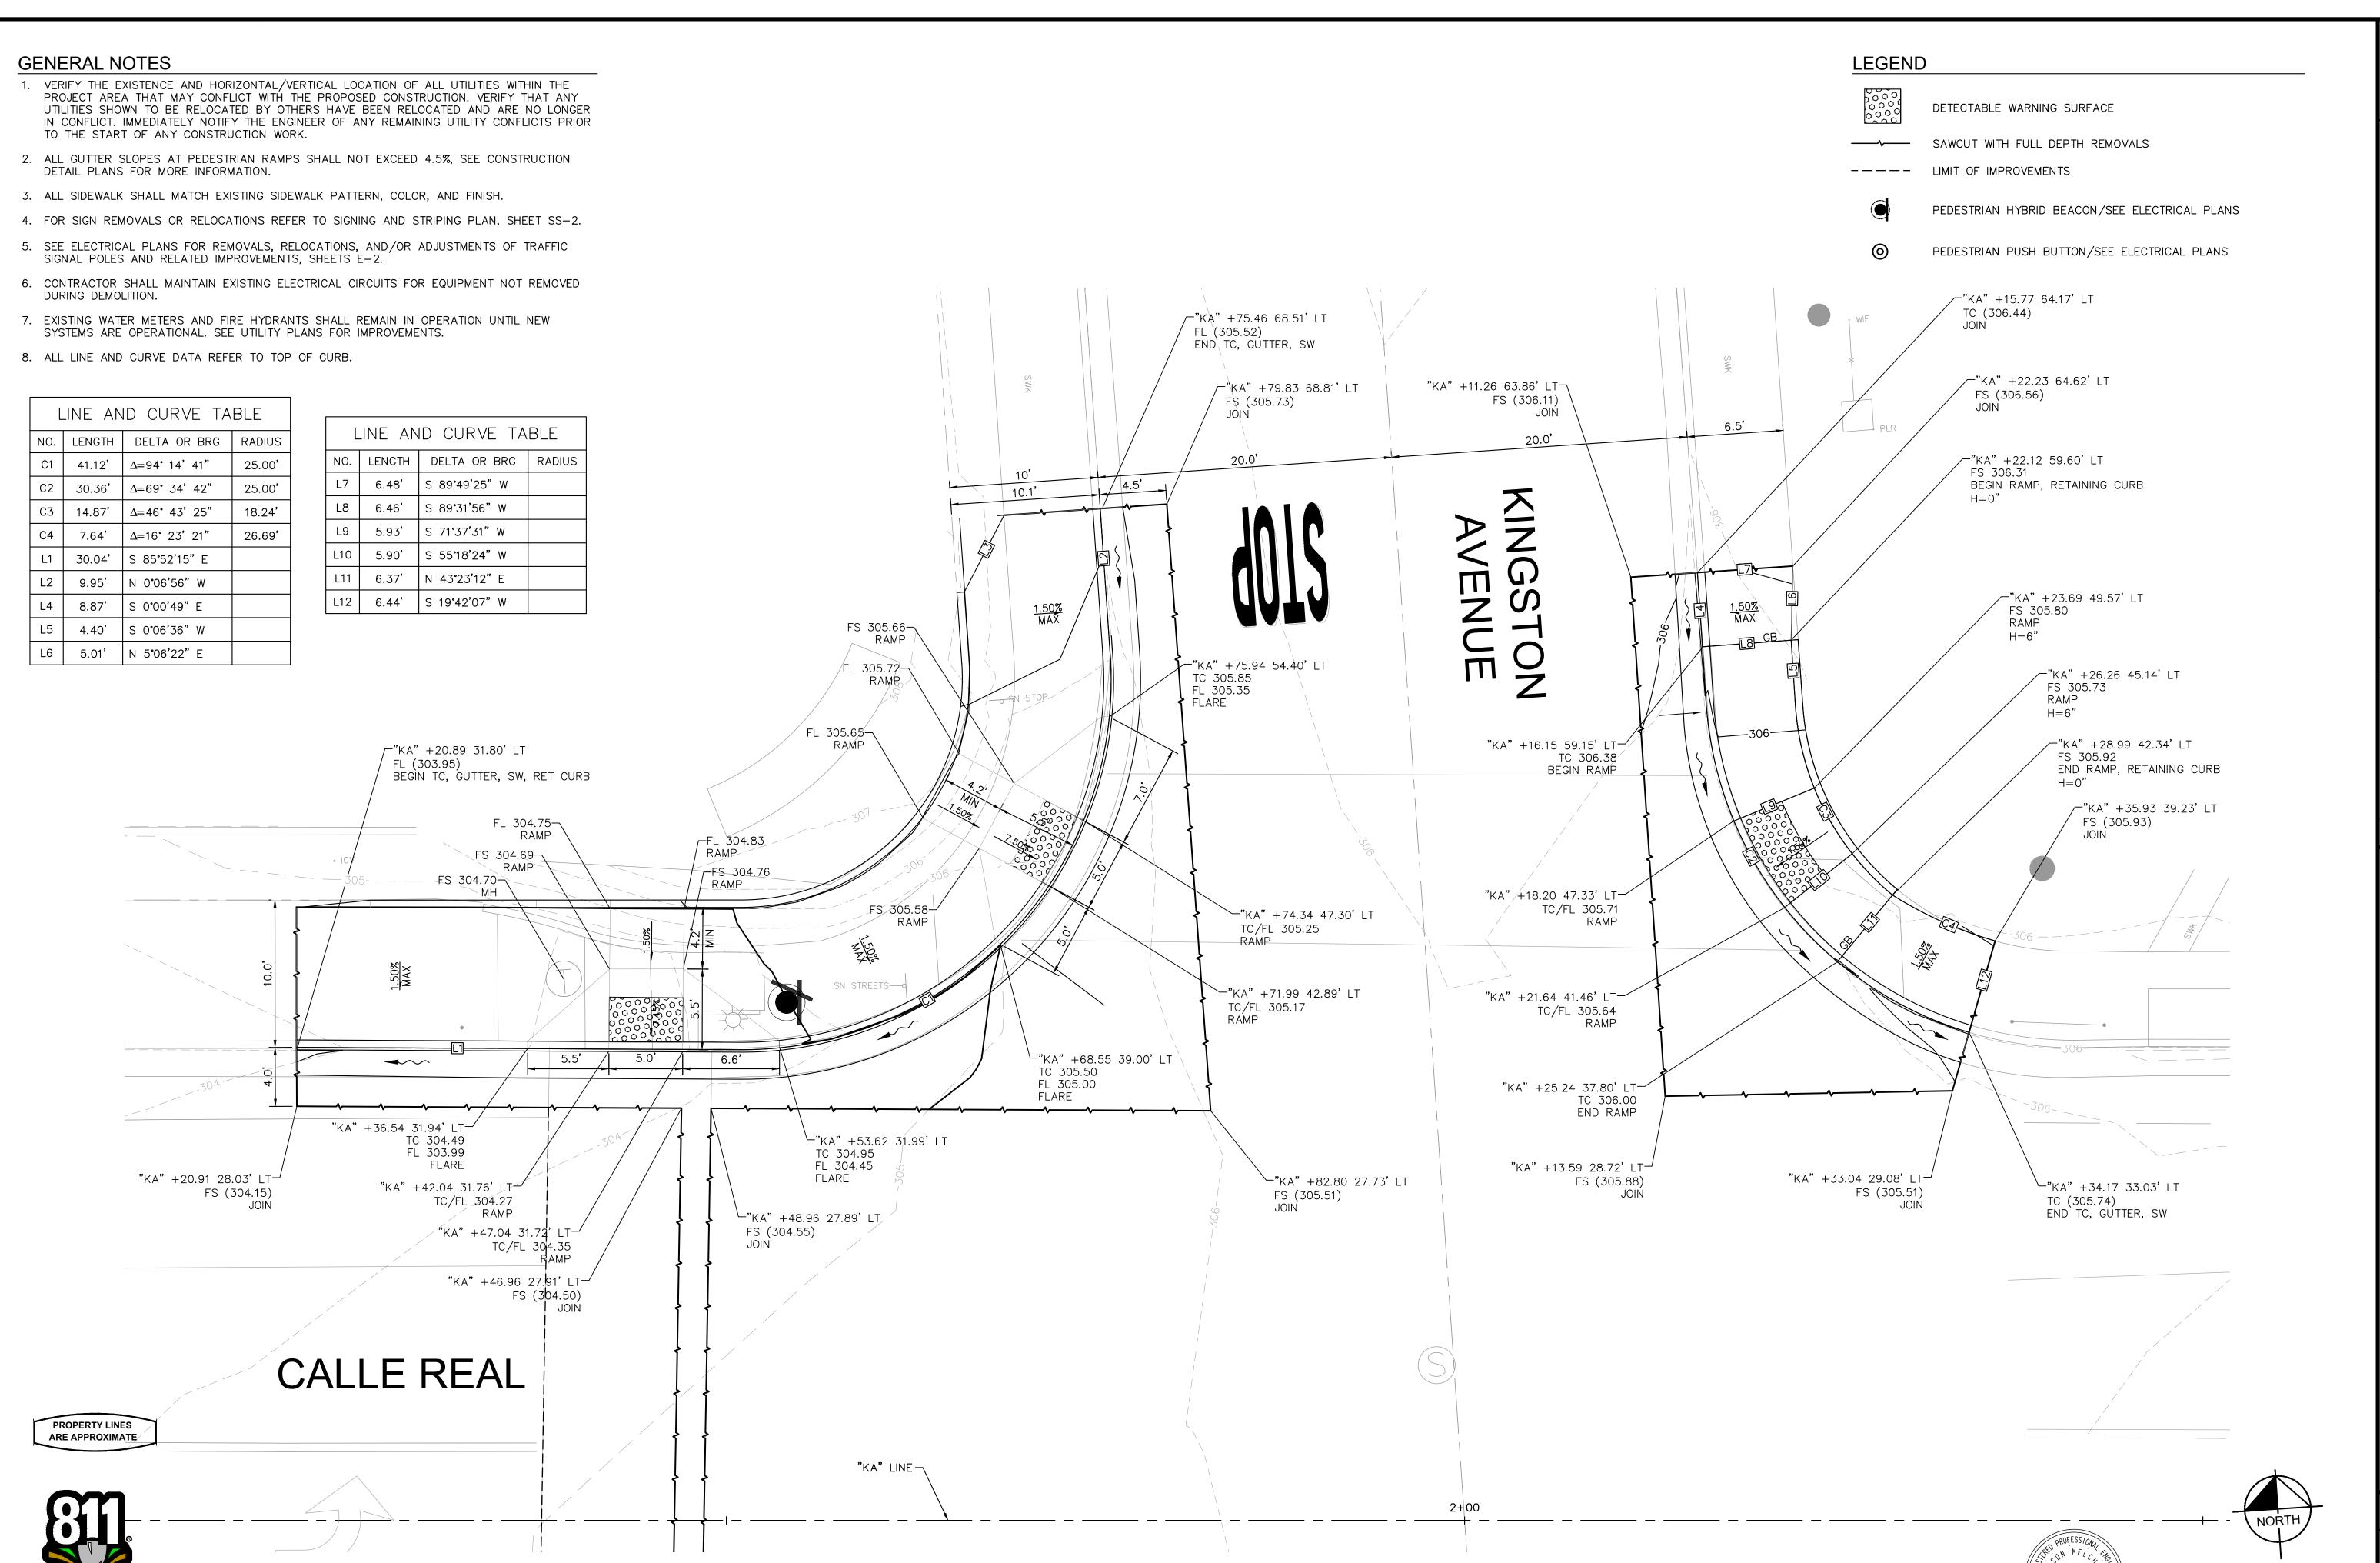

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ENGINEERING DIVISION

DATE

DATE APPROVED DESIGN DESIGN CHECKED TO %

CITY OF GOLETA
CHAPEL, PHB KINGSTON
UCTION DETAIL - KINGSTON AVENUE

9058 PBW. NO. 3-19

9058 PBW. NO. 03-19 BID NO. SHT. DES. CD-4 DWG. NO.

SHT. 14 OF 1

1. SEE CONSTRUCTION DETAIL SHEET CD-4 FOR ADDITIONAL INFORMATION.

	LINE AND	CURV	E TABI	LE
NO.	DELTA OR BRG	RADIUS	LENGTH	REMARKS
L13	N 85°45'38" W		14.02'	
L14	N 86°08'45" W		5.00'	

LEGEND



DETECTABLE WARNING SURFACE


SAWCUT WITH FULL DEPTH REMOVALS

---- LIMIT OF IMPROVEMENTS

PEDESTRIAN HYBRID BEACON/SEE ELECTRICAL PLANS

0


PEDESTRIAN PUSH BUTTON/SEE ELECTRICAL PLANS

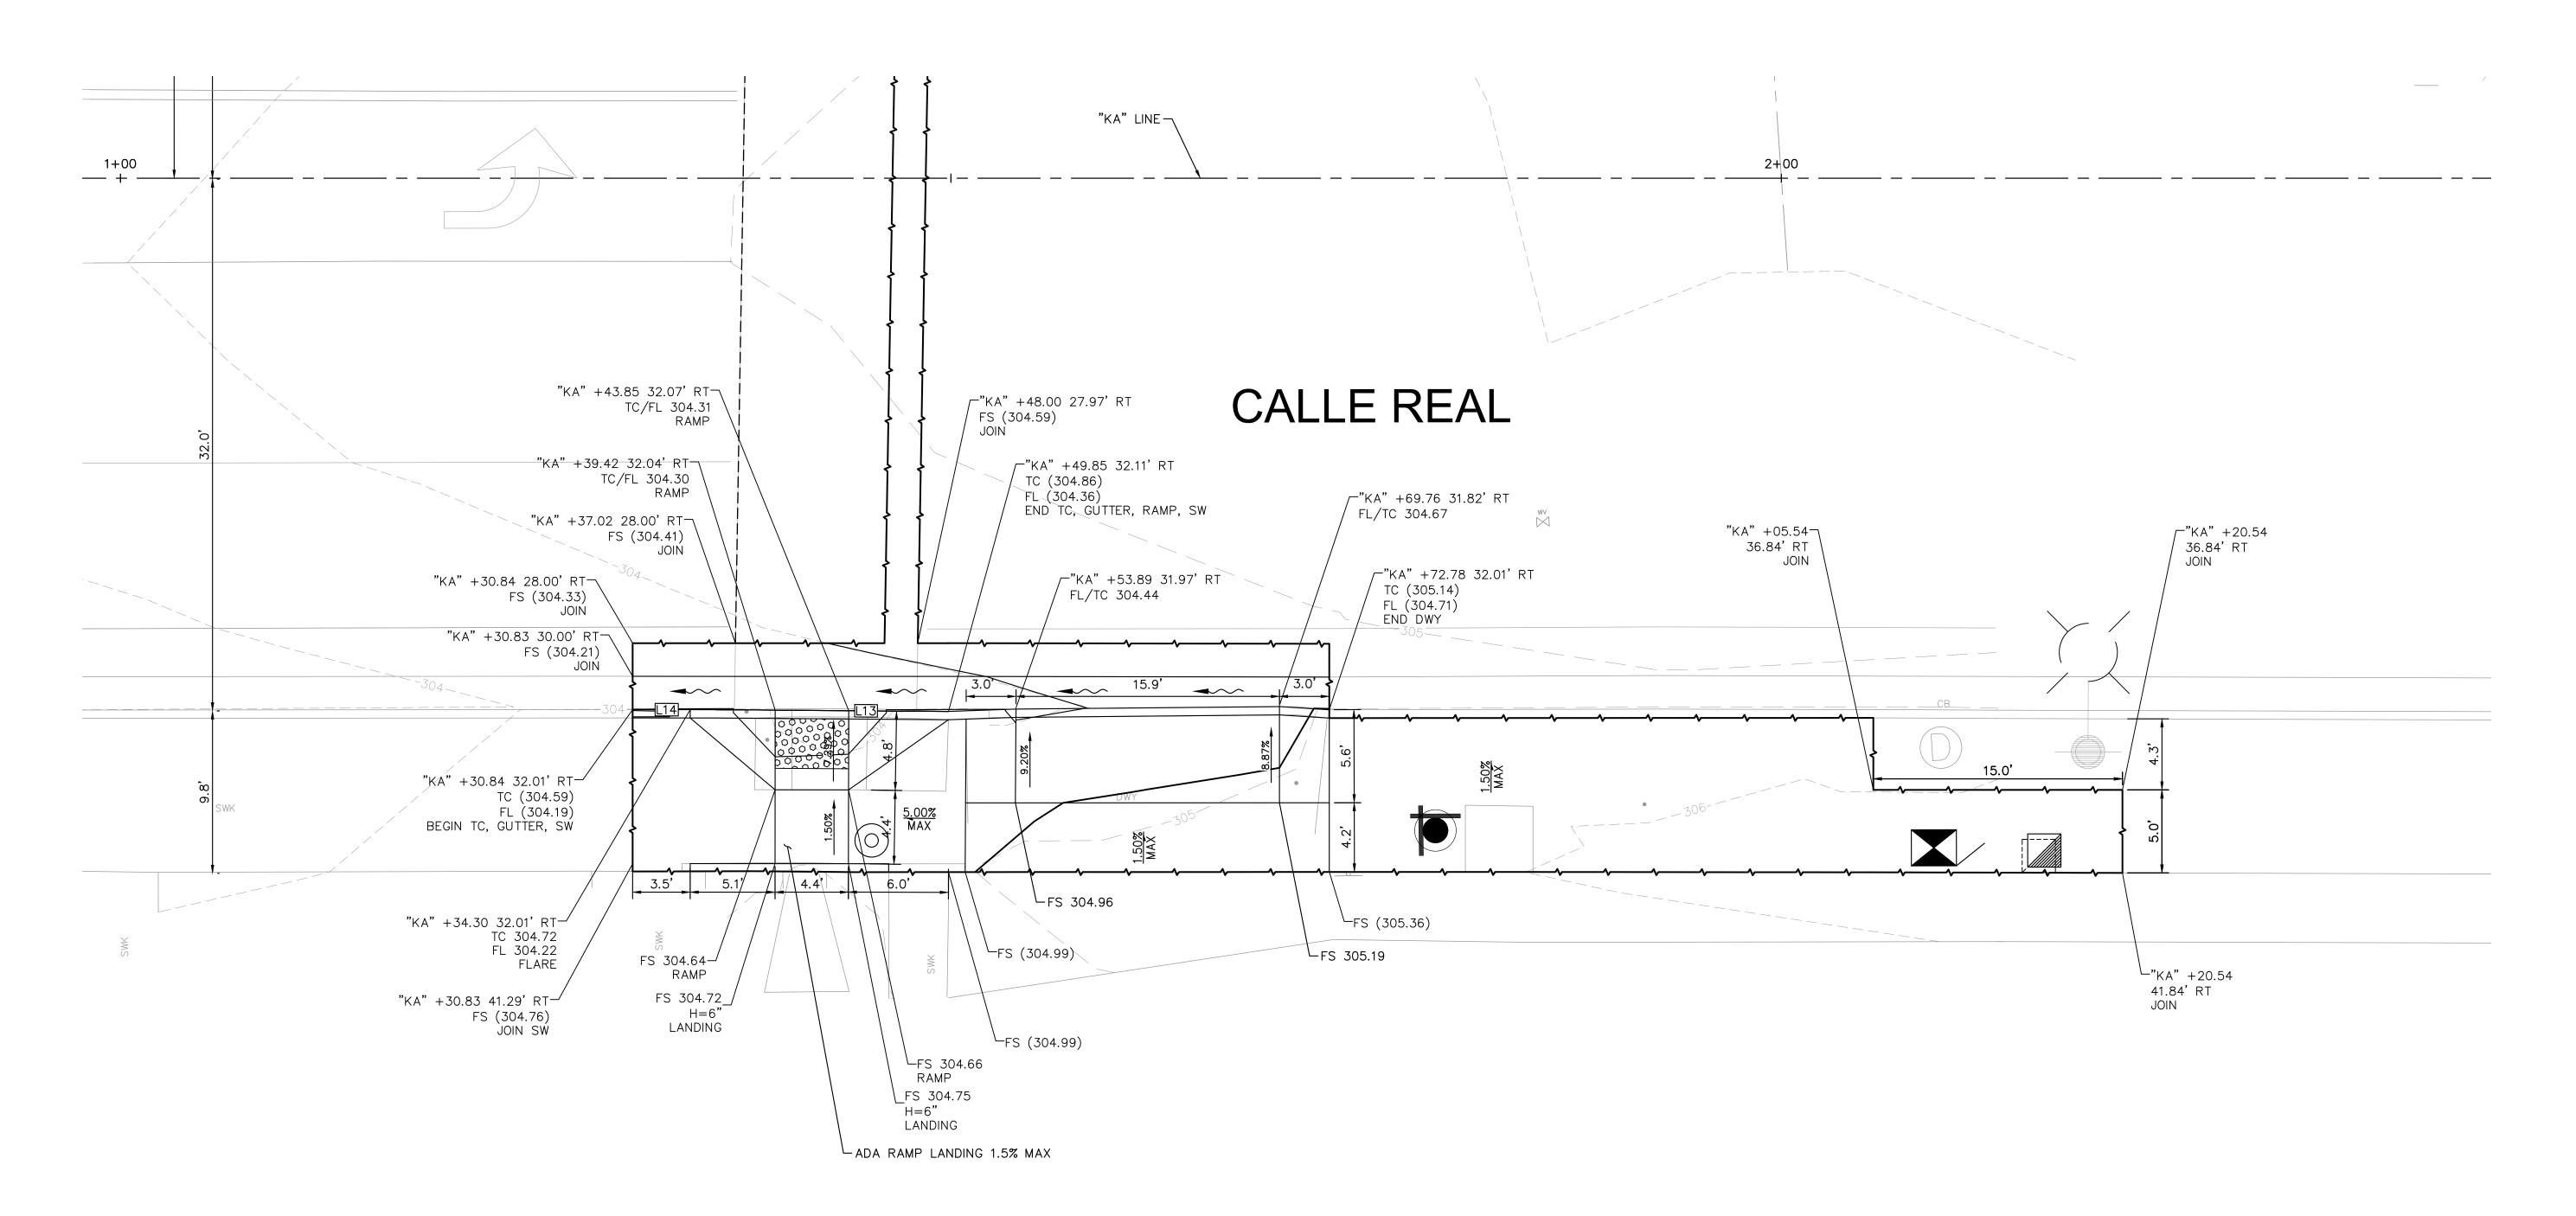







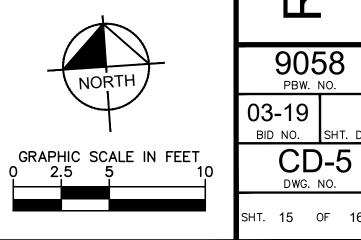


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PUBLIC WORKS DEPARTMENT ENGINEERING DIVISION

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	TYPE	III —B SERVICE EQUIPMENT	T ENCLO	SURE LEGEND (120/240	
ITEM	COMPONENT	NAMEPLATE DESCRIPTION	ITEM	COMPONENT	NAMEPLATE DESCRIPTION
1	NEUTRAL LUG		(4)	30 A, 240 V, 2P, CB	SIGN ILLUMINATION
2	LANDING LUG		(15)	100 A, 240 V, 2P, CB	MAIN BREAKER
3	TEST BYPASS FACILITY		(6)	30 A, 240 V, 2P, CB	LIGHTING
4	METER SOCKET AND SUPPORT		(7)	50 A, 120 V, 1P, CB	SIGNALS
(5)	TERMINAL BLOCKS		(18)	30 A, 120 V, 1P, CB	RAMP METERING
6	NEUTRAL BUS		19	20 A, 120 V, 1P, CB	IRRIGATION
(7)	GROUND BUS		20	15 A, 120 V, 1P, CB	LIGHTING CONTROL
8	GROUNDING ELECTRODE		21)	15 A, 1P, TEST SWITCH	IISNS TEST SWITCH
9	30 A, 2P, NO CONTACTOR	SIGN ILLUMINATION	22	15 A, 1P, TEST SWITCH	LIGHTING TEST SWITCH
10)	PHOTOELECTRIC UNIT (NOTE 4)	PEU	23	60 A, 2P, NO CONTACTOR	LIGHTING
(11)	15 A, 1P, TEST SWITCH	SIGN ILLUMINATION TEST SWITCH	24	15 A, 120 V, 1P, CB	IISNS
(12)	15 A, 120 V, 1P, CB	SIGN ILLUMINATION CONTROL	25	30 A, 2P, NO CONTACTOR	IISNS
(13)	15 A, 120 V, 1P, CB	FLASHING BEACON	26)	20 A, 120 V, IP, CB	TELEPHONE DEMARCATION CABINET
	,	•	27)	15 A, 120 V, 1P, CB	IISNS CONTROL

NOTES:

- 1. Unless otherwise indicated on the plans, service equipment items shall be provided for each service equipment enclosure as shown.
- 2. Connect to remote test switch mounted on lighting standards, sign post or structure when required.
- 3. Items 1) and 6) shall be isolated from the service equipment enclosure.
- 4. Type i photoelectric control shall be used unless otherwise indicated on the plans.
- 5. Item (12), (20) and (27) shall be ganged operated CB.

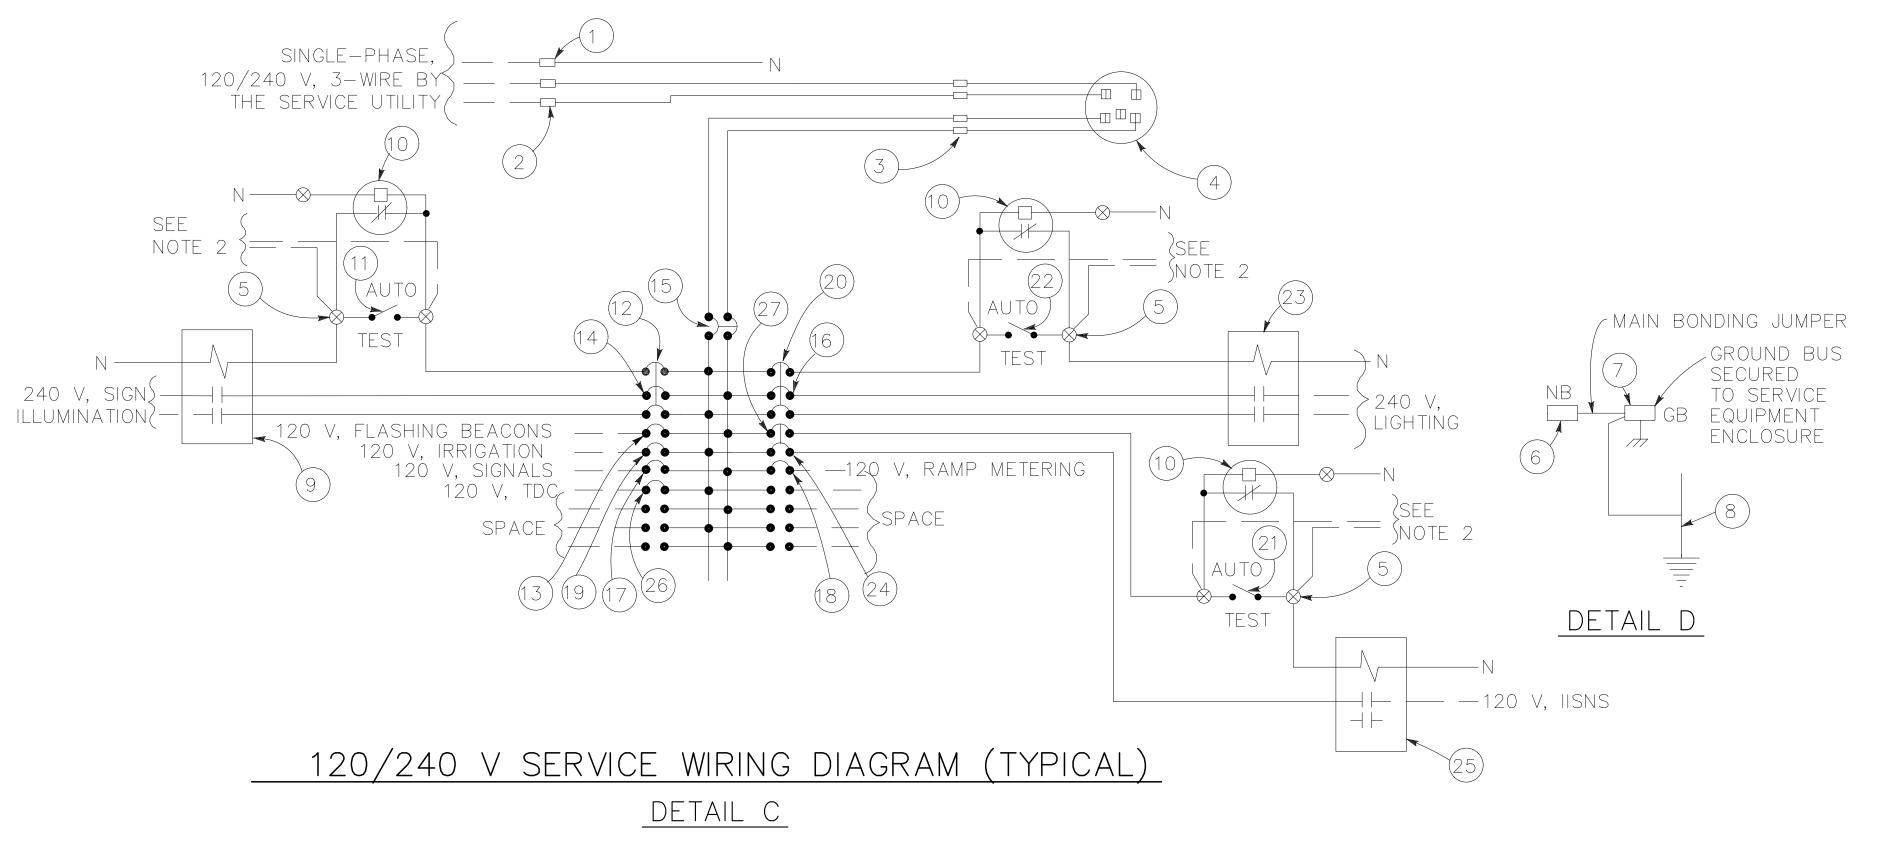







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PUBLIC WORKS
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ENGINEERING DIVISION

APPROVED:

DATE APPROVED DESIGN
DRAWN
CHECKED

100 %
CITY ENGINE

CITY OF GOLETA
CHAPEL, PHB KINGSTON
WIRING DIAGRAM

9058
PBW. NO.

03-19
BID NO. SHT. DES

W-1